TOTAL SITE AREA 2,996 SQ. FT. 0.069 ACRES

ALL BEARINGS ARE CALCULATED FROM ANGLES TURNED, AND ARE BASED ON SINGLE MAGNETIC READING TAKING IN FIELD.

THIS BLOCK RESERVED FOR COURT CLERK

ZONING:SPI-9 SA2

**BOUNDARY REFERENCES:** 

1. SUBJECT DEED BOOK 64154, PAGE 214 2. SEE ADJOINERS

ADDRESS(S)

3226 ROSWELL RD

ATLANTA, GEORIGA, 30305 FLOOD NOTE

AS PER THE F.I.R.M. FLOOD INSURANCE RATE MAP FULTON COUNTY COMMUNITY PANEL NO. 13121 C 0234 F DATED SEPTEMBER 18, 2013. THIS PROPERTY IS NOT IN AN AREA HAVING SPECIAL FLOOD HAZARDS.

EAST ANDREWS DR NW PK NAIL PK NAIL PK NAIL N/F ANDERSON CAMPBELL, LLC 3234 ROSWELL ROAD NW DB 53911, PG 392 N/F JACKSON C FLOYD JR 22 EAST ANDREWS DR Parcel ID:17 009900020574 MICAJAH PALMER POUND, LLC 3232 ROSWELL ROAD NW DB 59179, PG 491 PK NAIL . 1-STORY BUILDING N/F MICAJAH PALMER POUND, LLC 3230 ROSWELL ROAD NW PK NAIL (COMMERCIAL) DB 59179, PG 498 1" OTH (HELD)  $\Omega$ WELL N/F RAMONA TM BRUMBY JEROME P BRUMBY 3238 ROSWELL ROAD NW DB 58645, PG 698 D1-STORY BUILDING (COMMERCIAL) (BRICK) BEN MOSHAE FAMILY 3210 ROSWELL RD DEED BOOK: 47482/74

INSTRUMENT USED: TOPCON ES-150 (ROBOTIC/MOTORIZED) WORK PERFORMED ON MONTH 19, 2018.

THE DATA SHOWN ON THIS PLAT HAS BEEN CALCULATED FOR CLOSURE AND WAS FOUND TO BE ACCURATE WITHIN ONE FOOT IN 100,000+ FEET. THE FIELD DATA UPON WHICH THIS PLAT IS BASED HAS A CLOSURE PRECISION OF ONE FOOT IN 10,000+ FEET AND AN ANGULAR ERROR OF 5" PER ANGLE AND WAS ADJUSTED BY


THIS SURVEY WAS MADE WITHOUT THE BENEFIT OF A CURRENT TITLE COMMITMENT. EASEMENTS AND ENCUMBRANCES MAY EXIST WHICH BENEFIT AND BURDEN THIS PROPERTY.

COMPASS RULE.

THIS SURVEY ONLY INCLUDES OBJECTS THAT ARE VISIBLE AND IS NOT RESPONSIBLE FOR UNDERGROUND UTILITIES OR OTHER OBJECTS THAT ARE NOT APPARENT BY VISUAL OBSERVATION. I.E. UNDERGROUND GAS TANKS, GAS LINES, WATERLINES,

SURVEYOR'S CERTIFICATION

This plat is a retracement of an existing parcel or parcels of land and does not subdivide or create a new parcel or make any changes to any real property boundaries. The recording information of the documents, maps, plats, or other instruments which created the parcel or parcels are stated hereon. RECORDATION OF THIS PLAT DOES NOT IMPLY APPROVAL OF ANY LOCAL JURISDICTION, AVAILABILITY OF PERMITS, COMPLIANCE WITH LOCAL REGULATIONS OR REQUIREMENTS, OR SUITABILITY FOR ANY USE OR Purpose of the Land. Futhermore, the undersigned land surveyor certifies that this plat COMPLIES WITH THE MINIMUM TECHNICAL STANDARDS FOR PROPERTY SURVEYS IN GEORGIA AS SET FORTH IN THE RULES AND REGULATIONS OF THE GEORGIA BOARD OF REGISTRATION FOR PROFESSIONAL ENGINEERS AND LAND SURVEYORS AND AS SET FORTH IN THE O.C.G.A. SECTION 15-6-67.

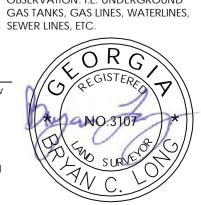

CRIMP TOP PIPE REBAR SIDEWALK LIGHTS DRAIN INLET SANITARY SEWER MANHOLE SAN. SEWER MANHOLE CLEANOUT WATER METER IRRIGATION CONTROL VALVE WATER VALVE GUY WIRE GEORGIA POWER MANHOLE LID TELE COMM. MANHOLE LID AIR CONDITIONER N/F NOW OR FORMERLY PERC. TEST (BOREHOLE) 4x4 TRANSFORMER RAIL ROAD TIE WALL

— x — x — FENCE — T — TELEPHONE LINE

—— G———— GAS LINE

PROPERTY LINE

- POWER LINE

FIRE DEPT. LINE

- SANITARY SEWER LINE

LEGEND

IRON PIN FOUND 1/2" REBAR SET CORRUGATED METAL PIPE

RIGHT OF WAY

PROPERTY LINE

LAND LOT LINE

POWER POLE

FIRE HYDRANT LIGHT POLE

GAS VALVE

BENCHMARK

IRON PIN FOUND

FLARED END SECTION

INVERT ELEVATION

TEMPORARY BENCHMARK

CENTER LINE


IPS CMP R/W

L.L.L. T.B.M.

INV. S

ICV

DEED BOOK 64154, PAGE 216 - LOT 12 DATE: 12/07/2023 SCALE: 1"= 20'

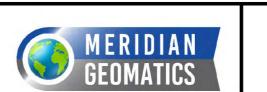

ALPHARETTA OFFICE 1875 LOCKEWAY DRIVE - SUITE 702 Alpharetta, Georgia 30004 Office: (770) 675-6197

DRWN BY D.C.D. JOB NO. 2023-195

RETRACEMENT BOUNDARY SURVEY for AYOTOKUNBO OMIDELE

TREE LEGEND

PINE TREE


Sag OAK TREE

PECAN TREE

EX. HARDWOOD TREE

REVISIONS:

LAND LOT 99 , 17th DISTRICT FULTON COUNTY, GEORGIA

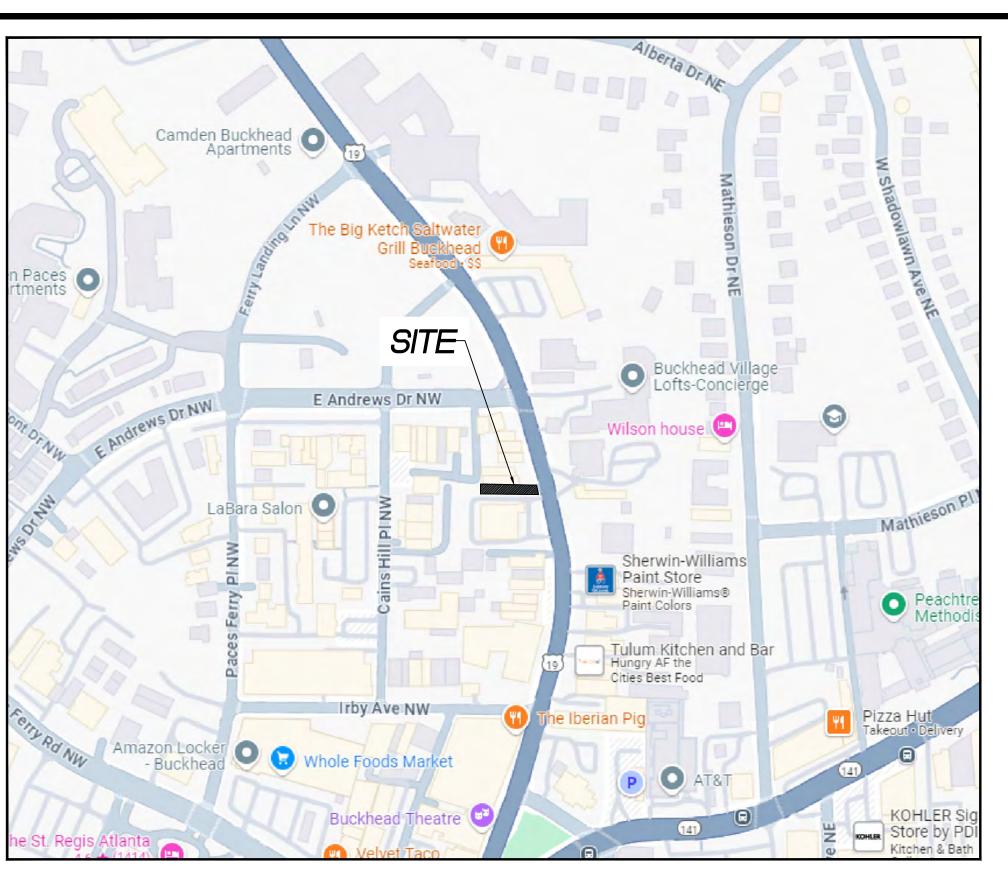

# VICINITY MAP



JACKSON Ć FLOYD JR

22 EAST ANDREWS DR





VIEW 2

# SITE NOTES

- 1. ALL WORK SHALL BE PERFORMED IN ACCORDANCE WITH THE PLANS AND SITE WORK SPECIFICATIONS AND SHALL COMPLY WITH APPLICABLE FEDERAL, STATE AND LOCAL
- 2. REFERENCE ARCHITECTURAL PLANS FOR BUILDING DIMENSIONS, SIDEWALKS, STEPS, TRANSFORMER PADS, ETC.
- 3. TOPOGRAPHIC BOUNDARY SURVEY, INCLUDING PROPERTY LINES, LEGAL DESCRIPTION, EXISTING UTILITIES, SITE TOPOGRAPHY WITH SPOT ELEVATIONS, OUTSTANDING PHYSICAL FEATURES AND EXISTING STRUCTURE LOCATIONS WAS PROVIDED BY THE FOLLOWING COMPANY, AS A CONTRACTOR TO THE SELLER/OWNER:

#### BOUNDARY & TOPOGRAPHY: MERIDIAN GEOMATICS

- 4. ALL DIMENSIONS AND RADII ARE TO THE FACE OF CURB, UNLESS OTHERWISE NOTED. ALL DIMENSIONS SHOWN TO BUILDINGS ARE TO OUTSIDE FACE OF BUILDING.
- 5. THE CONTRACTOR IS RESPONSIBLE FOR REPAIR OF ANY DAMAGE TO ANY EXISTING IMPROVEMENTS, ONSITE OR OFF SITE, SUCH AS PAVEMENT, UTILITIES, STORM DRAINAGE, ETC. THE REPAIR MUST BE APPROVED BY THE ENGINEER AND BE EQUAL OR BETTER THAN EXISTING CONDITIONS.
- 6. CONTRACTOR SHALL OBTAIN ALL PERMITS BEFORE CONSTRUCTION BEGINS. 7. SITE CONTRACTOR SHALL SUPPLY AS-BUILT PLANS INDICATING ALL CHANGES AND DEVIATIONS.
- 8. ANY DEVIATION FROM THESE PLANS MAY CAUSE THE WORK TO BE UNACCEPTABLE. 9. ANY UNANTICIPATED CONDITIONS ENCOUNTERED DURING THE CONSTRUCTION PROCESS
- SHALL BE IDENTIFIED TO THE ENGINEER IMMEDIATELY. 10. ALL CONCRETE SHALL BE MINIMUM 4,000 PSI 28 DAY COMPRESSIVE STRENGTH (SEE
- 11. THE OWNER/DEVELOPER IS RESPONSIBLE FOR OBTAINING ANY AND ALL OFF-SITE EASEMENTS NOT DELINEATED ON PLANS OR KNOWN OF AT TIME OF PLAN ISSUANCE.

# SITE LEGEND

EXISTING PROPERTY LINE EXISTING RIGHT-OF-WAY EXISTING SETBACK LINE PROPOSED RIGHT-OF-WAY PROPOSED SETBACK LINE 24" CURB AND GUTTER STORM MANHOLE SANITARY SEWER MANHOLE

STANDARD DUTY CONCRETE

HEAVY DUTY CONCRETE PAVING

# SITE AREA CALCULATIONS

= 2,996 SQ. FT. (0.07 AC) LOT SIZE = ±525 SQ. FT LIMITS OF DISTURBANCE EX. IMPERVIOUS AREA = 2,017 SF (0.04 AC.)-67.3% = 2,512 SF (0.05 AC.)-83.8% TOTAL PROP. IMPERVIOUS AREA NET IMPERVIOUS ADDITION = 495 SF (0.01 AC.)

# LOT COVERAGE CALCULATIONS

TOTAL EXISTING COVERED AREA = 2,017 SQ. FT. -EXISTING PAVEMENT, CONC. & ASPHALT = 1,290 SQ. FT -TOTAL EXISTING BUILDING AREA = 727 SQ. FT. TOTAL PROPOSED COVERED AREA = 2,667 SQ. FT. -EXISTING PAVEMENT, CONC. & ASPHALT = 1,290 SQ. FT -PROP. REAR PATIO = 650 SQ. FT..

NET DIFFERENCE = 650 SQ. FT.

# ZONING

CITY OF ATLANTA ZONED (SPI-9) SUB AREA 2 BUCKHEAD PARKING OVERLAY

# SETBACKS + STREETSCAPE REGULATIONS

= 727 SQ. FT.

2 + 2\* SPACES

FRONT YARD SETBACK SIDE YARD SETBACK NONE REAR YARD SETBACK N/A MAX. BLDG LOT COVERAGE N/A% AMENITY ZONE MIN WIDTH 5 FT WALK ZONE MIN. WIDTH 10FT STREET TREE PLANTING REQ. 40FT ON CENTER USEABLE OPEN SPACE REQ. NONE (<1 ACRE)

-TOTAL EXISTING BUILDING AREA

# PARKING REQUIREMENTS

EXISTING PARKING COUNT

PARKING ALLOWED (MAX): 1/300 SF OF FLOOR AREA + 1/600 SF OF OUTDOOR DINING AREA

EXISTING BUILDING FLOOR AREA: 727 SF TOTAL PROPOSED OUTDOOR/PATIO AREA 495 SF TOTAL PARKING REQUIRED 4 SPACES

\*THE REMAINDER 2 PARKING SPACES SHALL BE PROVIDED WITH SHARED PARKING AGREEMENT WITH ADJACENT OWNERS

# **DEVELOPER**

MR. SOUL, LLC 3226 ROSWELL RD NE, ATLANTA, GA 30305

CONTACT: AYOTOKUNBO SAMUEL OMIDELE EMAIL: samomidele@mrsoul.my

# TREE IMPACT

NO TREES ARE IMPACTED WITH THESE IMPROVEMENTS.

# TREE DENSITY

CONTACT: DARRELL JOHNSON

EMAIL: darrell@jdmconsultantsllc.com

CIVIL ENGINEER

JDM CONSULTANTS, LLC

P.O. BOX 366411

ATLANTA, GA 30336

PHONE: 205.266.1648

DENSITY REQUIRED: 90 IN/AC DENSITY REQUIRED: 7 IN DENSITY PRESERVED: 10 IN



**CONSTRUCTION MANAGEMENT** 

P.O. BOX 366411 ATLANTA, GA 30336 (205) 266-1648 darrell@jdmconsultantsllc.com jdmconsultantsllc@gmail.com

CLIENT:

THIS DRAWING IS THE PROPERTY OF JDM CONSULTANTS, LLC. IT IS ONLY TO BE USED FOR THE PROJECT AND LOCATION IDENTIFIED HEREIN. NO PART OF THIS DRAWING IS TO BE REPRODUCED. STORED IN A RETRIEVAL SYSTEM OR TRANSMITTED IN ANY FORM BY MEANS ELECTRONIC, MECHANICAL, PHOTOCOPYING OR OTHERWISE WITHOUT THE PRIOR PERMISSION OF JDM CONSULTANTS, LLC.

SEAL:



**REVISIONS:** 

NO. DATE DESCRIPTION

# **ROSWELL RD**

**3226 ROSWELL RD NE** ATLANTA GA 30305

LAND LOT 19, 17TH DISTRICT FULTON COUNTY, GA

SHEET TITLE:

# SITE PLAN

DESIGNED BY: DRAWN BY: CHECKED BY: APPROVED BY: JDM


**AS SHOWN** SCALE:

10-15-2024 PROJECT NO .:

24-280 SHEET:

1 of 1



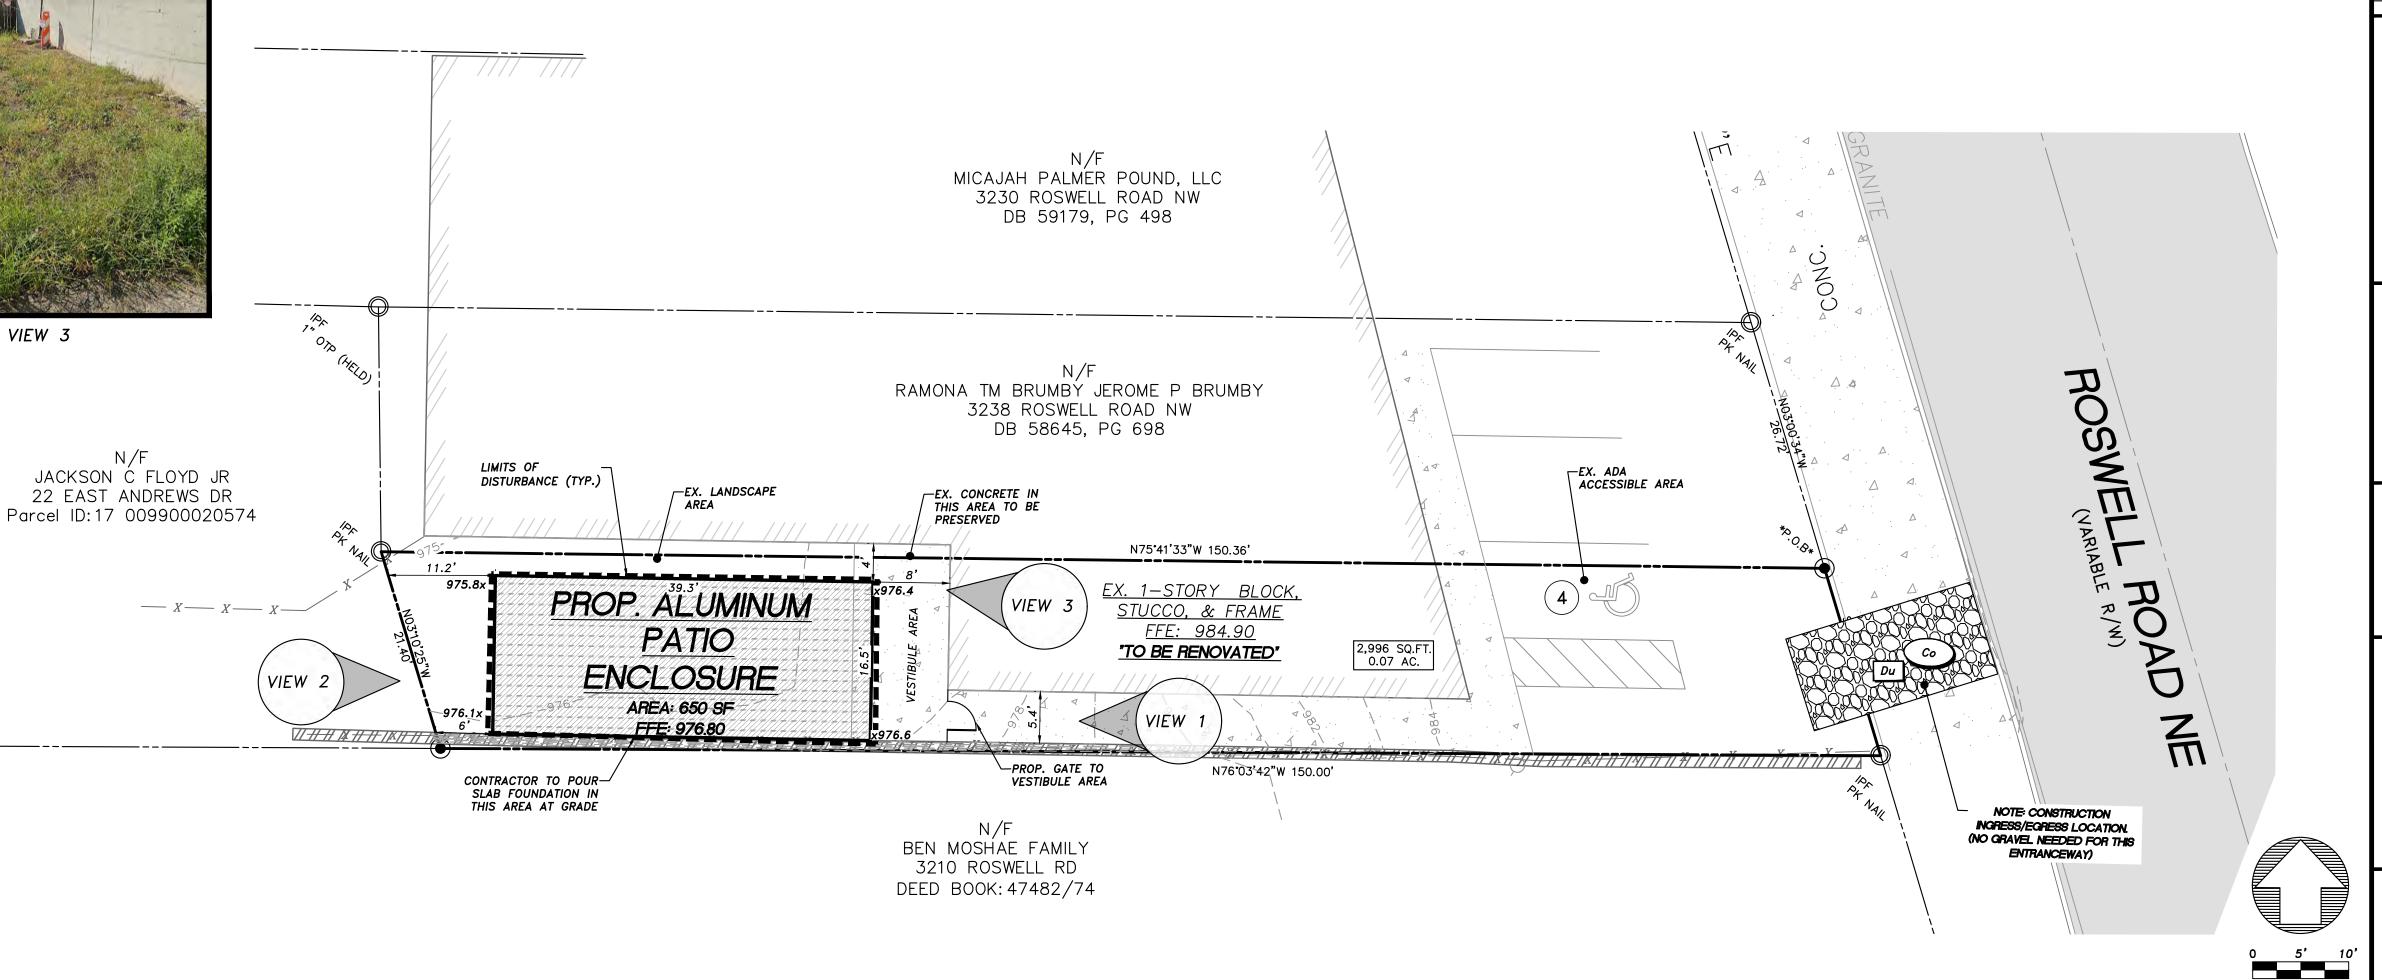

# BACKYARD by MR. SOUL RESTAURANT RENOVATION & NEW PATIO ENCLOSURE 3226 ROSELL RD N.W. ATLANTA, GA 30305-1839



0

As No DRAWN BY: CALE:

SSUED

CONSTRUCTION

TENANT, MR. SOUL LLC

ADDRESS: 3226 ROSWELL RD NW ATLANTA, GA 30305-1839 EMAIL: SAMOMIDELE@MRSOUL,MY PHONE: 469-494-4177

CONTRACTOR: SAMKINS CONSTRUCTION INC

CONTACT: SAMUEL AKINROTIBA

ADDRESS: 7051 W STRICKLAND ST DOUGLASVILLE GA

PHONE NUMBER: 678-361-7419

VICINITY MAP

EMAIL: PROJECTS@SAMKINSCONSTRUCTION.COM

DESIGN PROFESSIONAL: TAD ARCHITECTS CONTACT: HENRI TCHAYA

ADDRESS

EMAIL: TAD ARCHITECTS@BELLSOUTH.NET

PHONE:

#### APPLICABLE CODES

THE CURRENT STATE MINIMUM STANDARD CODES

THE FOLLOWING ARE THE CURRENT STATE MINIMUM STANDARD CODES FOR CONSTRUCTION AS ADOPTED BY THE BOARD OF COMMUNITY AFFAIRS.

CURRENT MANDATORY CODES AS ADOPTED BY DCA:

- INTERNATIONAL BUILDING CODE, 2018 EDITION, WITH GEORGIA AMENDMENTS (2020), (2022).
- INTERNATIONAL RESIDENTIAL CODE, 2018 EDITION, WITH GEORGIA AMENDMENTS (2020), (2024 INTERNATIONAL FIRE CODE, 2018 EDITION (CONTACT STATE FIRE MARSHAL BELOW)
- INTERNATIONAL PLUMBING CODE, 2018 EDITION, WITH GEORGIA AMENDMENTS (2020), (2022),
- INTERNATIONAL MECHANICAL CODE 2018 EDITION WITH GEORGIA AMENDMENTS (2020). (2024
- INTERNATIONAL FUEL GAS CODE, 2018 EDITION, WITH GEORGIA AMENDMENTS (2020), (2022)
- NATIONAL ELECTRICAL CODE, 2020 EDITION, WITH GEORGIA AMENDMENTS (2021)
- INTERNATIONAL ENERGY CONSERVATION CODE, 2015 EDITION, WITH GEORGIA SUPPLEMENTS AND AMENDMENTS (2020), (2022), (2023)
- INTERNATIONAL SWIMMING POOL AND SPA CODE, 2018 EDITION, WITH GEORGIA AMENDMENTS
- NEPA 101 / LIFE SAFETY CODE 2018 EDITION WITH GA FIRE MARSHAL MODIFICATIONS 120-3-3
- INTERNATIONAL FIRE CODE, 2018 EDITION, WITH GA FIRE MARSHAL MODIFICATIONS, 120-3-3,
- GEORGIA ACCESSIBILITY CODE 120-3-20 (.01-.08)

(FOR INFORMATION AND QUESTIONS REGARDING THE LIFE SAFETY CODE (NFPA 101), IFC GEORGIA AMENDMENTS OR THE GEORGIA ACCESSIBILITY CODE PLEASE CONTACT THE STATE FIRE MARSHAL'S OFFICE.)

CURRENT PERMISSIVE CODES AS ADOPTED BY DCA:

DISASTER RESILIENT BUILDING CODE IBC APPENDIX(2013)

DISASTER RESILIENT BUILDING CODE IRC APPENDIX (2013)

INTERNATIONAL PROPERTY MAINTENANCE CODE, 2018 EDITION, WITH GEORGIA AMENDMENTS

INTERNATIONAL EXISTING BUILDING CODE, 2018 EDITION, WITH GEORGIA AMENDMENTS (2021) NATIONAL GREEN BUILDING STANDARD, 2008 EDITION, WITH GEORGIA AMENDMENTS (2011)

# NEIGHBORHOOD MAR 0

I. REPAIR & RENOVATION OF INTERIOR WITH REPLACEMENT IN-KIND OF WALL & CEILING PAINT, COUNTER FINISHES AND FLOORING.

2. REPAIR & RENOVATION OF ROOF WITH REPLACEMENT IN-KIND OF TPO ROOFING.

3. NEW ALUMINUM PATIO ENCLOSURE (UN-CONDITIONED) ON SLAB-ON-GRADE, AND STRUCTURAL SUPPORT.

4. NO NEW MECHANICAL OR PLUMBING

#### ZONING DATA

COUNTY: FULTON

PARCEL ID / TAX ID: 17 009900020509

ACCOUNT NUMBER: 2098848

DISTRICT WARD: CITY OF ATLANTA

2020 CENSUS TRACT / BLK: 95.04 / 1

ASSESSOR ROLL: 2022

PROPERTY TYPE: COMMERCIAL

LAND USE: DOWNTOWN ROW TYPE BUILDING IMPROVEMENT TYPE: DOWNTOWN ROW TYPE BUILDING

CITY COUNCIL DISTRICT: 8

NPU: B

NEIGHBPRHOOD: SOUTH TUXEDO PARK

ZONING CLASSIFICATION: SPI-9 SA2

#### BUILDING CODE DATA

OCCUPANCY CLASSIFICATION: ASSEMBLY / A-2 CONSTRUCTION TYPE: III-B (UN-PROTECTED) SPRINKLER: NO

HEIGHT: 14'-O" (FRONT FACADE)


STORIES: I STOREY (WALK-OUT BASEMENT)


EXISTING AREA: 1472 SF (MAIN FL: 736 SF, LOWER FL: 736 SF) ADDITIONAL PROPOSED PATIO AREA: 630 SF

OCCUPANT LOAD: TI OCCUPANTS

RD BACKYARD ROSWELL

3226

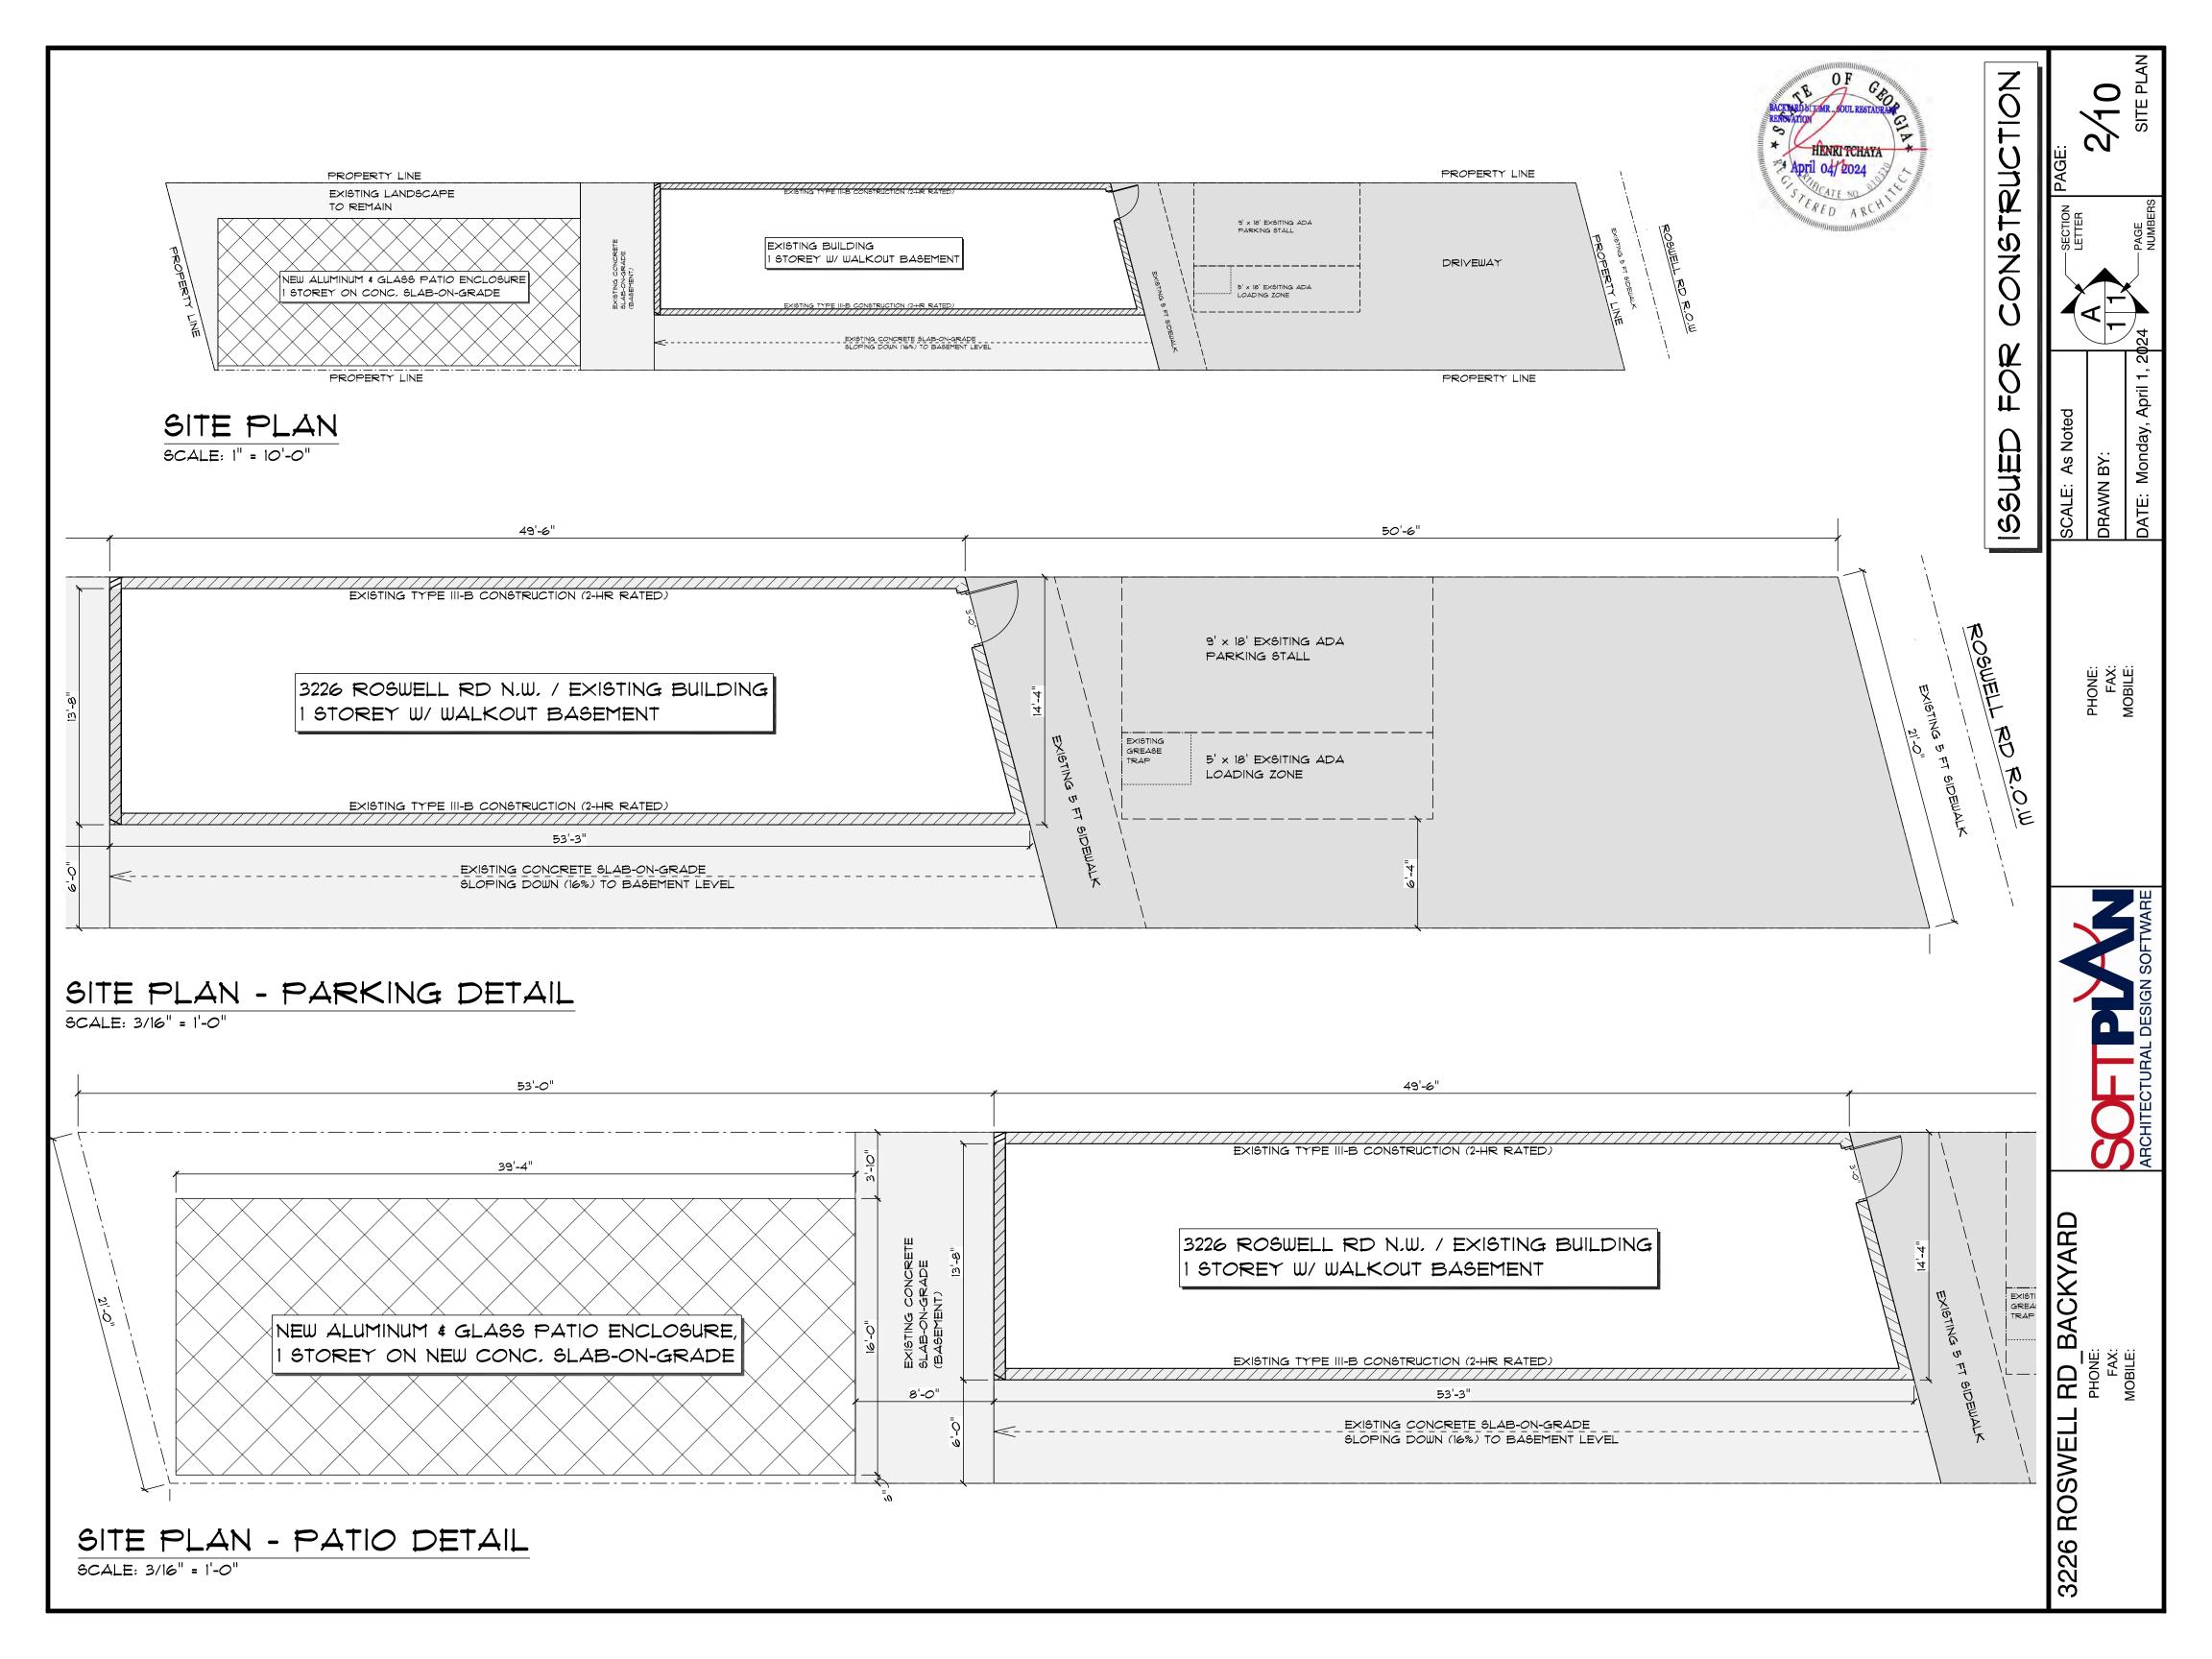

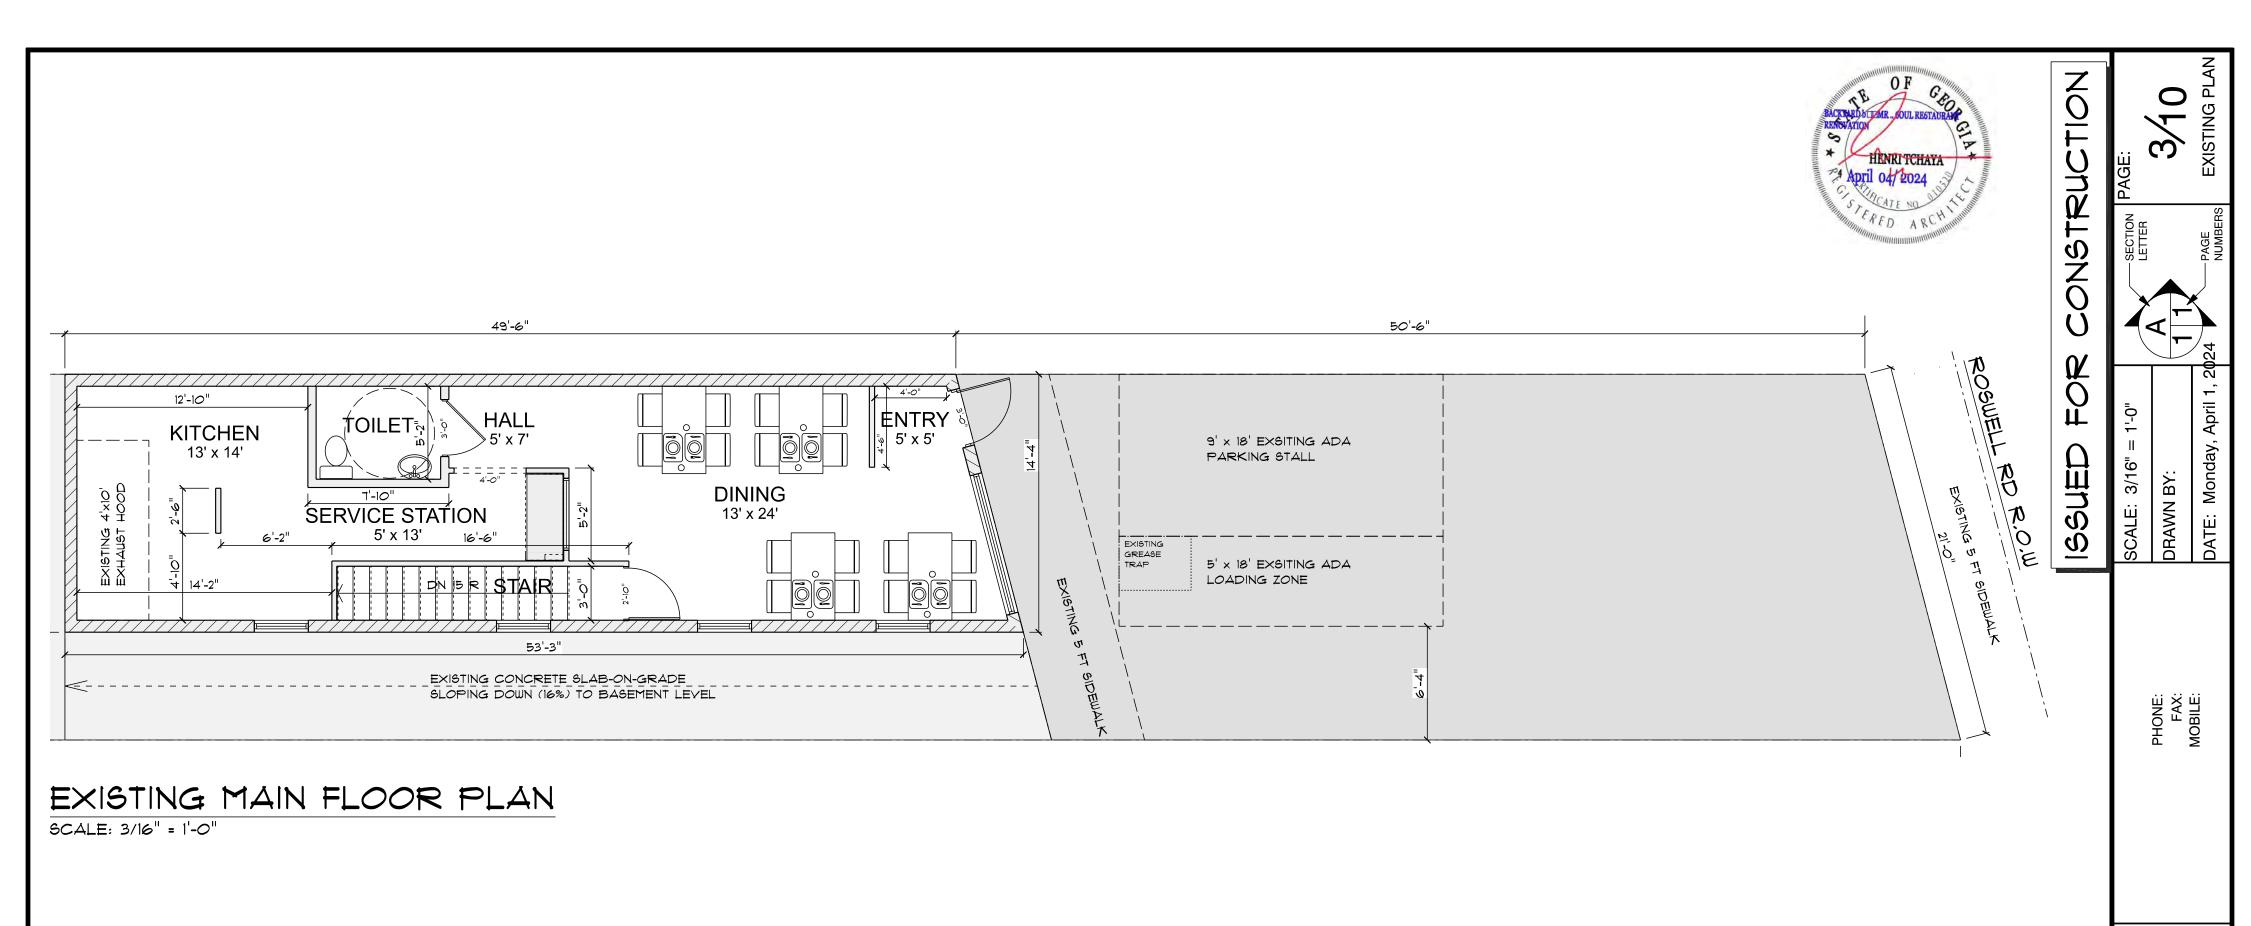

53'-0" 49'-6" 8'-0" 6'-4" TOILET FREEZER, COOLER OFFICE 6' x 6' STORAGE 10' x 20' 8' x 9' EXISTING CONCRETE FLAT SLAB-ON-GRADE (BASEMENT) 17'-2" EXISTING LANDSCAPE HALL 9'-3 11/16" HALL 7' x 9' ⇒ STAIR 9'-0" 53'-3" EXISTING CONCRETE SLAB-ON-GRADE SLOPING UP (16%) TO MAIN LEVEL

# EXISTING BASEMENT PLAN


SCALE: 3/16" = 1'-0"

SOFTWARE ARCHITECTURAL DESIGN SOFTWARE

3226 ROSWELL RD\_BACKYARD
PHONE:
FAX:
MOBILE:




# CONSTRUCTION

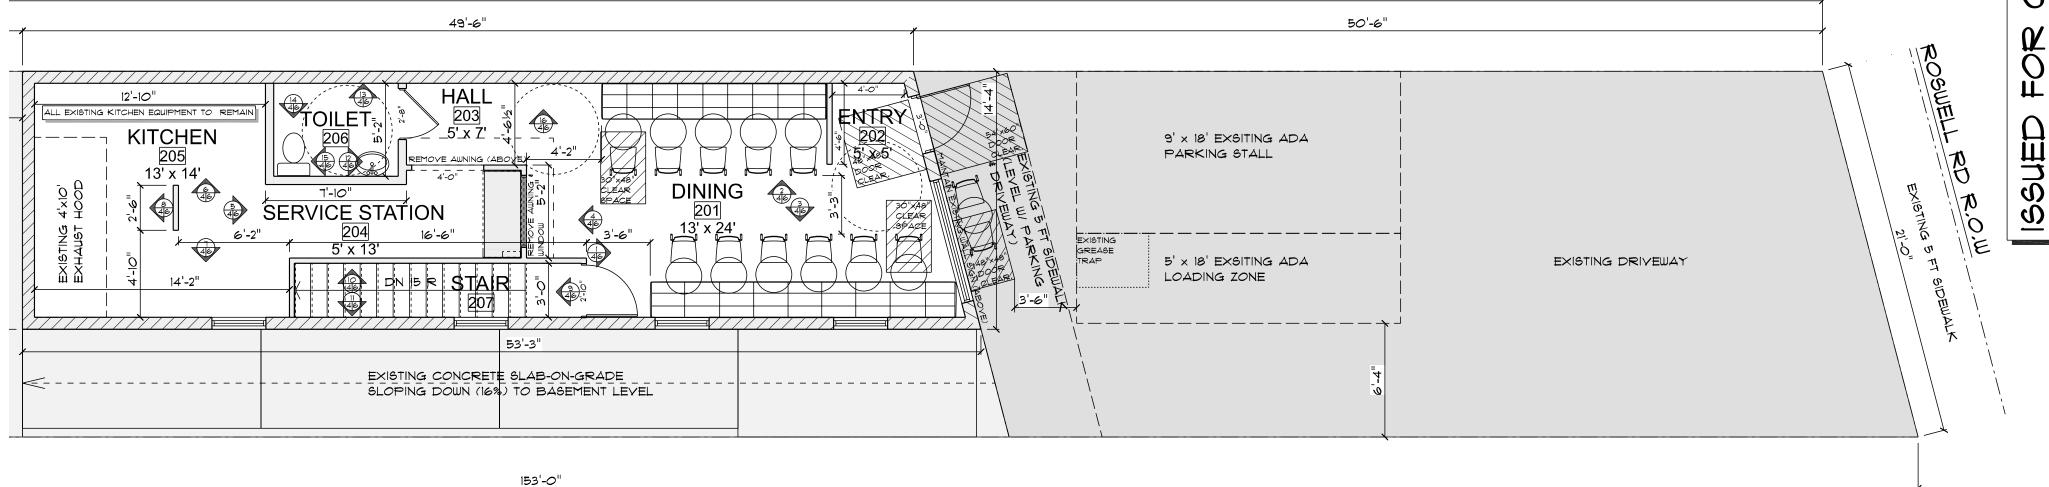

# PROPOSED MAIN FLOOR PLAN

153'-0"

SCALE: 3/16" = 1'-0"

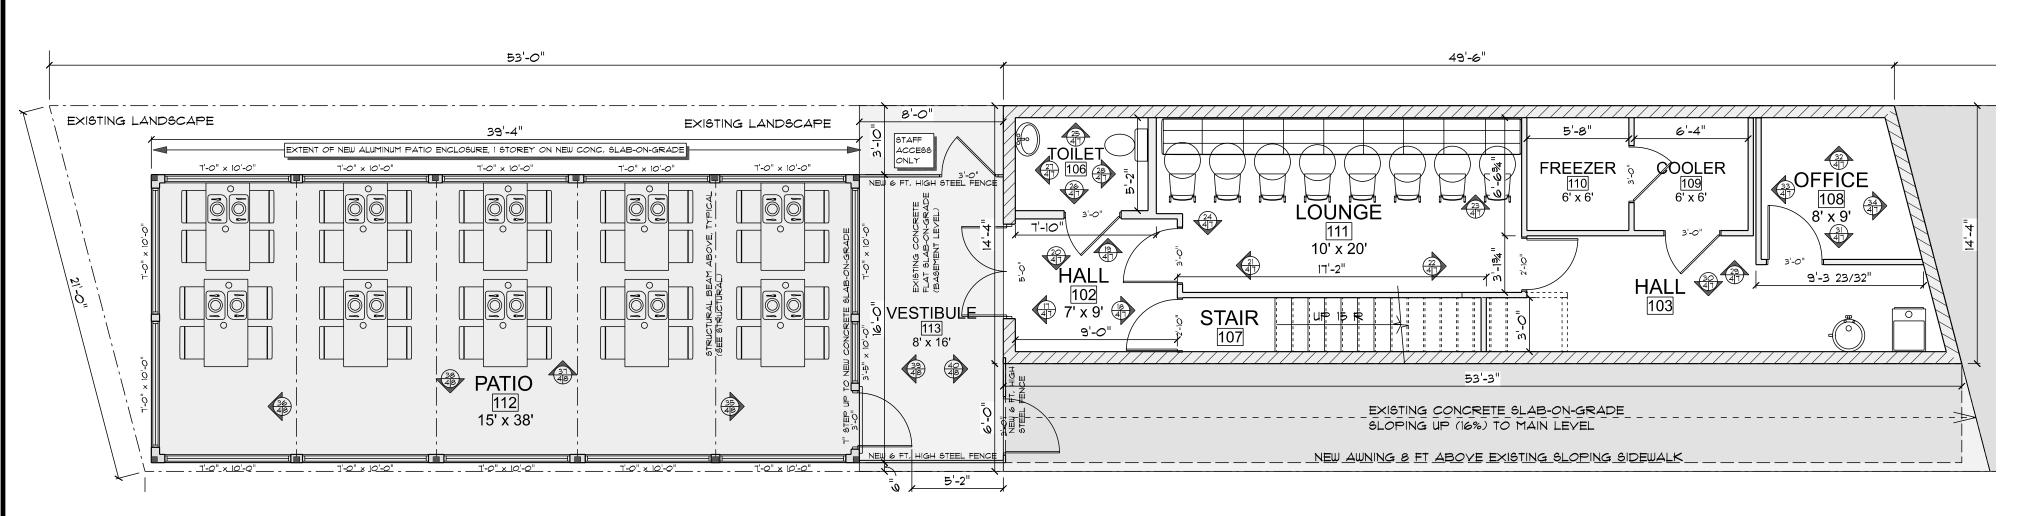

# PROPOSED BASEMENT PLAN

SCALE: 3/16" = 1'-0"


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Monday,

DRAWN BY:

SCALE:


3226 ROSWELL RD\_BACKYARD
PHONE:
FAX:
MOBILE:




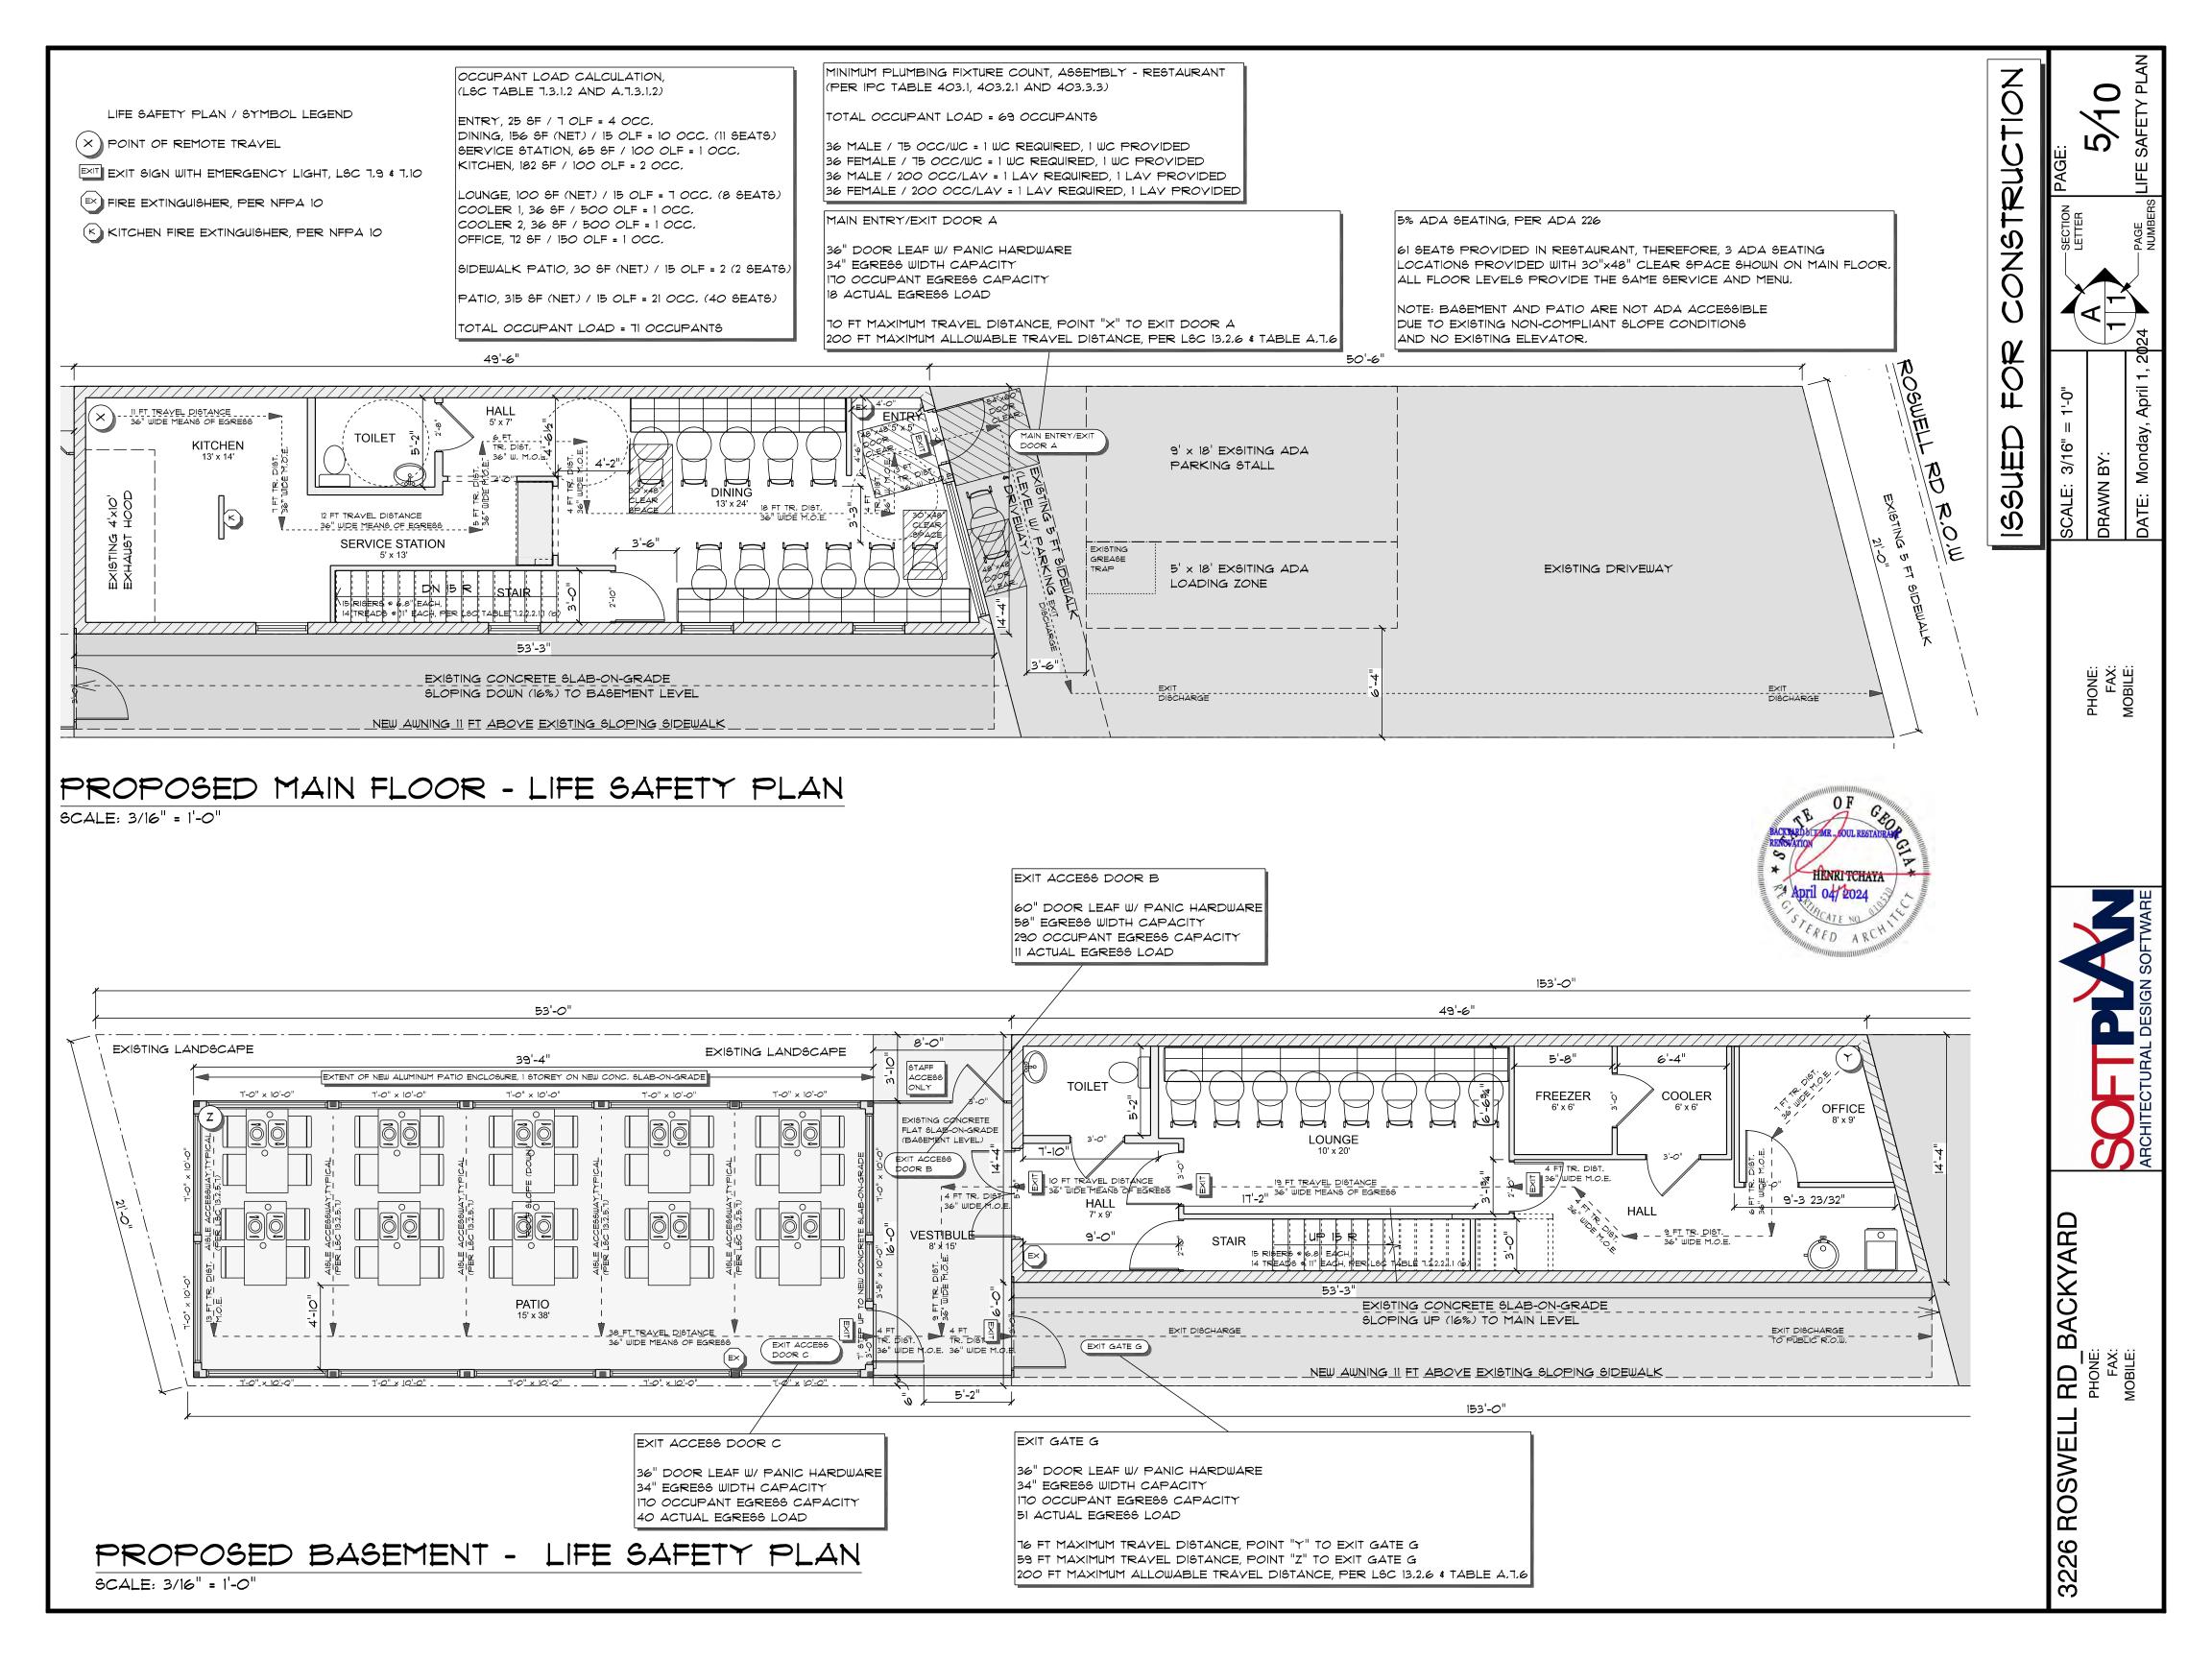



SCALE: 1/4" = 1'-0"

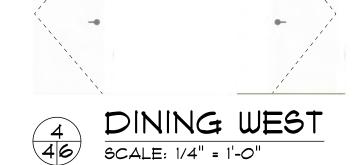

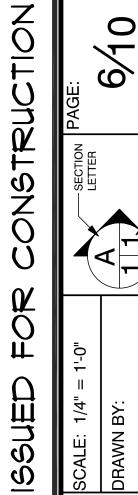

OORGENTERIOR ELEVATIONS

DATE: Monday, April 1, 20

PHONE: FAX: MOBILE:

KITCHEN FAS

SCALE: 1/4" = 1'-0"




SCALE: 1/4" = 1'-0"









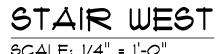




STAIR NORTH 6CALE: 1/4" = 1'-0"






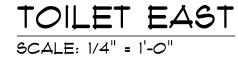



TOILET NORTH SCALE: 1/4" = 1'-0"

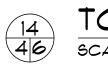

TOILET SOUTH SCALE: 1/4" = 1'-0"



TOILET WEST SCALE: 1/4" = 1'-0"






3226 ROSWELL RD\_BACKYARD
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MOBILE:

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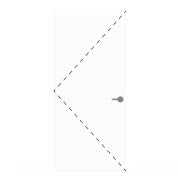



SCALE: 1/4" = 1'-0"



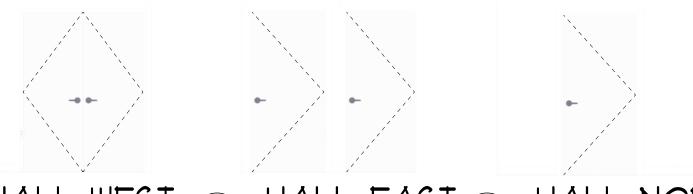





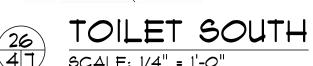











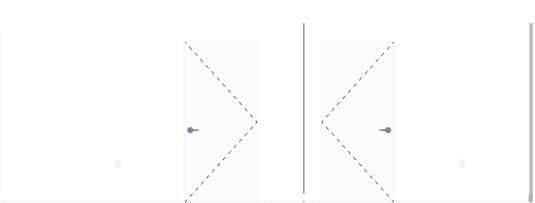



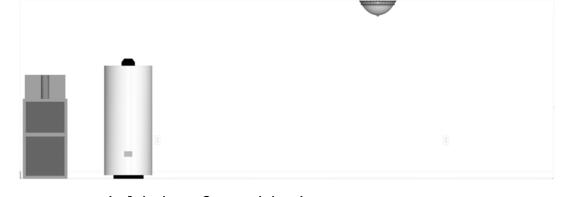









OFFICE NORTH

SCALE: 1/4" = 1'-0"


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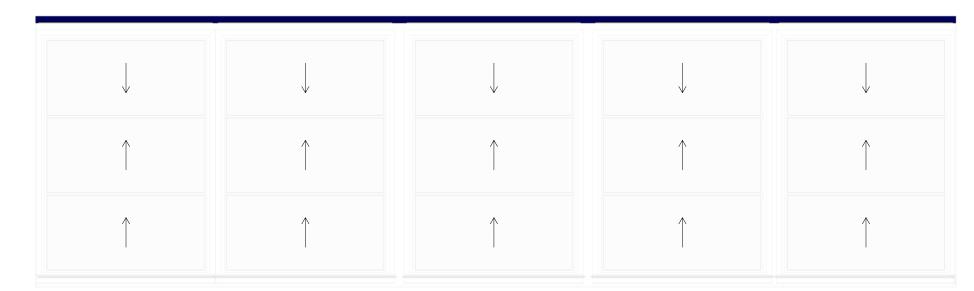
U)#



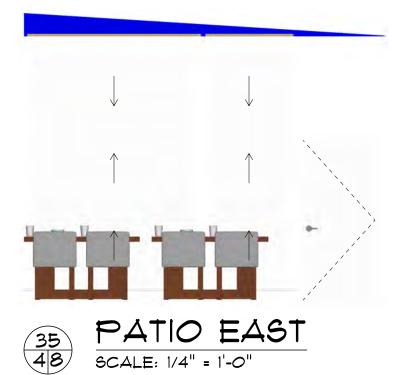


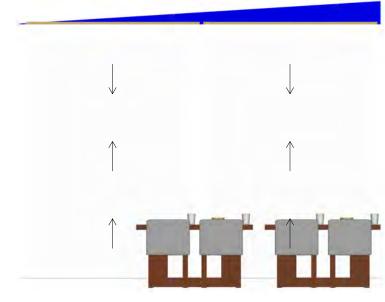




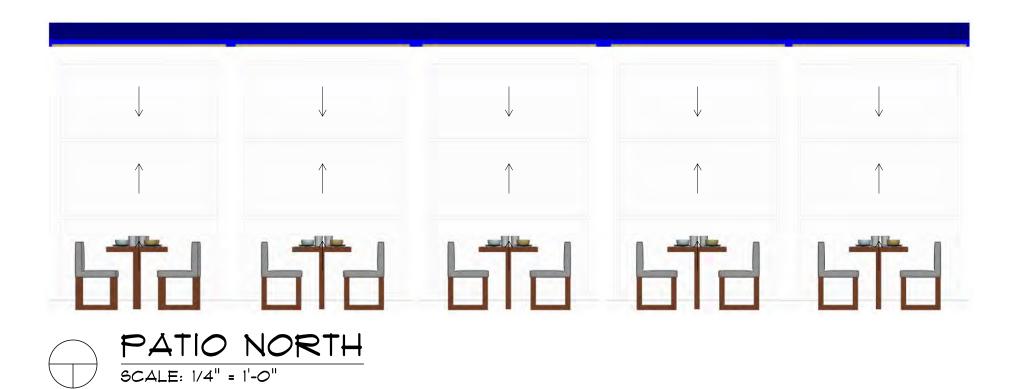





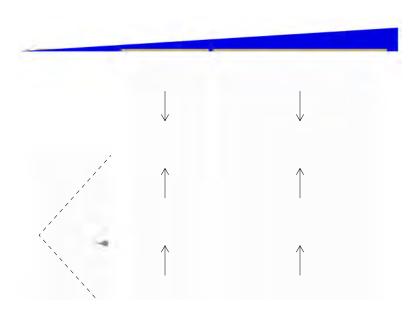



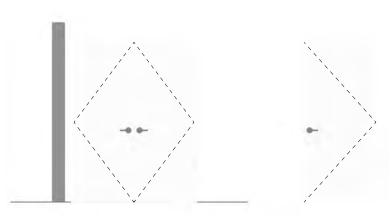

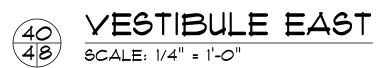

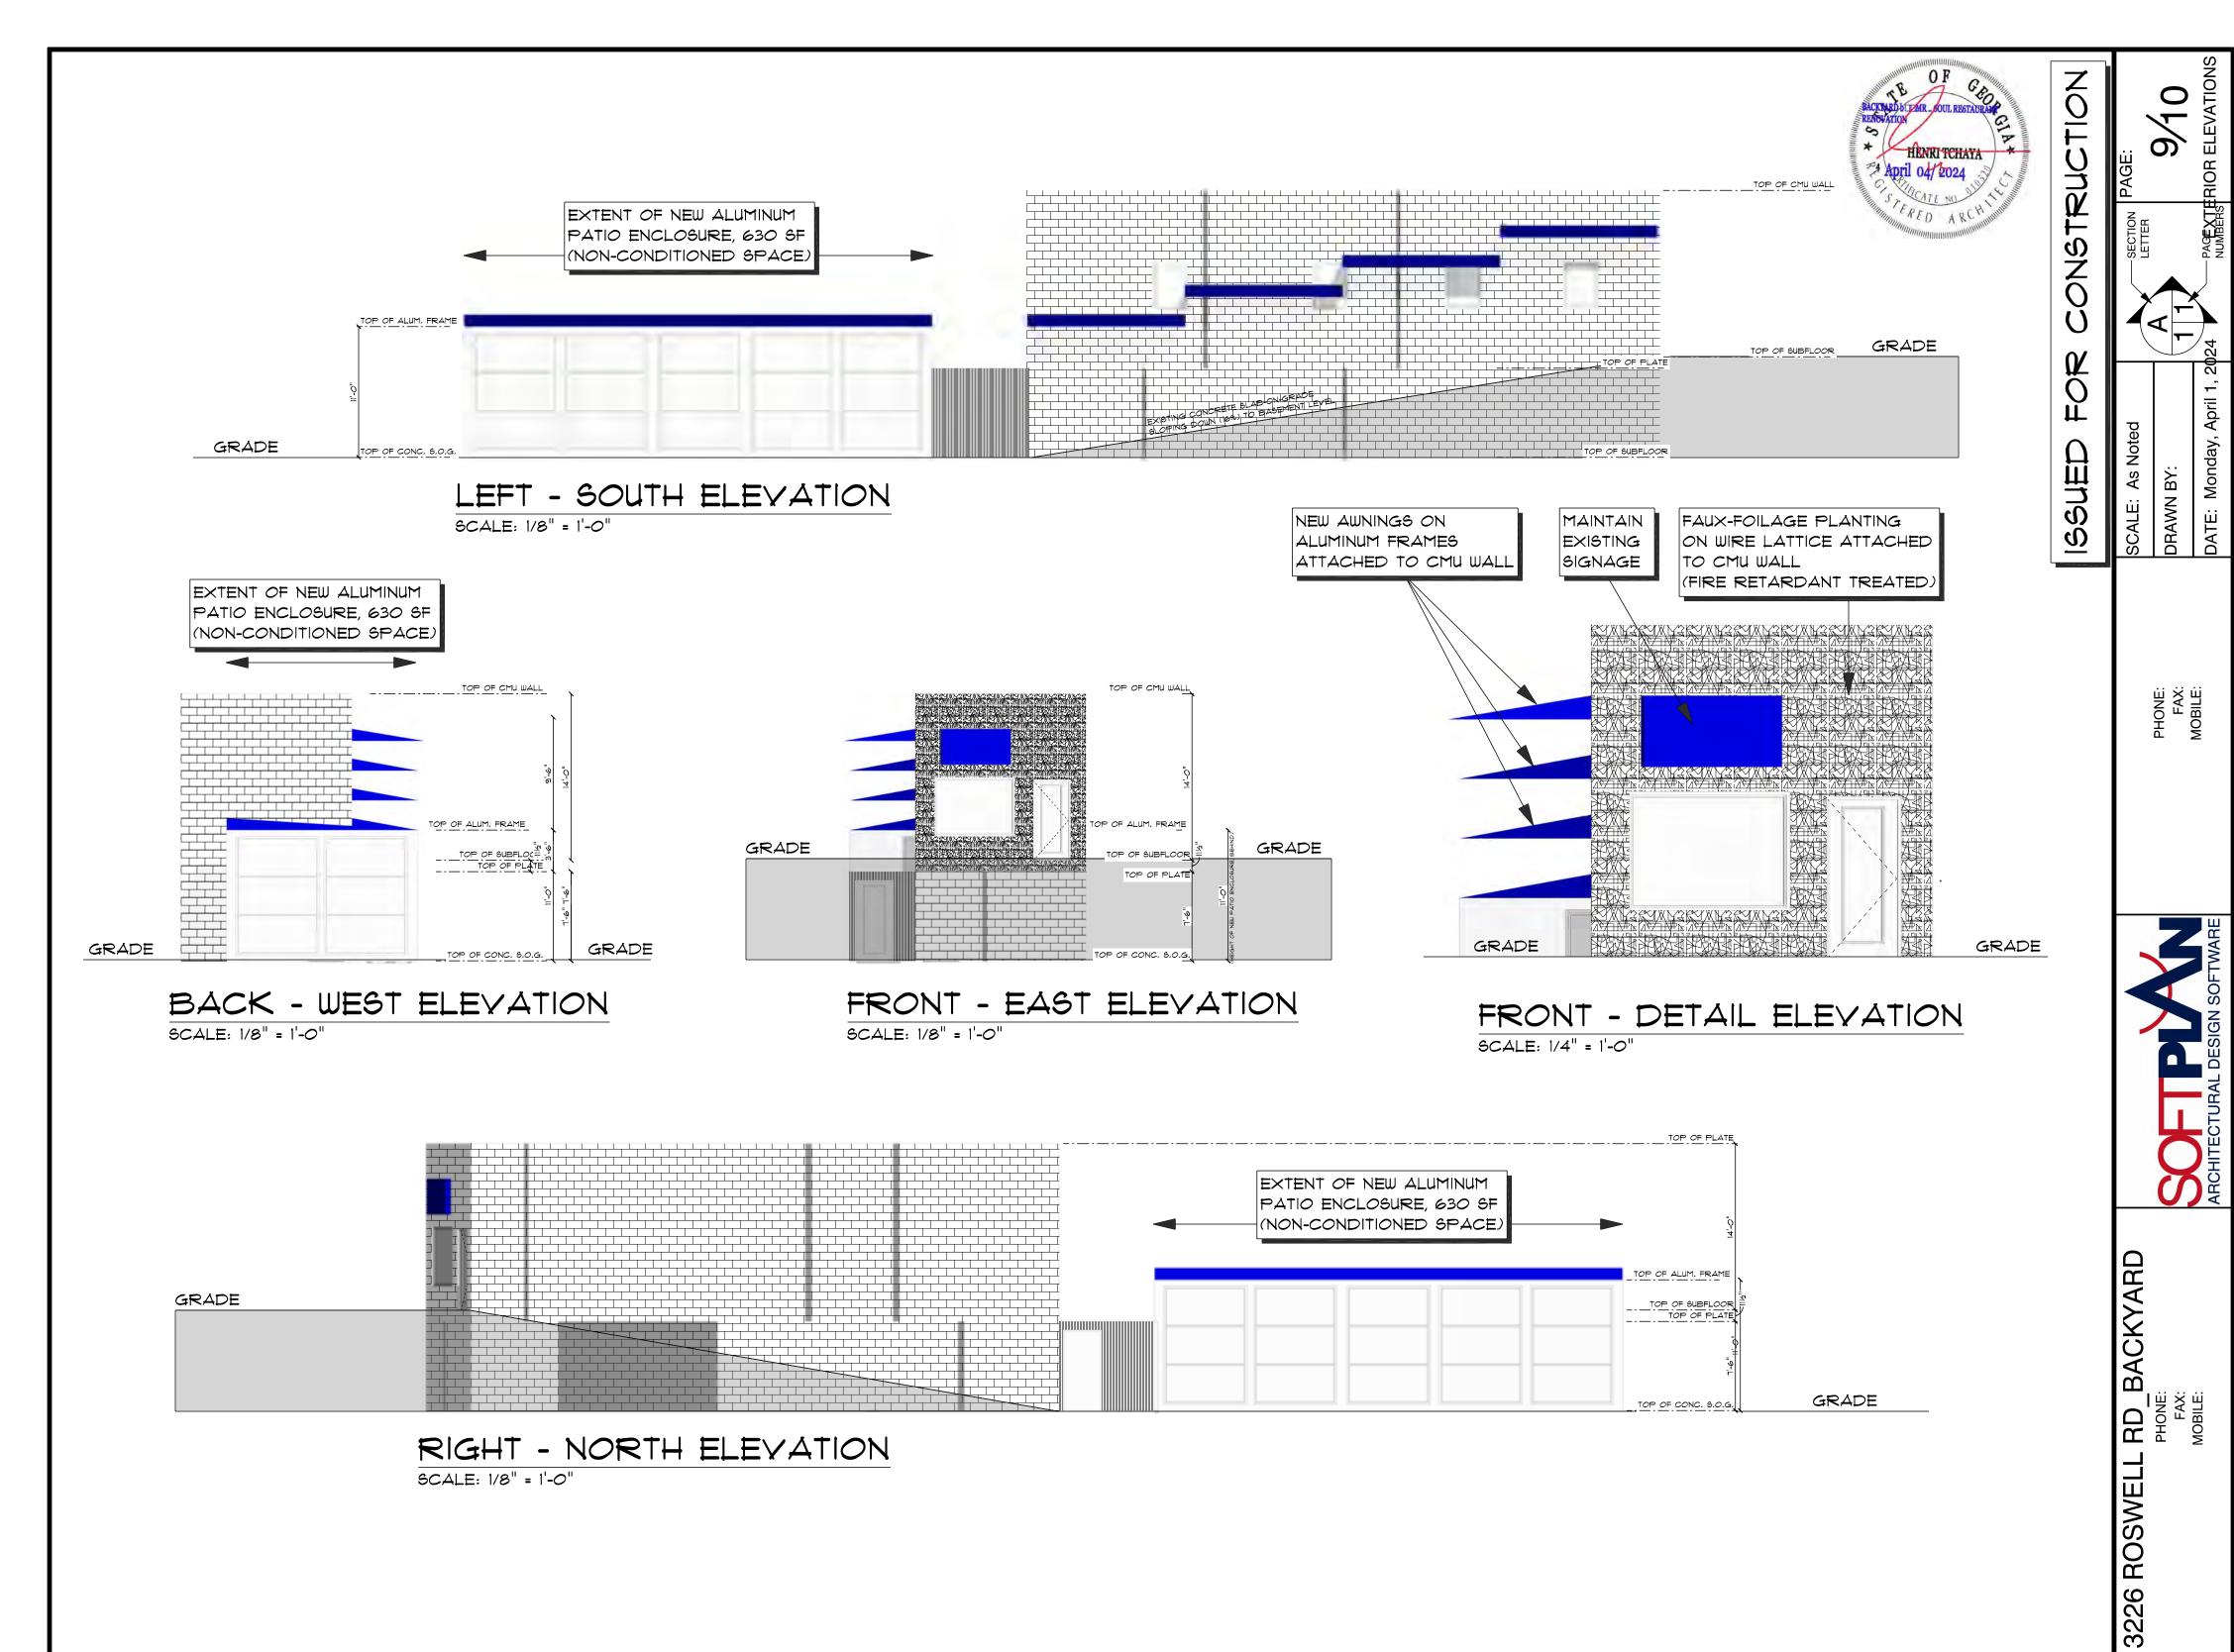

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3226 ROSWELL RD\_BACKYARD
PHONE:
FAX:
MOBILE:

# ALL EXISTING & NEW FINISHES COMPLY WITH INTERIOR FINISH CLASSIFICATIONS, PER LSC 13.3.3, TABLE A.10.2.2 AND 43.4.1.3 .

DOOR SCHEDULE										
ROOM SCHEDULE ID	OPENING ID	SIZE	HARDWARE	COMMENT	COUNT					
202	Α	3'-0"	PANIC HARDWARE	MAIN ENTRY / EXIT	1					
207	В	2'-10"	LEVER FLAT	STAIR	1					
203	D	2'-8"	LEVER FLAT	TOILET	1					

	WINDOW SCHEDULE										
ROOM SCHEDULE ID	<b>OPENING ID</b>	SIZE	COMMENT	COUNT							
201	1	3'-0" x 3'-0"	SIDE WINDOWS	2							
205	1	3'-0" x 3'-0"	KITCHEN WINDOW	1							
207	1	3'-0" x 3'-0"	STAIR WINDOW	1							
204	2	4'-0" x 3'-0"	TAKE-OUT WINDOW	1							
201	3	8'-0" x 4'-0"	FRONT WINDOW	1							

	ROOM FINISH SCHEDULE										
SCHEDULE I	D ROOM NAME	FLOORING FLOORING COMMENT	<b>BASEBOARD</b>	<b>BASEBOARD</b>	<b>COMMENT WALLCOVERING</b>	WALLCOVERING	G COMMENT CEILING FINISH	CEILING (	COMMENT CEILING HEIGHT		
201	DINING	Hardwood 1EXISTING	1x4 PAINTED WOOD	EXISTING	Paint 1	EXISTING	Painted	EXISTING	10'-0"		
202	ENTRY	Hardwood 1EXISTING	1x4 PAINTED WOOD	EXISTING	Paint 1	EXISTING	Painted	EXISTING	10'-0"		
203	HALL	Hardwood 1EXISTING	1x4 PAINTED WOOD	EXISTING	Paint 1	EXISTING	Painted	EXISTING	10'-0"		
205	KITCHEN	Hardwood 1EXISTING	1x4 PAINTED WOOD	EXISTING	Paint 1	EXISTING	Painted	EXISTING	10'-0"		
204	SERVICE STATION	Hardwood 1EXISTING	1x4 PAINTED WOOD	EXISTING	Paint 1	EXISTING	Painted	<b>EXISTING</b>	10'-0"		
207	STAIR	Hardwood 1EXISTING	1x4 PAINTED WOOD	EXISTING	Paint 1	EXISTING	Painted	EXISTING	10'-0"		
206	TOILET	Tile 1 EXISTING	1x4 PAINTED WOOD	EXISTING	Paint 1	EXISTING	Painted	EXISTING	8'-0"		

# MAIN PLAN - SCHEDULES


SCALE: 3/8" = 1'-0"

		DOOF	R SCHEDULE		
<b>ROOM SCHEDULE ID</b>	OPENING ID	SIZE	HARDWARE	COMMENT	COUNT
107	F	2'-10"	LEVER FLAT	STAIR	1
102	G	5'-0"	PANIC HARDWARE	HALL EXIT	1
103	Н	3'-0"	LEVER FLAT	HALL	1
102		3'-0"	LEVER FLAT	TOILET	1
109	J	3'-0"	PER MANUF.	FREEZER	1
109	K	3'-0"	PER MANUF.	COOLER	1
113	L	3'-0"	LEVER FLAT	STAFF ACCESS ONLY	1
113	M	3'-0"	PANIC HARDWARE	FENCE GATE	1
113	N	3'-0"	PANIC HARDWARE	PATIO EXIT	1
111	0	3'-0"	LEVER FLAT	LOUNGE EXIT ACCESS	1
103	Р	2'-10"	LEVER FLAT	BACK HALL ACCESS	1


	WIN	DOW SCHEDUI	LE	
ROOM SCHEDULE ID	OPENING I	D SIZE	COMMENT	COUNT
112	6	7'-0" x 10'-0"	PATIO / RETRACTABLE	1
112	7	7'-0" x 10'-0"	PATIO / RETRACTABLE	1
112	9	7'-0" x 10'-0"	PATIO / RETRACTABLE	1
112	10	3'-5" x 10'-0"	PATIO / RETRACTABLE	1
112	11	7'-0" x 10'-0"	PATIO / RETRACTABLE	1
112	12	7'-0" x 10'-0"	PATIO / RETRACTABLE	1
112	13	7'-0" x 10'-0"	PATIO / RETRACTABLE	1
112	14	7'-0" x 10'-0"	PATIO / RETRACTABLE	1
112	15	7'-0" x 10'-0"	PATIO / RETRACTABLE	1
112	21	7'-0" x 10'-0"	PATIO / RETRACTABLE	1
112	22	7'-0" x 10'-0"	PATIO / RETRACTABLE	1
112	23	7'-0" x 10'-0"	PATIO / RETRACTABLE	1
112	24	7'-0" x 10'-0"	PATIO / RETRACTABLE	1
112	25	7'-0" x 10'-0"	PATIO / RETRACTABLE	1


	ROOM FINISH SCHEDULE										
SCHEDULE ID	ROOM NAME	FLOORING	FLOORING COMMENT	BASEBOARD	<b>BASEBOARD COMMENT</b>	WALLCOVERING	WALLCOVERING COMMENT	CEILING FINISH	CEILING COMMENT	CEILING HEIGHT	
109	COOLER	BY MANUF.	BY MANUF.	BY MANUF.	BY MANUF.	BY MANUF.	BY MANUF.	BY MANUF.	BY MANUF.	7'-0"	
110	FREEZER	BY MANUF.	BY MANUF.	BY MANUF.	BY MANUF.	BY MANUF.	BY MANUF.	BY MANUF.	BY MANUF.	7'-0"	
102	HALL	Hardwood 1	EXISTING	1x4 PAINTED WOOD	EXISTING	Paint 1	EXISTING	Painted	EXISTING	7'-6"	
103	HALL	Hardwood 1	EXISTING	1x4 PAINTED WOOD	EXISTING	Paint 1	EXISTING	Painted	EXISTING	7'-6"	
111	LOUNGE	Hardwood 1	EXISTING	1x4 PAINTED WOOD	EXISTING	Paint 1	EXISTING	Painted	EXISTING	7'-6"	
108	OFFICE	Hardwood 1	EXISTING	1x4 PAINTED WOOD	EXISTING	Paint 1	EXISTING	Painted	EXISTING	7'-6"	
112	PATIO	Hardwood 1	NEW CONCRETE S.O.G.	N/A	N/A	PAINTED ALUMINUN	NEW ALUMINUM & GLASS	PAINTED ALUMINUM	NEW ALUMINUM & GLASS	11'-0"	
107	STAIR	Hardwood 1	EXISTING	1x4 PAINTED WOOD	EXISTING	Paint 1	EXISTING	Painted	EXISTING	7'-6"	
106	TOILET	Tile 1	EXISTING	1x4 PAINTED WOOD	EXISTING	Paint 1	EXISTING	Painted	EXISTING	7'-6"	
113	VESTIBULE	Hardwood 1	EXISTING CONCRETE S.O.G	a.N/A	N/A	PAINTED EXTERIOR	EXISTING EXTERIOR	PAINTED ALUMINUM	NEW ALUMINUM AWNING	11'-0"	

BASEMENT - SCHEDULES

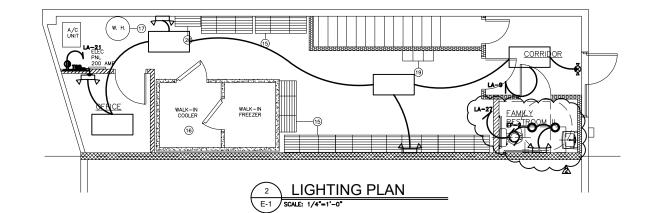



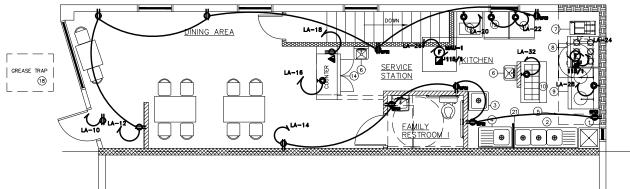

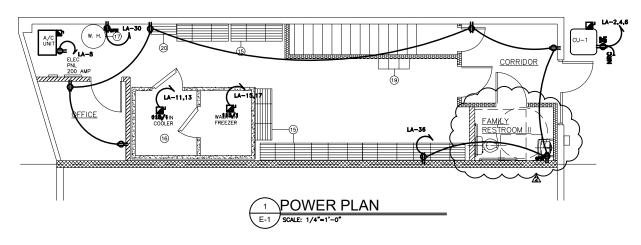

#### ELECTRICAL LEGEND

QUADRUPLEX RECEPTACLE, 18" AFF OR AS NOTED, 15A/125V.

DUPLEX RECEPTACLE, 18" AFF OR AS NOTED, 15A/125V.

DUPLEX RECEPTACLE, DEDICATED, 18° AFF OR AS NOTED, 15A/125V.

DUPLEX RECEPTACLE, (GFCI), ABOVE COUNTER HEIGHT OR AS NOTED.

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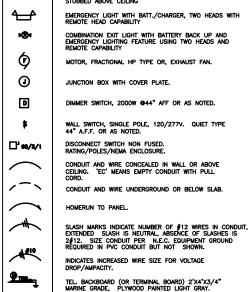
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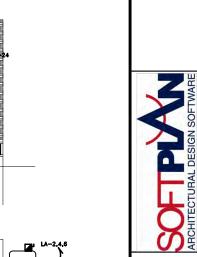
DUPLEX RECEPTACLE, (GFCI), WATER PROOF, ON THE FLOOR.

SPECIAL RECEPTACLE, COORDINATE NEMA CONFIGURATION WITH EQUIPMENT.

COMBINATION TELEPHONE / DATA OUTLET BOX, WALL MOUNTED 18" AFF OR AS NOTED, WITH 3/4" CONDUIT STUBBED ABOVE CEILING

TEL. BACKBOARD (OR TERMINAL BOARD) 2'X4'X3/4" MARINE GRADE, PLYWOOD PAINTED LIGHT GRAY. PROVIDE RECEPTACLE AND POSITIVE GROUND CONDUCTOR. (#6 AWG COPPER)






3226 ROSWELL RD\_BACKYARD
PHONE:
FAX:
MOBILE:

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SCALE: 3/16" = 1'-0"
DRAWN BY:
DATE: Monday, April 1, 2

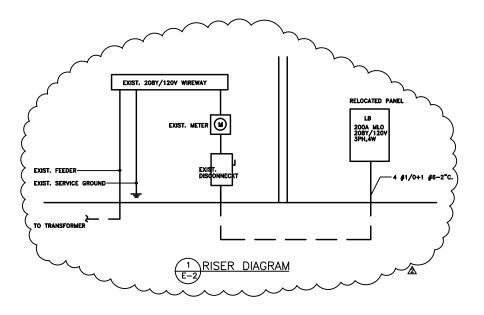

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М	IAIN: 20	OA MLO	VOLTAGE:	208/	/120	PAHS	E: 3	WIRE:	4				MOUN	TING:				AIC:	22,000	NOTES:		
СКТ	TRIP						LOAD	(KVA)							L	OAD (F	(VA)				TRIP	CF
#	POLE	DE	SCRIPTION	LTG	REC	MTR	A/C	EQUIP.	MISC				LTG	REC	MTR	A/C	EQUIP.	MISC	DESCRIPTI	ON	POLE	#
1	20	LGTTR/	ACK LIGHT	1.205												2.26						2
3	20	LGTCH	ANDELIER	0.372												2.26			CU-1		30/3	4
5	20	LGTRE	CESSED LIGHT	0.1												2.26					'	6
7	20	LGT K	ITCHEN	0.505												1.8			GAS UNIT		20	8
9	20	LGT B.	ASEMENT LIGHT	0.52														0.5	RECEP S	IGN	20	10
11	/-							1.56						0.9					RECEP DIN	IING AREA	20	1
13	35/2	WALK IN	COOLER					1.56						0.9					RECEP K	ITCHEN	20	1
15								1.4									1.035		UNDERCOU	NTER COOLER	20	1
17	35/2	WALK IN	FREEZER					1.4						0.375					RECEPFR	ONT COUNTER	20	1
19																	2.3		RECEP ICE	MAKER	25	1 2
21	20	TELEPHON	E						0.5								2.42		REACH INS		30	1 2
23	20	EXHAUST	FAN (RESTROOM)			0.5									1.12				EXHAUST F	AN	20	2
25															1.12				MAKE UP A	NR FAN	25	2
27	20	LGT R	ESTROOM II LIGH	0.541											0.18				HOOD CON	TROL	20	2
29														0.18					RECEPTW	ATER HEATER	20	3
31														0.69					SANDWICH	TABLE	20	3
33												$\vdash$										1 3
35												$\vdash$		1.26					RECEP BA	SEMENT	20	3
37																						31
39	t							l		Г		$\vdash$										4
41																						4
LIG	HTING:		2.702																CONNECTED	LOAD (KVA):		(31.7
	CEPTACL	E:	3.045								•	_							DEMAND LO		(	31.
	TORS:		2,92					PAI	HSE A	12,	34 .		102.8	33							(	
A/0			8.58						HSE B	9.		~	81.0	_					CONNECTED	LOAD (AMPS	): (	88.
	UIPMENT	. +	11.675						HSE C	_	655		8Q.4	-						DAD (AMPS):	~ (	88.
4											<u> </u>	_	AMP	_						· ···· -/·	-(	
Leic	CELLAN	FOLIS.	1.0							Ë	•			_					AMPACITY F	DECLUBED.	-(	88.

#### NOTES & SPECIFICATIONS:

- 1. CONTRACTOR SHALL VISIT THE SITE AND THOUGHLY FAMILIARIZE HIMSELF WITH EXISTING CONDITIONS.
- CONTRACTOR SHALL FURNISH ALL LABOR, MATERIALS, AND EQUIPMENT, PAY ALL FEES AND COSTS, SHALL DOSTAN ALL PERMITS, APPROVALS, AND INSPECTIONS TO PROVIDE A COMPLETE ELECTRICAL INSTALLATION.
- 3. CONTRACTOR SHALL COORDINATE WITH ALL UTILITIES. CONTRACTOR SHALL PAY ALL ASSOCIATED COSTS FOR TEMPORARY AND PERMANENT POWER
- 4. ALL ELECTRICAL INSTALLLATIONS TO COMPLY WITH NATIONAL AND LOCAL CODES AND TO BE INSTALLED IN A FIRST CLASS WORKMANLIKE MANNER.
- 5.ALL ITEMS INSTALLED PER THESE DRAWINGS SHALL BE NEW AND U.L. LABELED AND LISTED FOR THEIR SPECIFIC USE.
- 6. WORK SHALL BE GUARANTEED FOR A PERIOD OF ONE (1) YEAR FROM THE DATE OF OCCUPANCY (C.O.).
  ALL ELECTRICAL EQUIPMENT AND SYSTEMS SHALL BE TESTED AND ADJUSTED FOR PROPER OPERATION
  AND FAULT FREE UPON DELIVERY TO OWNER.
- 7. LOCATIONS SHOWN ARE APPROXIMATE. CONTRACTOR SHALL COORDINATE ACTUAL LOCATIONS WITH OTHER TRADES. THESE DRAWINGS ARE GENERALLY DIAGRAMMATIC IN NATURE.
- 8. ALL ELECTRICAL EQUIPMENT SHALL BE IDENTIFIED WITH PERMANENT LABELS. EXTERIOR LABELS SHALL BE WEATHERPROOF.
- 9.PANELBOARDS SHALL BE EQUAL TO SQUARE D TYPE NQOD, BOLT -ON BREAKERS, 20" MINIMUM WIDTH. SEE PANELBOARD SCHEDULES FOR AIC RATINGS.
- 10.ALL 15A/1P AND 20A/1P CIRCUIT BREAKERS SHALL BE SWITCH DUTY RATED. ALL BREAKERS SERVING HVAC EQUIPMENT SHALL BE HACR RATED. MULTI-POLE BREAKERS SHALL HAVE COMMON TRIP ELEMENT.
- 11. PANELS SHALL BE DEADFRONT WITH NO OPEN SPACES OR KNOCK-OUTS. PANELS SHALL NOT HAVE CABINETS OR BUSSING MOUNTED UPSIDE DOWN.
- 12. PANELS SHALL HAVE NUMBERD POLE SPACES AND COMPLETED, CORRECT PANEL SCHEDULE.
- 13. CONDUCTORS SHALL BE COPPER, TYPE THHN/THWN 600V, 75°C. MINIMUM WIRE SIZE IS #12 AWG.
- 14. WHEN PVC CONDUIT IS USED, PROVIDE AN ADDITIONAL EQUIPMENT GROUNDING CONDUCTOR.
- 15. WHERE CONDUIT, WIRE, OR EQUIPMENT SIZES AND TYPES ARE NOT SHOWN, THEY SHALL BE IN ACCORDANCE WITH NEC REQUIREMENTS.
- 16. EXPOSED AND ABOVE CEILING BRANCH CIRCUITRY SHALL BE THHN COPPER INSTALLED IN EMT RACEWAY WITH STEEL SET SCREW FITTINGS.
- 17.IN WALLS AND ABOVE CELINGS, LIGHTING BRANCH CIRCUITRY MAY BE ACCOMPLISHED WITH A FLEXIBLE WIRING SYSTEM COMPLETE WITH ALL FITTINGS AND ACCESSORIES AS MANUFACTURED BY LITHONIA LIGHTING OR EQUAL, LISTED FOR PLENUM USE.
- 18. UTILIZE TYPE MC CABLE FOR BRANCH CIRCUIT IN WALLS AND ABOVE CEILINGS.
- 19. SIZE CONDUCTORS AS NECESSARY TO MEET VOLTAGE DROP REQUIREMENTS OF N.E.C.
- 20. PROVIDE 1#6 COPPER GROUND CONDUCTOR AT TELEPHONE BACKBOARD. CONNECT TO BUILDING STEEL.
- 21. CIRCUITS TO ROOF SHALL BE ROUTED WITHIN RTU CURB.
- 22. METALLIC ELECTRICAL BOXES SHALL BE INSTALLED SO THERE IS A 24" MIN. HORIZONTAL SEPARATION WHEN BOXES ARE LOCATED ON OPPOSITE SIDES OF A RATED WALL. THE OPENING BETWEEN THE BOX AND THE WALLBOARD SHALL NOT EXCEED 1/8".
- 23. OUTLET AND SWITCH COVERS SHALL BE SATIN STAINLESS IN FINISHED AREAS, SHEET STEEL IN UNFINISHED AREAS.
- 24. EQUIPMENT, CONDUIT, AND DEVICES ON REAR MASONRY WALLS ARE EXPOSED UNLESS NOTED OTHERWISE. CONDUIT AND DEVICES ON STUD OR FURRED WALLS SHALL BE CONCEALED OR RECESSED.
- 25. BRANCH CIRCUIT FEEDING THE EMERGENCY LIGHTING SHALL BE THE SAME BRANCH CIRCUIT AS THAT SERVING THE NORMAL LIGHTING IN THE AREA AND CONNECTED AHEAD OF ANY LOCAL SWITCHES.

	LIGHTING FIXTURE	SCHEDULE	
TYPE	DESCRIPTION	LAMP	NOTES
	2'X2' FLUORESCENT LIGHT FIXTURE	(3) 18W	54W 120V
	2'X4' FLUORESCENT LIGHT FIXTURE	(4) F32T8	125W 120V
	PARABOLIC 3-LAMP 2'X4' TROFFER		80W 120V
0	RECESSED LIGHT FIXTURE (LED)	(1) 18W	18W 120V
Ю	WALL MOUNTED VANITY FORTURE (LED)	(2) 10W	20W 120V
ф	PENDANT LIGHT (LED)	(2) 12W	24W 120V
$\Phi$	CHANDELIER		300W 120V
$\nabla \nabla \nabla$	TRACK LIGHT (LED)	150W/2FT	120V
Þ <b>⊗</b> 4	EXIT SIGN WITH BATTERY BACK-UP	INCLUDED	5W 120V
4	EMERGENCY BATTERY PACK	INCLUDED	5W 120V
	STRING LIGHT		12W/10FT 120V



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SCALE: 3/16" = 1'-0"
DRAWN BY:
DATE: Monday, April 1.

3226 ROSWELL RD\_BACKYARD PHONE:

PAX:

MOBILE:

SCALE: 3/16" = 1'-0"
DRAWN BY:
DATE: Monday, April 1, 2

3226 ROSWELL RD\_BACKYARD
PHONE:
FAX:
MOBILE:

EXISTING LANDSCAPE COOLER 6' X 6' **ф**ф-**-**

GREASE TRAP

#### ELECTRICAL LEGEND

QUADRUPLEX RECEPTACLE, 18" AFF OR AS NOTED, 15A/125V

DUPLEX RECEPTACLE, 18" AFF OR AS NOTED, 15A/125V.

DUPLEX RECEPTACLE, DEDICATED, 18" AFF OR AS NOTED, 15A/125V.

DUPLEX RECEPTACLE, (GFCI), ABOVE COUNTER HEIGHT OR AS NOTED.

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DUPLEX RECEPTACLE, (GFCI), WATER PROOF, ON THE FLOOR.

SPECIAL RECEPTACLE, COORDINATE NEMA CONFIGURATION WITH EQUIPMENT.


SLASH MARKS INDICATE NUMBER OF #12 WIRES IN CONDUIT, EXTENDED SLASH IS NEUTRAL, ABSENCE OF SLASHES IS 2#12. SIZE CONDUIT PER N.E.C. EQUIPMENT GROUND REQUIRED IN PVC CONDUIT BUT NOT SHOWN.

INDICATES INCREASED WIRE SIZE FOR VOLTAGE DROP/AMPACITY.


TEL. BACKBOARD (OR TERMINAL BOARD) 2'X4'X3/4" MARINE GRADE, PLYWOOD PAINTED LIGHT GRAY. PROVIDE RECEPTACLE AND POSITIVE GROUND CONDUCTOR. (#6 AWG COPPER)




## PROPOSED BASEMENT PLAN

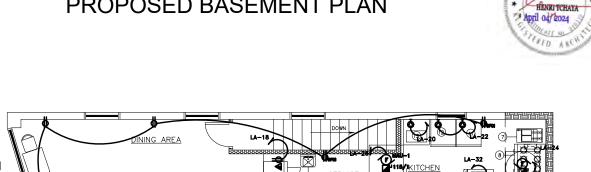



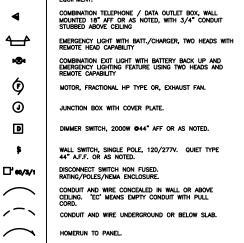

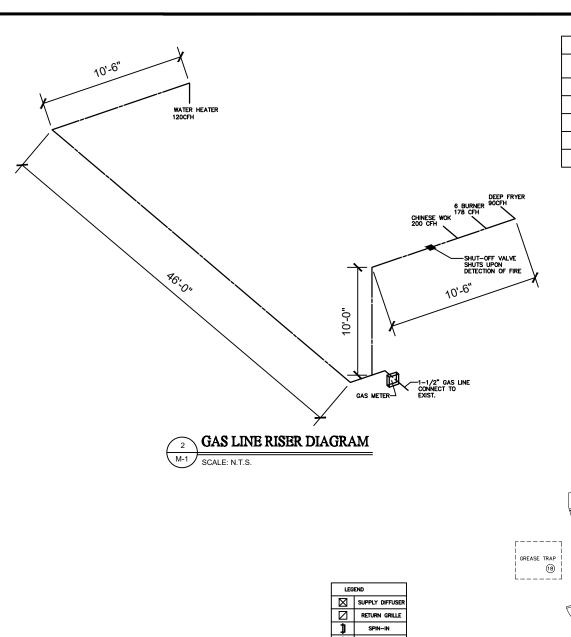

THERMOSTAT

FLEXIBLE DUCT

	FAN SCHEDULE										
MARK	CFM	S.P. WG	HP	TYPE	BASIS OF DESIGN	LOCATION/SERVICE	NOTES				
<u>EF-1</u>	4000	0.625"	1.5	CENTRIFUGAL	COOK 180 ACRUB	10' LONG KITCHEN HOOD					
<u>MAU-1</u>	3400	0.625	1.5	CENTRIFUGAL	COOK 120 KSPB	10' LONG KITCHEN HOOD					
<u>FF-2</u>	75					RESTROOM					


#### KITCHEN HOOD HANGING INFORMATION

HOODS SHALL BE INSTALLED IAW MANUFACTURER'S WRITEN INSTRUCTIONS.

- 1. POSITION 2"x2"x1/4" ANGLE FOR BRIDGING JOIST SPACE.
- INSERT 1/2" ALL-THREAD RODS INTO MOUNTING BRACKETS AND ATTACH W/ 1/2" NUT. ATTACH TOP PORTIONS OF ALL-THREAD ROD INTO 2"x2"x1/4" ANGLE W/ 1/2" NUTS.

	HOOD SCHEDULE								
MARK	EXHAUST CFM	MAKE UP AIR CFM	BASIS OF DESIGN	NOTES					
H-1	4000	3400	GREASE MASTER OR PDI HOOD, 10' X 4' COMPENSATING	1003					

- 1) HOOD TO BE A TYPE I GREASE REMOVAL HOOD, AIR FLOW CALCULATED USING SMC SECTION 507.13.4
- 2) HOOD REQUIRES FIRE SUPPRESSION SYSTEM, USE EXIST. FIRE SUPPRESSION SYSTEM

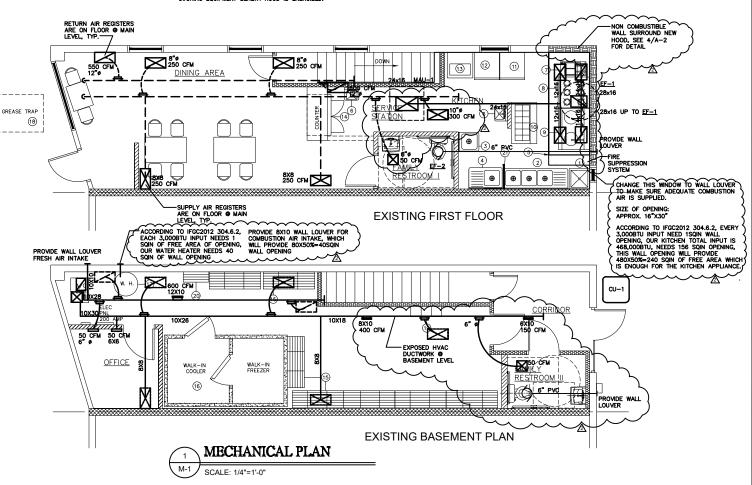







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SCALE: 3/16" = 1'-0" DRAWN BY: DATE: Monday, April 1, 2

3226 ROSWELL RD\_BACKYARD
PHONE:
FAX:
MOBILE:



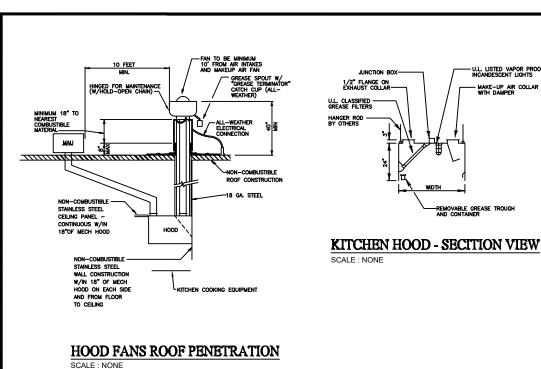

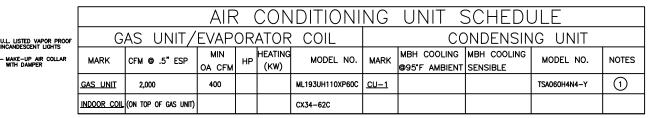MAKE-UP AIR COLLAR WITH DAMPER

1. PROVIDE SMOKE DETECTOR IN THE SUPPLY AIR DUCT OF FAN COIL UNIT.

## TYPE OF GAS: NATURAL MATERAIL OF GAS PIPING STEEL, SCHEDULE 40

90,000 BTU/HR 200.000 BTU/HF

**EQUIPMENT LIST** 

60 GALLON GAS WATER HEATER

DEEP FRYER

ROUTE GAS PIPING INSIDE BUILDING TIGHT TO ROOF STRUCTURE

GAS PRESSURE IS 7" W.C. (VERIFY W/ GAS SUPPLIER) CONFIRM ACTURAL GAS LOAD W/ OWNER PRIOR TO CONSTRUCTION INSTALL REGULATORS AS REQUIRED BY EQUIPMENT

CALCULATED LOADS: PER TABLE 403.3 IMC: 738 FT2 RESTAURANT (EXCLUDE STORAGE/RESTROOM AREA)  $V = R_p P_z + R_q A_z = 7.5 cfm/px14p + 0.18 cfm/ft2x738ft2 = 238 cfm$ TOTAL OUTSIDE AIR REQUIRED IS 238 CFM. ADJUST OUTSIDE AIR DAMPERS ON HVAC UNITS TO PROVIDE 400 CFM OA. 2

SCALE: 3/16" = 1'-0"
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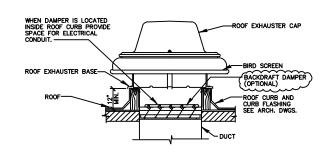
3226 ROSWELL RD\_BACKYARD
PHONE:
FAX:
MOBILE:

A	IR BALANCE	
	EXHAUST MAKE U	P AIR NET
EF-1 @ KITCHEN:	-4000 CFM	-4000
MAU-1 @ KITCHEN:	3400 CFM	3400
		-600
HVAC AIR SUPPLY:	2000 CFM	
RETURN AIR:	-1800 CFM	
		200
RTU FRESH AIR:	400 CFM	400
TOTAL		0
TOTAL PRESSURE WITHIN	RESTAURANT:	0

# - HANGING BRACKET WITH 5/8" HOLE FOR THREADED ROD EXHAUST OUTLET TO EXHAUST FAN EXHAUST OUTLET TO EXHAUST FAN JUNCTION BOX -MAKE-UP INLET -HOOD PREWIRED TO JUNCTION BOX ON TOP OF HOOD AND READY FOR CONNECTION TO EXTERNAL POWER SOURCE IN WALL.

#### KITCHEN HOOD - PLAN VIEW

SCALE : NONE



#### ROOF MOUNTED POWER EXHAUSTER

