NILES BOLTON ASSOCIATES

September 15, 2022

City of Atlanta, Office of Planning 55 Trinity Avenue, Suite 1450 Atlanta, Georgia 30303

Re: SAP Application: Cover Letter

Camden Andrews (55 E Andrews Dr.)

NBA Project No. 121394.00

Dear City of Atlanta, Office of Planning:

Please find attached application for a proposed new residential building, Camden Andrews, at 55 E Andrews Drive. The proposed project includes 464,726 square feet of net heated area with 490 structured parking spaces. The parking decks are accessed off new streets, Ferry Landing Lane, and Cains Hill Place, perpendicular to East Andrews Drive. The main entry faces E Andrews Drive.

The proposed Project is the third residential phase proposed by Camden Development, Inc. and works to provide an anchor between the two newly built streets that intersect the Camden Buckhead property at 3300 Roswell Road and a future development to the East, at the intersection of Roswell Road and E Andrews.

Camden Andrews strives to create a sense of place for the neighborhood with an interactive street frontage at the public right of way through multiple horizontal building steps and ground level residential programming. Terraced building massing and a private rooftop amenity terrace will provide skyline views of Buckhead. Together these two design intentions will strengthen the architectural character of the Buckhead Village with a predominant glass and masonry exterior.

One administrative variation is requested as follows:

Section 16-181.017 (6): Relief in the requirement to have walls that do not exceed 30 inches in height. Due to existing topography along E Andrews Drive, the below grade parking structure's wall follows grade for roughly 25% of the E Andrews Drive elevation, as shown on view 1/SAP_20. The intent is to soften the height of the wall at this transition with an intentional landscape buffer, potential building signage, and an active stair on the west corner of the street frontage.

Please feel free to reach out if you have any questions during your review.

Atlanta 3060 Peachtree Rd. N.W. Suite 600 Atlanta, GA 30305 404 365 7600

Alexandria 300 North Lee St. Suite 502 Alexandria, VA 22314 703 836 0915

NILES BOLTON ASSOCIATES

<u>Attachments</u>: LEED Certification (or similar) incentive letter of intent from Marie Nisson with US-Ecologic, the Project's Energy Consultant.

Sincerely,

Brian J. Ward, AIA, LEED AP Director of Design

KMU/snk

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RE: SPI-9 Buckhead Village District Regulations Sec. 16-181.012 – Development Controls LEED *Certification (or similar) incentive.*

SUMMARY:

The project team for Camden Andrews (55 E. Andrews Dr NW, Atlanta, GA 30305) request approval of an equivalent standard similar to LEED for all applicable incentives. The paragraphs below will outline the similarities and compare differences to show the equivalency of ICC/ASHRAE 700-2020 National Green Building Standard to LEEDv4 BD+C: Multifamily Midrise.

BACKGROUND:

The National Green Building Standard (NGBS) is an ANSI approved, ICC standard and considered to be equivalent to LEED by federal, state, and local entities, such as: HUD, Fannie Mae, Freddie Mac, and the Georgia 2022 QAP. NGBS is also a compliance path to the International Green Construction Code (IgCC).

The 2020 NGBS is similar to LEED v4 as it scores building performance in six sustainability chapters that align with LEED categories, namely: Site, Materials Efficiency, Energy Efficiency, Water Efficiency, Indoor Environmental Quality, and Operations, Maintenance, and Education. Both programs also utilize independent third-party verification of green design and construction measures.

The 2020 NGBS differs from LEED v4 in the following important areas:

- Minimum energy requirement baselines: 2020 NGBS and LEED v4 award points for performance above their respective minimum energy requirements. 2020 NGBS uses the same baseline as the 2018 IECC while LEED v4 references the ASHRAE compliance path for the 2012 IECC as its baseline. The ASHRAE baseline has specific mandatory requirements that differ from other energy code compliance options, triggering additional design and construction measures that add administration and material cost without adding value to the owner, resident, or community.
- Scoring philosophy: Both programs have mandatory measures within sustainability categories. The project begins accruing points after mandatory measures are met.
 - LEED awards certification based on total points. Exemplary performance in one category can carry the weight for anemic performance in another category.
 - NGBS requires that each sustainability chapter meet the targeted certification level, with an escalating "additional points from any category" requirement to move between certification tiers
 - Example: a mixed-use project in a dense urban area will score very well in the site selection and compact development measures under both programs. LEED can use those points to overcome below average performance in another category (e.g. Materials and Resources) and elevate the







certification level. NGBS re-sets the bar at each category; exemplary performance in one area alone has little impact on the overall certification level. The NGBS certification level is restricted to the level of the lowest performing chapter (if bronze is achieved in the materials chapter, the project is limited to bronze while LEED could achieve Silver using the same material schedule).

PROJECT SPECIFIC DETAILS:

Scorecards have been completed for both LEED v4 Multifamily Midrise and 2020 NGBS checklists using the Schematic Design plans for Camden Andrews. The dense urban infill location scores well under site measures in both programs.

Attachments illustrate the scoring of each program. LEED compliance mandates costs not associated with the intent of the Development District requirements, such as energy performance modeling using ASHRAE 90.1-2010 guidelines. The additional administrative costs bring no benefit to any stakeholder. The 2020 NGBS energy performance criteria are aligned with local code adoption and reduce non-value administrative costs.

NGBS equivalency to LEED Silver can be demonstrated with the attached scorecards. We recommend recognizing compliance with ICC/ASHRAE 700 – 2020 NATIONAL GREEN BUILDING STANDARD with minimum total score of 334 points be considered equivalent to LEED Silver level performance.

ATTACHMENTS:

- LEED v4 Scorecard Camden Andrews
- 2020 NGBS Scorecard Camden Andrews
- Energy Efficiency Comparison

Sincerely,

Marie Nisson

LEED AP Homes, LEED Green Rater, NGBS Green Master Verifier

Marie.Nisson@US-EcoLogic.com







LEED v4 for Building Design and Construction: Multifamily Midrise

Project Checklist

Project Name: Camden Andrews
Date: 9/12/2022

2

Y ? N

2 Credit Integrative Process

11.5	0	0	Loca	tion and Transportation	15
Υ			Prereq	Floodplain Avoidance	Required
				PERFORMANCE PATH	
			Credit	LEED for Neighborhood Development Location	15
				PRESCRIPTIVE PATH	
8			Credit	Site Selection	8
0			Credit	Compact Development	3
2			Credit	Community Resources	2
1.5			Credit	Access to Transit	2
			_		
3.5	0	0	Susta	ainable Sites	7
\ \			_	O and the order of the Delletter December 1	D

3.5	U	U	Susta	ainable Sites	1
Υ			Prereq	Construction Activity Pollution Prevention	Required
Υ			Prereq	No Invasive Plants	Required
1			Credit	Heat Island Reduction	2
1			Credit	Rainwater Management	3
1.5			Credit	Non-Toxic Pest Control	2

4	0	0	Water	Efficiency	12
Υ			Prereq	Water Metering	Required
				PERFORMANCE PATH	
0			Credit	Total Water Use	12
				PRESCRIPTIVE PATH	
3			Credit	Indoor Water Use	6
1			Credit	Outdoor Water Use	4

1	4	0	0	Energ	gy and Atmosphere	37
`	Y			Prereq	Minimum Energy Performance	Required
`	Y			Prereq	Energy Metering	Required
`	Y			Prereq	Education of the Homeowner, Tenant or Building Manager	Required
1	4			Credit	Annual Energy Use	30
(0			Credit	Efficieng Hot Water Distribution	5
(0			Credit	Advanced Utility Tracking	2

2	0	0	Mate	rials and Resources	9
Υ			Prereq	Certified Tropical Wood	Required
Υ			Prereq	Durability Management	Required
1			Credit	Durability Management Verification	1
1			Credit	Environmentally Preferable Products	5
0			Credit	Construction Waste Management	3

10	0	0	Indoor	Environmental Quality	18
Υ			Prereq	Ventilation	Required
Υ			Prereq	Combustion Venting	Required
Υ			Prereq	Garage Pollutant Protection	Required
Υ			Prereq	Radon-Resistant Construction	Required
Υ			Prereq	Air FIltering	Required
Υ			Prereq	Environmental Tobacco Smoke	Required
Υ			Prereq	Compartmentalization	Required
3			Credit	Enhanced Ventilation	3
0.5			Credit	Contaminant Control	2
2			Credit	Balancing of Heating and Cooling Distribution Systems	3
0			Credit	Enhanced Compartmentalization	3
2			Credit	Enhanced Combustion Venting	2
1			Credit	Enhanced Garage Pollutant Protection	1
1.5			Credit	Low Emitting Products	3
0			Credit	No Environmental Tobacco Smoke	1

2.5	0	0	Innovat	ion	6
Υ			Prereq	Preliminary Rating	Required
1.5			Credit	Innovation	5
1			Credit	LEED AP Homes	1

4	0	0	Regional Priority	4
1			Credit Regional Priority: Outdoor Water Use	1
1			Credit Regional Priority: Heat Island Reduction	1
1			Credit Regional Priority: Balancing Heating and Cooling Systems	1
1			Credit Regional Priority: Annual Energy Use	1

 54
 0
 0
 TOTALS
 Possible Points:
 110

 Certified: 40 to 49 points, 9 point



Summary of Results of the Design Phase

✓ No Mandatory items missing on the "Overview (Design)" page

Additional Points Claimed

Project Name: Camden Andrews

77

155

(53)

Location: 55 E ANDREWS DR NW, ALTANTA, Georgia 30305

(175)


Points Required				Points
Bronze	Silver	Gold	Emerald	Claimed
50	64	93	121	100
43	59	89	119	58
30	45	60	70	49
25	39	67	92	53
25	42	69	97	61
8	10	11	12	15
50	75	100	100	
0	0	0	0	
231	334	489	611	336
	50 43 30 25 25 25 8 50	Bronze Silver 50 64 43 59 30 45 25 39 25 42 8 10 50 75 0 0	Bronze Silver Gold 50 64 93 43 59 89 30 45 60 25 39 67 25 42 69 8 10 11 50 75 100 0 0 0	Bronze Silver Gold Emerald 50 64 93 121 43 59 89 119 30 45 60 70 25 39 67 92 25 42 69 97 8 10 11 12 50 75 100 100 0 0 0 0

Mandatory	No
Practices	Errors
✓	✓
✓	✓
✓	✓
✓	✓
✓	1
✓	1

Overall Level Achieved for Design	Bronze

NGBS ENERGY EFFICIENCY COMPARISON

MID- AND HIGH-RISE MULTIFAMILY BUILDINGS

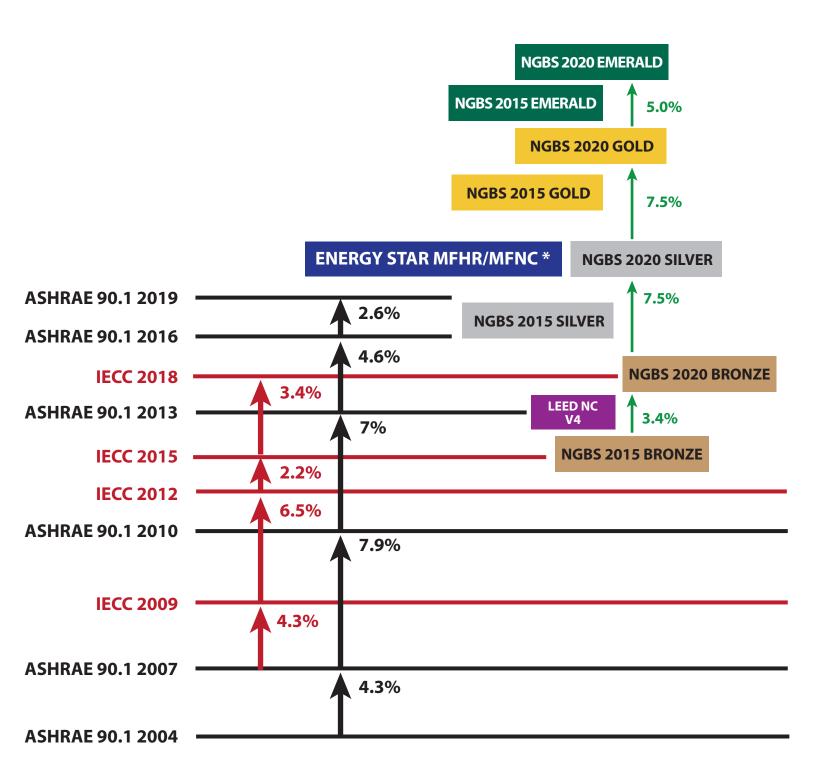

- * ENERGYSTAR MFHR and ENERGYSTAR MFNC 15% above state adopted code
- 1. CA TITLE 24 2016 = 29.8% above IECC 2018

 CA TITLE 24 2019 (with pv mandate) = 59.8% above IECC 2018
- 2. Washington State Energy Code = ASHRAE 90.1 2019
- 3. Florida Code 2017 = IECC 2015, Florida Code 2020 = IECC 2018

- NGBS 2015 Silver = 7.5% above NGBS 2015 Bronze
- NGBS 2015 Gold = 7.5% above NGBS 2015 Silver
- NGBS 2015 Emerald = 5% above NGBS 2015 Gold

References

- ACEEE. Commercial Codes. <u>www.database.aceee.org/state/commercial-code</u>.
- Athalye R., Halverson M., Rosenberg M., Liu B., Zhang J., Hart R., Mendon V., Goel S., Chen Y., Xie Y., Zhao M. (2017, October). *Energy Savings Analysis: ANSI/ASHRAE/IES Standard 90.1-2016*. U.S. Department of Energy, Pacific Northwest National Laboratory.
- Athalye R., Rosenberg M., Liu B., Zhang J., Hart R., Mendon V., Goel S., Xie Y. (2013, August). *Energy and Energy Cost Savings Analysis of the IECC for Commercial Buildings*. U.S. Department of Energy, Pacific Northwest National Laboratory.
- Athalye R., Rosenberg M., Liu B., Zhang J., Hart R., Zhuge J., Xie Y. (2015, August). *Energy and Energy Cost Savings Analysis of the 2015 IECC for Commercial Buildings*. U.S. Department of Energy, Pacific Northwest National Laboratory.
- California Energy Commission. (2016, September). Energy Efficiency Comparison: California's 2016

 Building Energy Efficiency Standards and ASHRAE/IESNA Standard 90.1-2013.
- Energy Codes. Status of State Energy Code Adoption Commercial. https://www.energycodes.gov/status/commercial
- Halverson M., Richman E., Liu B., Winiarski D. (2011, May). *ANSI/ASHRAE/IESNA Standard 90.1-2007 Final Determination Quantitative Analysis*. U.S. Department of Energy, Pacific Northwest National Laboratory.
- Halverson M., Rosenberg M., Hart R., Richman E., Wang W., Xie, Y., Zhang J., Goel S., Mendon V., Athalye R., (2014, August). *ANSI/ASHRAE/IES Standard 90.1-2013 Determination of Energy Savings: Quantitative Analysis*. U.S. Department of Energy, Pacific Northwest National Laboratory.
- Halverson M., Rosenberg M., Zhang J., Lerond J., Nambia C., Maddox D., Hart R., Goel S., Chen Y., Xie Y. (2021, July). Energy Savings Analysis: ANSI/ASHRAE/IES Standard 90.1-2019. U.S. Department of Energy, Pacific Northwest National Laboratory.
- Thornton B., Rosenberg M., Liu B., Richman E., Wang W., Xie, Y., Zhang J., Cho H., Mendon V., Athalye R., (2011, May). *Achieving the 30% Goal: Energy and Cost Saving Analysis of ASHRAE Standard 90.1-2010*. U.S. Department of Energy, Pacific Northwest National Laboratory.
- U.S. EPA. (unknown). *Residential New Construction Program Requirements*. ENERGY STAR. https://www.energystar.gov/partner-resources/residential-new/program-reqs/mfhr/program.
- U.S. Green Building Council. (2019, July). *LEED v4 for Building Design and Construction*. https://www.usgbc.org/resources/leed-v4-building-design-and-construction-current-version.

APPLICATION FOR A SPECIAL ADMINISTRATIVE PERMIT (SAP) For SPI, Beltline, LW, MR, MRC, NC, I-Mix Zoning Districts & Unified Development Plans City of Atlanta, Office of Zoning and Development (404-330-6145)
APPLICANT (name) Robert Vance (on behalf of Camden Development)
ADDRESS 11720 Amber Park Drive, Suite 600, Alpharetta, GA 30009
PHONE NO. 470-299-7051 EMAIL bob.vance@kimley-horn.com DATE STAMP
PROPERTY LANDOWNER Camden USA (Contact Chad Weaver)
ADDRESS 5100 Lemon Street, Suite 209, Tampa, FL 33609 OF FICE OF ZUINING AND DEVELOPMENT
PHONE NO. 813-286-5951 EMAIL cweaver@camdenliving.com
ADDRESS OF PROPERTY 55 East Andrews Drive NW
Land District 17th Land Lot 99 Council District 8 NPU B
Is property within the BeltLine Overlay District? Yes No Zoning Classification SPI-9, SA-2
Is Inclusionary Zoning applicable to this project? Yes No Is this a Unified Development Plan? Yes No I
Project Summary: Provide cover letter describing new construction, alterations, repairs or other changes to the exterior of existing structures and/or the site. Requests for administrative variations must be accompanied by a written justification for each. Property Survey: Submit one (1) copy. Lot consolidation, re-platting or subdivision may be required prior to approval of SAP. Site Plan (released for construction and sealed) and Building Elevations: a. Initial Submission: One(1) site plan & One (1) set of elevations. b. Other information: Copies of applicable Rezoning Legislation, Special Use Permit and any letters for Variance or Special Exception. Note: additional plans or documents may be required at the discretion of the Office of Zoning and Development. Property Owner Authorization: Submit required notarized owner consent per attached form (page 4). Notice to Applicant: Submit attached form with signature and date (page 10). Development Controls Specification Form: Provide the applicable information (pages 7 - 9).
Fees (non-refundable): Payable to the "City of Atlanta" in the form of cash, credit card, personal or cashier check, or money order.
 □ Exterior demo, outdoor dining new/expansion, or non-expansion. \$250. □ Developments < 50,000 sq.ft. of floor area: \$500. □ Developments ≥ 250,000 sq.ft. of floor area: \$1,500.
I HEREBY AUTHORIZE CITY STAFF TO INSPECT PREMISES OF ABOVE DESCRIBED PROPERTY. I HEREBY DEPOSE THAT ALL STATEMENTS HEREIN ATTACHED & SUBMITTED ARE TRUE TO THE BEST OF MY KNOWLEDGE AND BELIEF.
Date September 14, 20 Signature of Applicant Additional Submittal Requirements (as applicable):
 Inclusionary Zoning: All new or conversion multifamily residential rental projects with 10 or more units in the Beltline Overlay District OR Westside neighborhoods of English Avenue, Vine City, Ashview Heights, or AUC must complete and submit the Inclusionary Zoning Certification Form with their application. Review and complete pages 11-12 of this SAP for certification forms. Beltline, NC-2, NC-6, NC-10, NC-11, NC-12, & NC-14 Districts: Applicant must send a copy of the filed SAP application to the NPU contact. Afterwards, complete the Notarized Affidavit of NPU Notification form (page 6), and provide a copy of U.S. Postal Service Certificate of Mailing. The NPU has up to 21 days to review the SAP and forward comments to the City. Pre-application Conference with Zoning and Development Staff (prior to SAP submittal): Required only for SPIs: 1, 9, 12,
15, 17, 18, 20, 21, 22 and recommended for all other districts. To request this meeting, contact Christian Olteanu at 404-330-6961 or colteanu@atlantaga.gov.
 <u>Development Review Committee (DRC)</u>: Projects in the Beltline & SPIs 1, 9, 12, 15, 16, 17 districts may require DRC review (See page 3).
 <u>Development of Regional Impact (DRI) Study</u>: Mixed-use developments with at least 700,000 s.f. or residential with at least 700 residential units may require a DRI approval by GRTA and ARC. For full thresholds and rules contact GRTA and/or ARC. <u>Initial submission</u>: DRI Form 1 with the SAP application. Zoning and Development staff will then submit information to GRTA and ARC.
• Watershed Management (DWM) Requirements (Section 74-504(a)): Consultation meeting with DWM is REQUIRED for any site disturbance to determine applicable storm water work. Call 404-330-6249 or visit: www.atlantawatershed.org/greeninfrastructure
• <u>Unified Development Plans</u> : Applicable to all zoning districts except R-1 to R-5, RLC, PD, & historic bldgs/districts (Section 16-28.030)
The City Code provides that Zoning and Development Director shall review each request for an SAP within 30 days of a filing of a completed* application. (Atlanta Code Chapter 16, Section 16-25). * Note: NPU/DRC notification and review, as applicable, are required to complete the SAP application. (FOR OFFICE OF ZONING AND DEVELOPMENT OFFICE USE ONLY)
The above request for a Special Administrative Permit (SAP) was approved or denied on
See attached Special Administrative Permit Approval Form(s) for detailed approval information.



City of Atlanta Office of Zoning & Development

SPECIAL ADMINISTRATIVÉ PERMIT (SAP) APPLICATION Submittal Checklist

The following checklist is designed to assist those in preparing required materials for SPI, Beltline Overlay, NC, LW, MRC, and MR districts. <u>Items omitted will delay applicant's review process</u>. The following items are required as part of a complete application for a Special Administrative Permit. **NPU Notification and DRC review, as applicable, are required as a part of a completed SAP application.** <u>Please note</u>: * FINAL APPROVED SAP PLANS ARE REQUIRED WITH THE PERMIT APPLICATION SUBMITTAL TO THE OFFICE OF BUILDINGS.

1.	SAP Application Form and Property Landowner Authorization Form: completed with notarized signatures.
2.	Notice to Applicant Form: with signature and date.
3.	Project Summary: Provide cover letter clearly describing all new construction, alterations, repairs or other changes to the exterior appearance of existing structures or site. Any administrative variations ARE REQUIRED to be accompanied by a written justification for each variation requested.
4.	Property Survey: One (1) copy of survey (for new single-family and duplex construction, show existing footprints
	of principal structures on adjoining lots fronting the same street).
5.	Site Plan (drawn to scale, released and sealed for construction) of proposed improvements showing items listed below*. Initial Submission : One (1) copy for initial staff review. Final Submission (after staff review): CbY (%) copm
	a) Date, north arrow, and graphic scale.
	 b) Adjacent streets, with street names, property lines and dimensions, and easements. c) Existing conditions to remain: identify all overhead utility poles, transformers, above ground storm water detention areas and inlets.
	 d) Proposed new installations: Identify the number, type and location of new street lights, transformers, AC units and other similar mechanical/accessory equipment at or above grade. Identify such items in the public right-of-way which final approval by Department of Public Works or GDOT is required. e) Specify location and widths for all Sidewalks (street furniture and clear zones) and Supplemental Zones. f) Ground floor layout plan with building and tenant entrances also shown g) Street-front ground floor façade fenestration – vertical/horizontal window dimensions and % of façade length h) Outdoor dining – seating plan, dimensions, and % of business establishment floor area
	i) Height of structures (including fences/walls)
	 j) Parking, driveway and curb cut layout and dimensions (auto, truck loading, & bicycle/moped) k) Location of parking deck light fixtures. Also indicate amount of foot-candles, and type of light fixture l) Landscape plan: Planting locations including street trees (with tree species and calipers indicated), parking lot and other on-site landscaped areas (with the dimensions and percentage of lot calculated). m) Provide Developmental Control Specification Form (pages 6-8) information on the site plan. Zoning Classification, Net Lot Area & Gross Land Area, Floor Area Ratio (FAR), square footage of structures & individual uses, etc.
6.	Rooftop plan when counted towards open space requirements.
7.	Elevations of building facades. CbY (1) copy for initial staff review. Final Submission: CbY (%) copm
8.	Section drawing(s) as needed showing required sidewalks, supplemental zones (with retaining walls), and building façade & finished floor-level dimensioned within 5 feet above the adjacent sidewalk-level.
9.	DRI conditions of approval, rezoning legislation, variance or special exception letters printed on site plan.
	Transportation Management Plan/Association Membership (where applicable) required based on the zoning district. See specific zoning regulations for confirmation.
11.	Beltline Overly District, NC-2, NC-6, NC-10, NC-11, NC-12, and NC-14 properties:
	 Mail a copy of the <u>submitted SAP application & drawings stamped received by the Office of Zoning and Development</u> to the NPU contact person.
	 Submit a copy of <u>U.S. Postal Service Certificate of Mailing</u> and <u>Notarized Affidavit of NPU Notification</u> (page 5) as soon as possible to complete the application submission and begin the SAP review period.
12.	Photographs (buildings/site): Show existing conditions for alterations to existing building facades and/or site modifications.
13.	Shared Off-site Parking: Requests for approval of off-site parking submit materials on Shared Off-site Parking checklist.
14.	Other information necessary for the SAP as requested by staff.

SPECIAL ADMINISTRATIVE PERMIT (SAP) APPLICATION

DEVELOPMENT/DESIGN REVIEW COMMITTEES (DRC)

CHECK FOR APPLICABILITY Beltline Overlay and Special Public Interest (SPI) Districts

File #

Development / Design Review Committees (DRC) have been established as an advisory group for the purpose of providing to the Director of the Office of Zoning and Development formal recommendations/comments on Special Administrative Permit (SAP) applications within the Beltline Overlay and particular SPI zoning districts. Applicants are required to make a presentation of their project to the applicable DRC committee. DRC review is required as part of a completed SAP application.

Each DRC shall consist of committee members representing the corresponding district stakeholders including: property owner(s), business owner(s) or resident(s), and applicable neighborhood organization(s), among others.

The DRC convenes monthly (or as needed) to comment on SAP applications within a particular district. Each DRC shall provide recommendations to the Office of Zoning and Development Staff and the applicant within 7 business days, unless the applicant is requested to return to the applicable DRC and/or present to respective neighborhood organization(s), or

DRC Committees (established by City Council Resolution)

SPI-1 Downtown (2007)

- SPI-15 Lindbergh (2001)
- Beltline Overlay (2015)

- SPI-9 Buckhead Village (2010)
- SPI-16 Midtown (2001)
- SPI-12 Buckhead/Lenox Stations (2012) SPI-17 Piedmont Avenue (2001)

Meeting Dates and Locations

Downtown SPI-1

Meetings held the 4th Thursday morning monthly Central Atlanta Progress, 84 Walton Street NW, Suite 500 Contact Fredalyn Frasier: Ffrasier@atlantadowntown.com (404) 307-4286

uckhead Village SPI -9 & Buckhead/Lenox SPI-12 Meeting held 1st Wednesday afternoon monthly BATMA, 3340 Peachtree Road NE Tower Place Bld. 100, Suite 1515 Contact Denise Starling: Denise@batma.org (404) 842-2680

Midtown SPI-16 & Piedmont Avenue SPI-17 Meetings held the 2nd Tuesday evening monthly Midtown Alliance, 999 Peachtree Street NE, Suite 730 Contact Karl Smith-Davids: Karl@MidtownATL.com (404) 443-6249

Beltline Overlay

Meeting held the 3rd Wednesday evening monthly Atlanta Beltline Inc. 100 Peachtree Street NW, Suite 2300 Contact Lynnette Reid: LReid@atlbeltline.org (404) 477-3551

Lindbergh SPI-15: Meetings coordinated by City of Atlanta Zoning and Development Staff: (404) 330-6145.

Application Submittal and Review Process

- 1) Pre-application meeting with Office of Zoning and Development staff. To arrange pre-application meeting, contact Christian Olteanu at 404-330-6961 or colteanu@atlantaga.gov.
- 2) Notify the applicable DRC contact (as listed above) to arrange placement on the next scheduled DRC meeting agenda.

DRC Submittal Requirements

- 1) Written summary of proposed scope of work (include applicable project information such as total square footage, # and breakout of residential units, and square footage of each commercial use, building height, parking and loading provided, etc.).
- 2) Identification of all administrative variations requested and written justification for each requested.
- 3) PDF Digital drawings (to-scale) of site plans and building elevations as applicable to the scope of work.
- 4) Photographs of the existing property.
- 5) Contact DRC representative to e-mail project information (prior to meeting) and confirm DRC meeting date and time.
- 6) At the DRC meeting:
 - a. Provide hardcopies of cover letter and drawings (in 11"x17" size) for distribution to each committee member.
 - b. Provide drawings on boards for project presentation to committee members or digital PowerPoint presentation (coordinate with DRC representative on the latter).

Committee Review Responsibilities

- Make recommendations on project concerning zoning requirements and administrative variations requested.
- Make other design recommendations for consideration concerning an application. Note: these other recommendations are not code requirements.



City of Atlanta Office of Zoning & Development SPECIAL ADMINISTRATIVE PERMIT (SAP) APPLICATION

Notarized Authorization by Property Land Owner

File # _____

(Required only if applicant is not the owner of the property subject to the application)
TYPE OF APPLICATION: Special Administrative Permit
I, Canden USA luc. SWEAR THAT I AM THE LANDOWNER
owner(s) name
OF THE PROPERTY LOCATED AT: 55 East Andrews Drive NW, Land Lot 99, 17th District, Atlanta, GA
AS SHOWN IN THE RECORDS OF Fulton County COUNTY, GEORGIA WHICH IS
THE SUBJECT MATTER OF THE ATTACHED APPLICATION. I AUTHORIZE THE PERSON NAMED
BELOW TO ACT AS THE APPLICANT IN THE PURSUIT OF THIS APPLICATION.
NAME OF APPLICANT (PRINT CLEARLY): Robert Vance
Kimley-Horn
ADDRESS: 11720 Amber Park Drive, Suite 600
Alpharetta, GA 30009
TELEPHONE: 470-299-7051 EMAIL: bob.vance@kimley-horn.com Signature of Property Landowner Chad Weaver Print Name of Property Landowner
Personally Appeared Before Me Chad Weaver
Who Swears That The Information Contained In this Authorization Is True and Correct To The Best of His or Her Knowledge and Belief. Signature of Notary Public

Date

SHARON A. FRANK Commission # GG 293338 Expires January 21, 2023 Bonded Thru Troy Fain Insurance 800-385-7019



City of Atlanta Office of Zoning & Development

SPECIAL ADMINISTRATIVÉ PERMIT (SAP) APPLICATION **Development Controls Specifications (Required)**

File #	

*Developmental Controls forms are required to be completed by the applicant, and all applicable specifications should be shown on the site plan in chart form. Items omitted will delay the plan review process. Refer to City of Atlanta Zoning Code (Chapters 8, 19, and 28) for clarification.

Definitions and	Definitions and Methods of Calculation						
 Net Lot Area (NLA) = length of property line X width of property line GLA for corner lots = (NLA) + [(street "A" right-of-way width ÷2) X (street "A" length of property line)] + [(street "B" right-of-way width ÷2) X (street "B" right-of-way width ÷2)] GLA (with only one front yard adjacent to street) = (NLA) + [(street right-of-way width ÷2) X (length of front property line)] 							
<u>'</u>					= -	tn ÷2) X (lengtn of fro eries) up to 50 feet in	
=			=			-family-zoned subarea	
		-			= -		
Building Lot Coverage provided = (net lot area minus area of building footprint) ÷ (net lot area) Lot Size (in square footage)							
Gross Lan	d Area (GLA)						
Net Lo	ot Area (NLA)						
Floor Area Ratio	o (FAR) – as	applicable. (Check which	us	ed for residen	tial: 🗆 GLA, or	□ NLA
	Residential FAR Ratio	Residential Squa	re Footage		Non- Residential FAR Ratio	Non-Residential Squ	are Footage
Base Allowed	PLEASE	REFER TO	ATTACHED				
Base Provided	E	XHIBIT FOR	FAR				
Bonus Allowed	CALCU	LATIONS ANI	O UTILIZED				
Bonus Provided		BONUSES					
Bonus FAR Pro	gram (check	bonus utilized if	applicable)				
Transit Ground Floor Retail		Open Space and New Streets]	Community Center Facilities	Workforce Housing	
Residential Units					Total Provided:		
Number of Units Provided (without bonus)							
Number	of Bonus Units	Provided (without	workforce housi	ng)			
Number of Bonu	ıs Workforce H	ousing Units Provi	ded (20% require	ed)			
		Total Numb	er of Units per A	cre			
Building Covera	age 🗆 or	Lot Coverag	e 🗆 (chec	k ap	pplicable as requ	ired per zoning distr	rict)
			Percentage (%)			Square Footage
Max. Permitted							
Provided							
Fenestration (%	of each stree	t-fronting facade	calculated sepa	rate	ly, per district re	gulations)	
	Residential Façade Percentage (%)			Non-residential Façade Percentage (%)			
	Local Street	Arterial/Collector	Beltline Corrid	or	Local Street	Arterial/Collector	Beltline Corridor
Min. Required							
Provided (specify for each street)							



City of Atlanta Office of Zoning & Development SPECIAL ADMINISTRATIVE PERMIT (SAP) APPLICATION

Development Controls Specifications (Required)

File #	

Residential Open Space Requirements (refer to Chapter 28 for clarification)

Definitions and Methods of Calculation

- **LUI** = Land Use Intensity Ratios Table (per Section 16-08 R-G District Regulations)
- TOSR are calculated only for residential developments. TOSR includes the total horizontal area of uncovered open space plus ½ of the total horizontal area of covered open space subject to the limitations in Section 16-28.010 (4). Covered total open space is the open space closed to the sky but having two clear unobstructed open or partially open (50% or more) sides.
 - TOSR required = (LUI table) X (GLA).
 - TOSR provided = (GLA) (area of building footprint) + (combined area of balconies and rooftop terraces).
- UOSR requirements are calculated using the residential FAR (of the corresponding net lot or GLA lot sized used to calculate FAR) for both residential and mixed-use developments. It does not include areas for vehicles. However, newly created on-street parking (outside of existing travel lanes) and new streets may be counted towards the UOSR calculations as specified in the district regulations.

 UOSR required = (LUI table) X (the corresponding lot size used to calculate FAR). If GLA is used for USOR, than the amount provided shall be = (NLA) – (area of building footprint + surface area of parking lots, and driveways) + (balconies, rooftop terraces, and landscaped areas on sidewalks within the adjacent right-of-way). 						
	TOSR: Total Open Space Requirements for Residential Only Projects					
(Not required in SF		RC, MR, or LW districts, or in mixed-use developments.)				
	Ratio	Total Square Footage				
Minimum Required						
Provided						
Square Footage b	reakout of UNCOVERED TOSR amount prov	rided by the following:				
	GLA minus building square footage					
Open exterior	r balconies (per Section 16-28 or district regs)					
	Roof area improved as recreation space					
Square Footage b	preakout of COVERED TOSR amount provide	ed by the following:				
	ed to the sky (roof) but having two sides with a minimum of 50% open					
	e Open Space Requirements for Res	sidential and or Mixed-use Developments				
	Ratio	Total Square Footage				
Minimum Required						
Provided						
Square Footage E	Breakdown of UOSR amounts provided by th	e following:				
	Balconies	-				
	Rooftop Terraces					
	Landscaped Areas and Plazas					
	Portions of Sidewalks on Private Property					
Portions of L	andscaped Areas in Right-of-way adjacent to Property					



City of Atlanta Office of Zoning & Development SPECIAL ADMINISTRATIVE PERMIT (SAP) APPLICATION

Development Controls Specifications (Required)

File #	

Non-Residential Public Space Requirements (refer to Chapter 28 for clarification)

PSR: Public Space Requirements for Non-residential & Mixed-use Developments (These are areas not counted towards UOSR)								
Public Space provided :	Public Space provided = (square footage area of exterior space) + (square footage area of interior space)							
	Percentage (%) Total Square Footage							
Minimum Required								
Provided								
Square Footage Breakd	own of PSR amounts pro	vided by the	following:					
areas, plazas, terraces,	EXTERIOR (accessible to general public such as landscaped areas, plazas, terraces, patios, observation decks, fountains, sidewalks, common areas, open recreational spaces, etc.)							
during normal business lobbies, concourses, pla	area accessible to the gel hours such as malls, gall aza, walkways, fountains, on, pedestrian seating, or	eries, atria, landscape						
Parking and Lo	ading Requireme	ents (refer t	to district regu	ılations and Chapter 28 for	clarification)			
Residential Unit Breako	ut							
Number of Studios	Number of 1 BR	Num	nber of 2 BR	Number of 3 BR	Number of 4 BR			
On-site Parking Spaces		I	Residential	Non-residential Uses				
Minimum Required								
Provided								
Maximum Allowed								
Bicycle Parking Spaces		J	Residential		Non-residential Uses			
Minimum Required								
Provided								
On-site Loading Spaces	(see applicable zoning dis	trict requireme	ents or Sectio	n 16-028.015)				
	Residential/Hotel Non-residential Uses (break out by u							
Minimum Required (specify for each use)								
Provided (specify for each use)								



City of Atlanta Office of Zoning & Development SPECIAL ADMINISTRATIVE PERMIT (SAP) APPLICATION Notice to Applicant

Notice to Applicant

Fi	le	#	

The applicant hereby acknowledges notification that in the process of design review in connection with the issuance of a **Special Administrative Permit (SAP)**, the City of Atlanta Office of Zoning & Development (OZD) will only review such documents as are deemed necessary for the approval of a project concept in compliance with the district regulations set forth in the City of Atlanta Zoning Code. Such documents may include, without limitation, the elevations of the structures proposed and site plans specifying the arrangement of such structures and other features of the project, but generally will not include a full set of construction drawings. This level of review is for the purpose of determining compliance with those sections of the Zoning Code applying to the district where the project is located or to be located and to allow the applicant the flexibility to receive approval for a project concept without the requirement that a full set of construction drawings, that would otherwise be necessary to obtain a building permit, be prepared, presented and reviewed.

It is the applicant's duty to ensure that all drawings or plans, that may be required for further permitting of the actual construction of the project, will result in a finished project that complies with the elevations, site plan and other plans on which the SAP was granted. The applicant is further notified that neither the Office of Buildings nor any of the other City of Atlanta agencies that review any other part of the overall project plans for compliance to building codes, zoning codes, the tree preservation, the riparian buffers ordinance, land disturbance regulations, drainage and sewer capacity or any other regulations in effect at the time of plan review have the authority to approve any changes to the exterior appearance of structures or site plans in a SAP.

It is the responsibility of the applicant to ensure that any changes required, requested, or allowed by any other City agency or any other agency reviewing the plans during any part of the building permit process will not alter the exterior appearance of any structure or cause the relocation, rearrangement and/or reorientation of any feature of the site plan. Therefore, it is important for the applicant to be aware that even changes which may be in compliance with other codes, including without limitation, an increase to the height of the structure, whether resulting from changes to the foundation plan or the grading plan of the site, alterations to the interior layout of the structure that affect the location or size of exterior doors or windows, or changes to the method of construction for any floor of a structure or the roof of any structure, may affect the exterior appearance in a manner which could cause the finished structure to be out of compliance with the elevations approved by the OZD.

The applicant is further put on notice that the location of any feature specified on the site plan is not to be changed from that location which is specified on the site plan approved by the OZD. This includes, without limitation, any such changes that might affect the setbacks of any structure, the orientation of structures or features on the lot, including, without limitation, accessory buildings, the location and size of driveways, walkways, fences, parking pads, parking spaces, loading zones and service areas. It shall be the responsibility of the applicant to ensure that any changes required by any agency reviewing plans for the project remain consistent with the site plan and elevations approved by the OZD

It shall be the responsibility of the applicant, not the OZD, to monitor any plan changes during the permitting of the project to be sure that such changes do not affect the elevations and site plan approved by the OZD at the time of issuance of the SAP.

It is also the responsibility of the applicant to ensure that any changes made on site during the construction of the project, regardless of whether such changes are approved by a City building inspector, or representative of another City agency as being in compliance with the building codes or other applicable codes, do not result in a change to the exterior appearance of a structure or in a change to the site plan. The City of Atlanta Zoning Ordinance provides a process under which changes to the elevations and site plan in a SAP may be approved, however such approval is not guaranteed and the applicant is hereby notified that such changes are based on the application of the district regulations and not on the fact that a hardship, financial or otherwise may result if such permission is not given. The duty to adequately monitor the construction of the project to ensure compliance to the approved SAP and or any other City permit shall at all times be on the applicant, who assumes all risk of loss, financial or otherwise, from enforcement actions that result from the failure to comply with the SAP or any other City permit.

The applicant acknowledges that relief from any stop work order or other enforcement action, whether resulting from action taken by the OZD staff, the Office of Buildings staff or by the staff of any other City agency, must be appealed within the time and in the manner provided by the City Code. The applicant further acknowledges that the decision to apply to the OZD for permission to alter the approved plans is not an appeal of a stop work order or other enforcement action. The applicant acknowledges that it is solely within their own discretion to choose a process to resolve any dispute arising from the interpretation of any ordinance, the issuance of a stop work order or any other enforcement action and that the resolution of any such matter shall be made in compliance with the City Code and other applicable laws. The applicant further acknowledges that no written or oral representation of any City officer, employee, agent or elected official can waive or modify the City Code.

Robert Vance	12Vk	9/14/2022	
Applicant Printed Name	Applicant Signature	Date	

Camden Paces: Phase Three Land Planning

FAR Analysis

Revised: September 13, 2022

Net Lot Area

11.50 acres

501,050 sf

Gross Lot Area

13.16 acres

572,796 sf Total FAR

687,355 sf

Camden Buckhead

Niles Bolton Associates

Atlanta, Georgia

404.365.7600

507,730 sf

179,625 sf

Remaining FAR:

New Streets Incentive*

(5sf GFA Bonus for each sf of new streets)

43,442 sf

217,210 sf

Delta for Phase 3

(Camden Andrews)

Camden Ph3 (Projected)

Delta:

396,835 sf

464,726 sf

- 67,891 sf

w/ FAR Bonus of

1.0

572,796 sf (with LEED Silver or Comparable)

2.2 1,260,151 sf

Available Bonuses:

Mixed-Use 0.5 **Shared Parking** 0.5 LEED Silver, Mixed Use 0.5 LEED Silver, Res Only 1.0

Remaining Area after bonuses are applied and Camden Buckhead and Camden Ph3 are removed:


287,695 sf

^{*} new streets and private streets that function as public streets... GFA bonus equal to 5 times the sf improved and/or dedicated

CAMDEN ANDREWS | SAP APPLICATION

55 EAST ANDREWS DRIVE, ATLANTA, GEORGIA, 30305

CAMDEN DEVELOPMENT, INC.

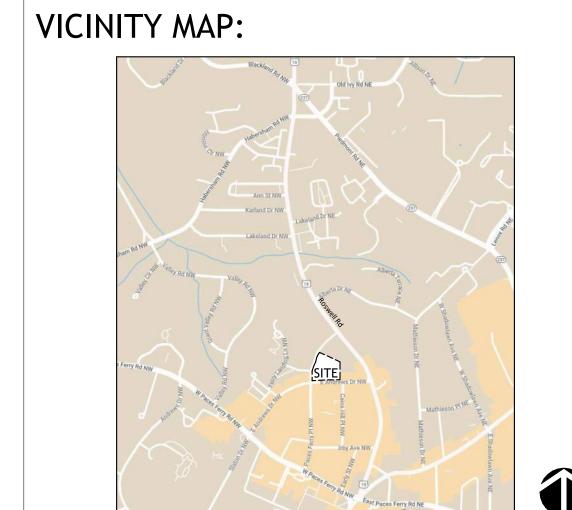

Britan Jay Ward

Ata aass

P-15-22

PROJECT #: 121394

DRAWN BY: PG, KU, NL, C

CHECKED BY: BW, CR

NILES BOLTON ASSOCIATES

CAMDEN

Living Excellence

Kimley»Horr

SHEET INDEX:

		SAP APP
SHEET NUMBER	SHEET NAME	(09/1
Sap application	1	
SAP_00	COVER SHEET	
N/A	CIVIL SHEET 1 - GEOSURVEY	
N/A	CIVIL SHEET 2 - EXISTING CONDITIONS PLAN	
C0-01	CIVIL SHEET 3 - SAP SITE PLAN	,
SAP_01	UNIT MATRIX	,
SAP_02	BUILDING FLOOR PLAN- LEVEL U2 PARKING	
SAP_03	BUILDING FLOOR PLAN- LEVEL U1 PARKING	
SAP_04	BUILDING FLOOR PLAN- LEVEL 1	
SAP_05	BUILDING FLOOR PLAN- LEVEL 2	
SAP_06	BUILDING FLOOR PLAN- LEVEL 3	
SAP_07	BUILDING FLOOR PLAN- LEVEL 4	
SAP_08	BUILDING FLOOR PLAN- LEVEL 5-10 TYPICAL	
SAP_09	BUILDING FLOOR PLAN- LEVEL 11	
SAP_10	BUILDING FLOOR PLAN- LEVEL 12	
SAP_20	ELEVATIONS - EXTERIOR	
SAP_21	ELEVATIONS - EXTERIOR	
SAP_22	ELEVATIONS - EXTERIOR	

.022)		
	Sι	060 Peachtree R uite 600 clanta, GA 30305
	Т	404 365 7600
	W	ww.nilesbolton.
	No.	Description
		SAP APPLICATION

This drawing, as an instrument of service, is and shall remain the property of the Architects and shall not be reproduced, published or used in any way without the permission of the Architect.

AMDEIN ANDREWS
55 E ANDREWS DRIVE
LANTA, GEORGIA 30305
FULTON COUNTY

JURISDICTION:

CITY OF ATLANTA, GEORGIA

BUREAU OF BUILDINGS 55 TRINITY AVENUE, SUITE 3900 ATLANTA, GA 30303 TEL: 404-330-6150 FAX: 404-658-6979

ZONING DISTRICT: SPI-9

DOCUMENT ISSUANCES:

09-15-2022 | SAP APPLICATION

SHEET TITLE:

SAP_00

COVER SHEET

09-15-2022



RENDERINGS ARE FOR ILLUSTRATIVE PURPOSES ONLY AND SHOULD NOT BE USED AS A GUIDE TO OR AN INTERPRETATION OF THE CONSTRUCTION DOCUMENTS

DEVELOPER

CAMDEN DEVELOPMENT
500 N. WEST SHORE BLVD.
SUITE 900
TAMPA, FLORIDA 33609
CONTACT: CHAD WEAVER
PHONE: (813)-286-5955

CIVIL ENGINEERING*

KIMLEY-HORN
11720 AMBER PARK DRIVE
SUITE 600
ALPHARETTA, GEORGIA 30009
CONTACT: BOB VANCE

ARCHITECTURE

NILES BOLTON ASSOCIATES
3060 PEACHTREE RD NW
SUITE 600
ATLANTA, GEORGIA 30305
CONTACT: KATHERINE UHRIN

PHONE: (404)-365-7600 x 180

MEP ENGINEERING

JORDAN SKALA ENGINEERS
4275 SHACKLEFORD ROAD
SUITE 200
NORCROSS, GEORGIA 30093
CONTACT: JEFFREY DAVISON
PHONE: (770)-447-5547


LANDSCAPE ARCHITECTURE*

KIMLEY-HORN
11720 AMBER PARK DRIVE
SUITE 600
ALPHARETTA, GEORGIA 30009
CONTACT: ERIC SHADE
PHONE: (404)-317-8427

STRUCTURAL ENGINEERING

1300 W SAM HOUSTON PKWY S
SUITE 600
HOUSTON, TEXAS 77042
CONTACT: STEPHAN VOSS
PHONE: (281)-407-5734

PHONE: (404)-451-7470

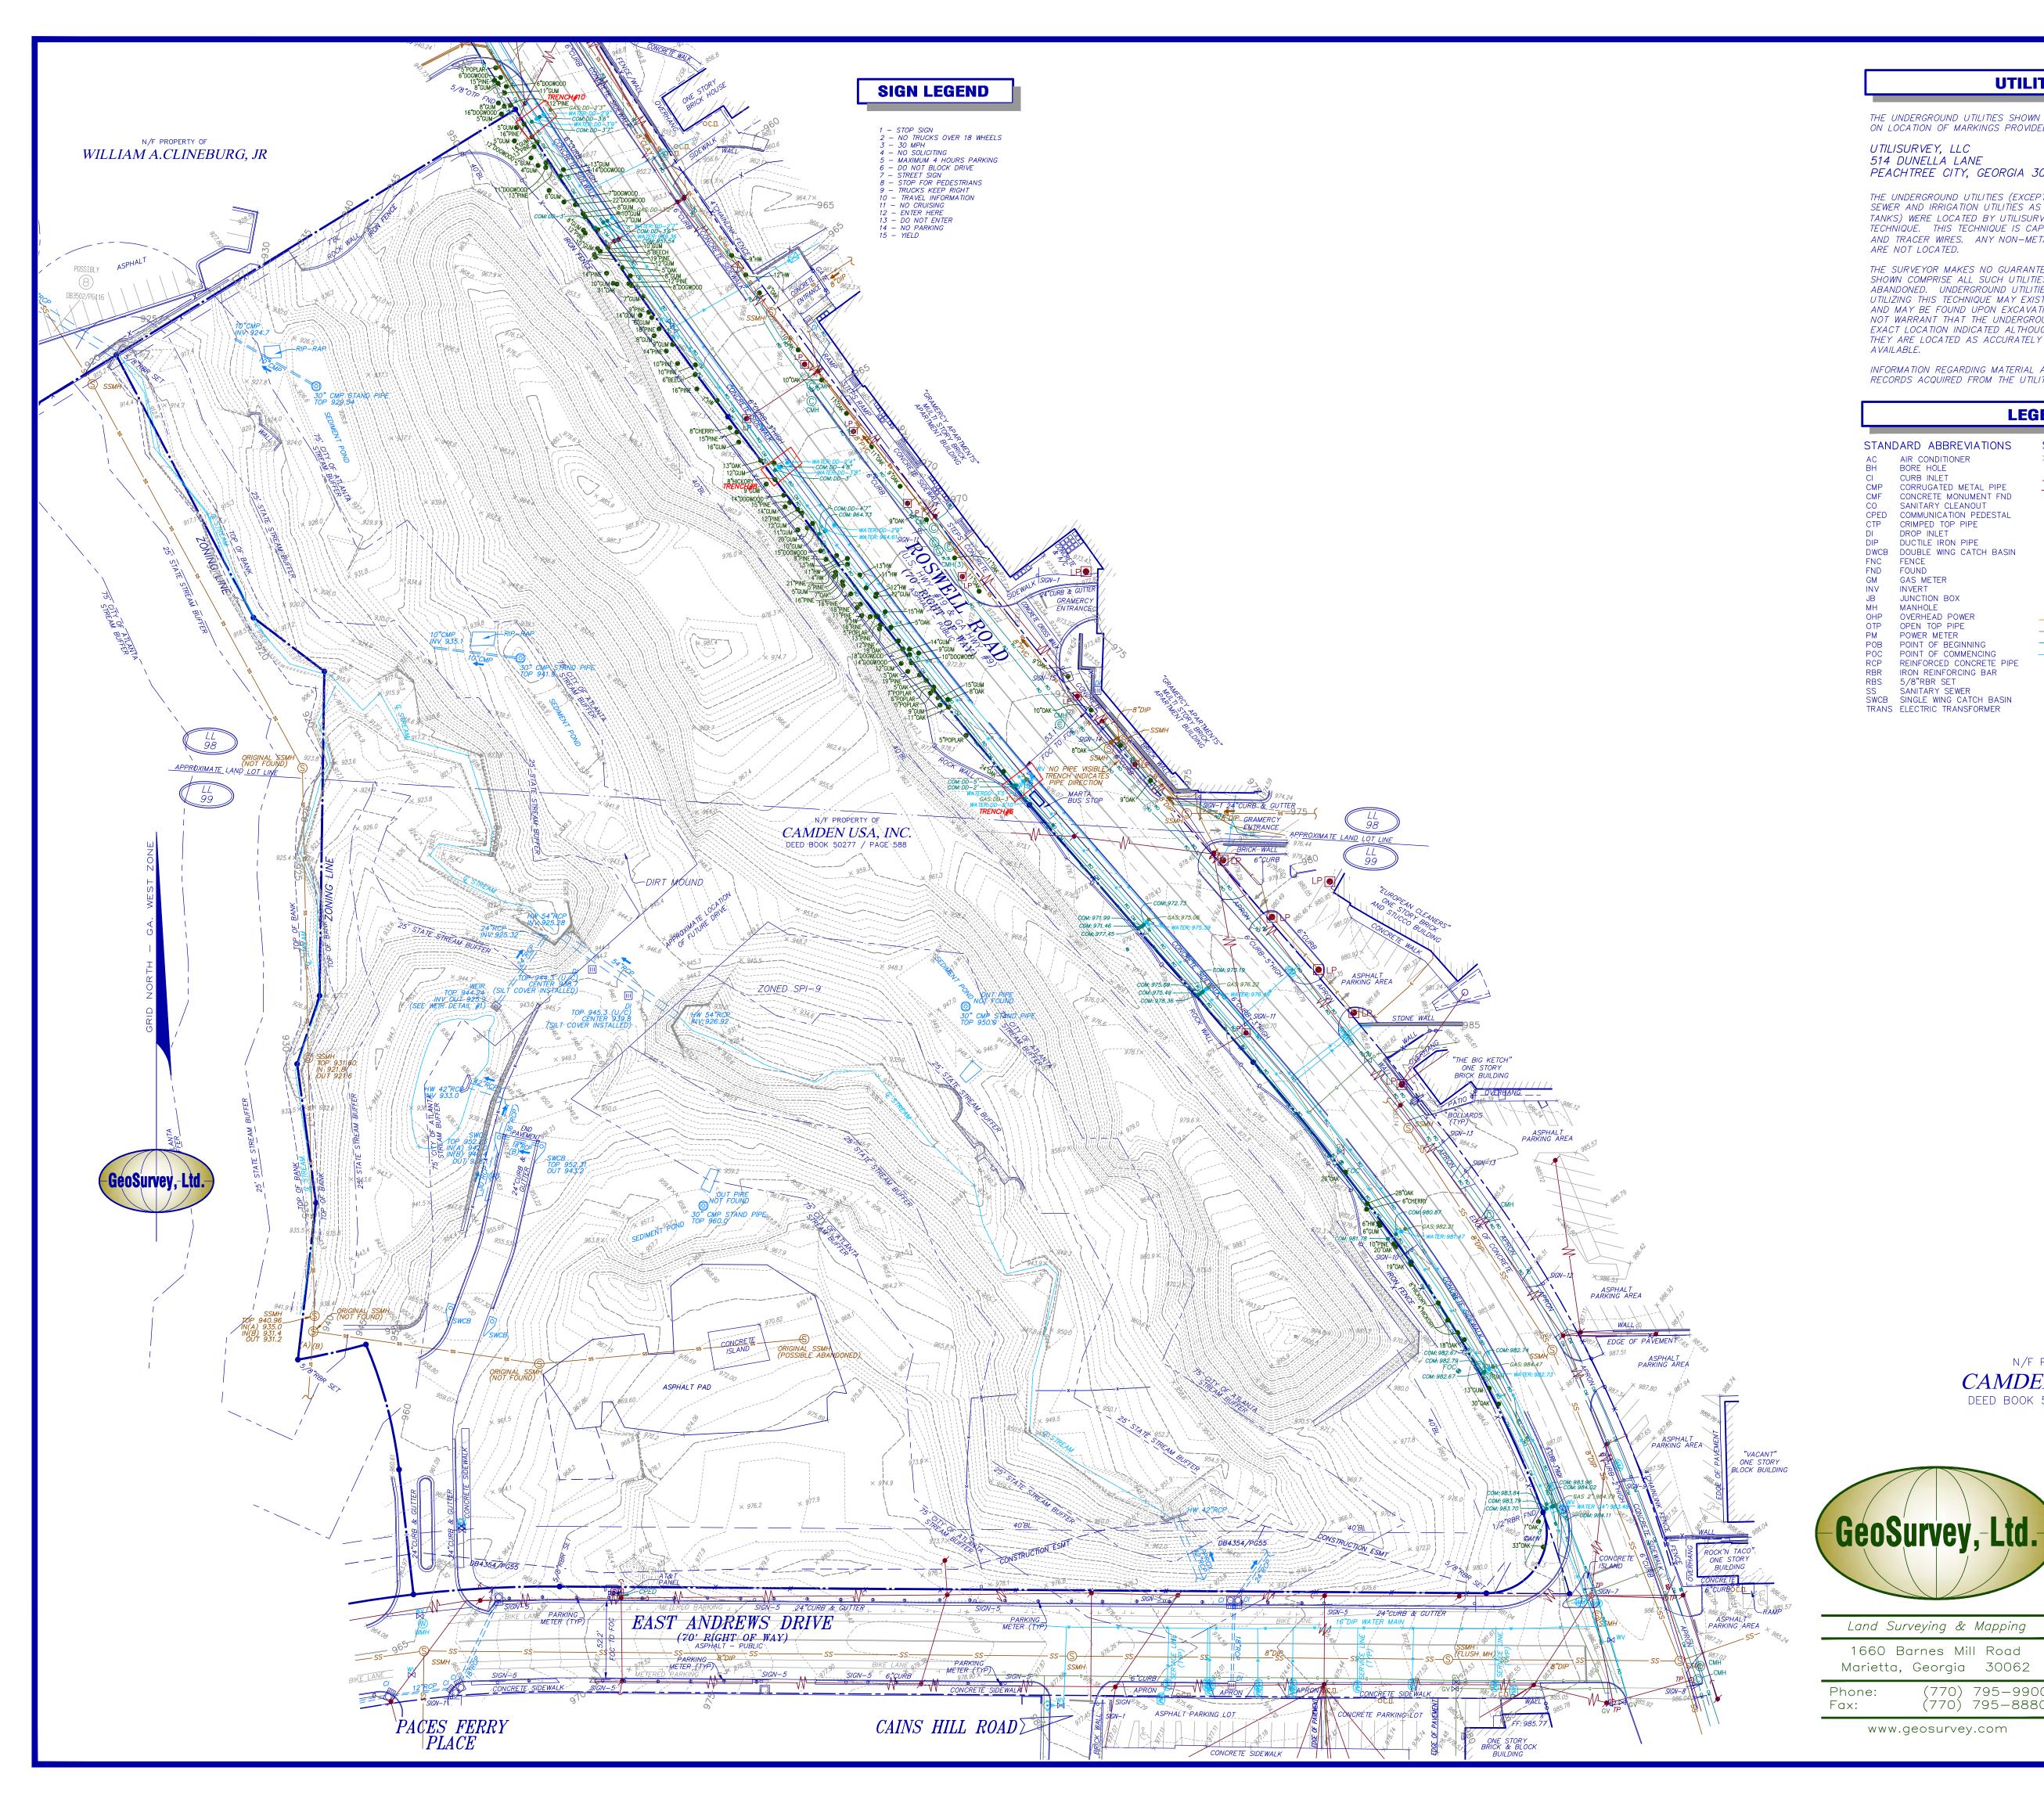

UTILITY NOTE

THE UNDERGROUND UTILITIES SHOWN HEREON ARE BASED ON LOCATION OF MARKINGS PROVIDED BY:

UTILISURVEY, LLC 514 DUNELLA LANE

PEACHTREE CITY, GEORGIA 30269

THE UNDERGROUND UTILITIES (EXCEPT THE LOCATION OF EXISTING DRAINAGE, SEWER AND IRRIGATION UTILITIES AS WELL AS UNDERGROUND STORAGE TANKS) WERE LOCATED BY UTILISURVEY, LLC. UTILIZING RADIO FREQUENCY TECHNIQUE. THIS TECHNIQUE IS CAPABLE OF LOCATING METALLIC UTILITIES AND TRACER WIRES. ANY NON-METALLIC UTILITIES (WITHOUT TRACER WIRE) ARE NOT LOCATED.

THE SURVEYOR MAKES NO GUARANTEES THAT THE UNDERGROUND UTILITIES SHOWN COMPRISE ALL SUCH UTILITIES IN THE AREA, EITHER IN-SERVICE OR ABANDONED. UNDERGROUND UTILITIES NOT OBSERVED OR LOCATED UTILIZING THIS TECHNIQUE MAY EXIST ON THIS SITE BUT NOT BE SHOWN, AND MAY BE FOUND UPON EXCAVATION. THE SURVEYOR FURTHER DOES NOT WARRANT THAT THE UNDERGROUND UTILITIES SHOWN ARE IN THE EXACT LOCATION INDICATED ALTHOUGH THE SURVEYOR DOES CERTIFY THAT THEY ARE LOCATED AS ACCURATELY AS POSSIBLE FROM INFORMATION

INFORMATION REGARDING MATERIAL AND SIZE OF UTILITIES IS BASED ON RECORDS ACQUIRED FROM THE UTILITY OWNERS.

LEGEND

STANDARD ABBREVIATIONS AC AIR CONDITIONER BH BORE HOLE CURB INLET CMP CORRUGATED METAL PIPE CMF CONCRETE MONUMENT FND LP LIGHT POLE SANITARY CLEANOUT

CPED COMMUNICATION PEDESTAL
CTP CRIMPED TOP PIPE CRIMPED TOP PIPE DROP INLET DUCTILE IRON PIPE DWCB DOUBLE WING CATCH BASIN FNC FENCE FND FOUND GM GAS METER

JUNCTION BOX OHP OVERHEAD POWER OPEN TOP PIPE POWER METER POB POINT OF BEGINNING POC POINT OF COMMENCING RCP REINFORCED CONCRETE PIPE

RBR IRON REINFORCING BAR RBS 5/8"RBR SET SS SANITARY SEWER
SWCB SINGLE WING CATCH BASIN
TRANS ELECTRIC TRANSFORMER

STANDARD SYMBOLS X 000.00 SPOT ELEVATION GUY WIRE — ₩ — POWER LINE

ELECTRIC TRANSFORMER

WATER VAULT GAS VALVE GAS METER WATER VALVE WATER METER FIRE HYDRANT

UNDERGROUND ELECTRIC LINE ---- G ---- UNDERGROUND GAS LINE ----CM---- UNDERGROUND COMMUNICATION LINE 1) PHOTO POSITION INDICATOR TREE POSITION INDICATOR

> SYSTEMS, AND BASED ON POSITIONAL VALUES FOR THE VIRTUAL REFERENCE STATION NETWORK DEVELOPED BY eGPS SOLUTIONS. THE HORIZONTAL REFERENCE FRAME IS NORTH AMERICAN DATUM OF 1983(HARN)-STATE PLANE COORDINATE SYSTEM OF GEORGIA-WEST ZONE. THE VERTICAL REFERENCE FRAME IS NORTH AMERICAN VERTICAL DATUM OF 1988. ANY DIRECTIONS OR DIMENSIONS SHOWN ARE A RECTANGULAR, GROUND LEVEL PROJECTION OF THE STATE PLANE COORDINATE SYSTEM.

GENERAL NOTES

THIS SURVEY HAS BEEN PREPARED FOR THE EXCLUSIVE USE OF THE PERSON

RESPECT TO THE INFORMATION SHOWN HEREON IS TO BE EXTENDED TO ANY

THIS SURVEY HAS BEEN PREPARED WITHOUT THE BENEFIT OF A CURRENT TITLE INSPECTION REPORT. EASEMENTS OR OTHER ENCUMBRANCES MAY EXIST ON

THIS PROPERTY IS NOT LOCATED IN A 100 YEAR FLOOD HAZARD AREA BASED ON THE FLOOD INSURANCE RATE MAP FOR THIS AREA. THE MAP NUMBERS

FOR THIS AREA ARE 13121C0232E AND 13121C0234E, AND THE DATE OF SAID

MAPS IS JUNE 22, 1998. THIS DETERMINATION WAS MADE BY GRAPHICALLY

THE DATUM FOR THIS SITE WAS ESTABLISHED UTILIZING GLOBAL POSITIONING

DETERMINING THE POSITION OF THIS SITE ON SAID FIRM MAPS UNLESS

OR ENTITIES NAMED HEREON. NO EXPRESS OR IMPLIED WARRANTIES WITH

PERSONS OR ENTITIES OTHER THAN THOSE SHOWN HEREON.

PUBLIC RECORD BUT NOT BE SHOWN HEREON.

VICINITY MAP

SITE LOCATION - LATITUDE: 33' 50' 39" LONGITUDE: 84' 23' 00"

THE SITE IS ZONED "RG-3" (RESIDENTIAL GENERAL DISTRICT). THE MINIMUM YARD SETBACKS ARE: FRONT - 40 FEET; SIDE AND REAR AS DETERMINED BY SECTION 16-28.011(5)(E) A AND B.

SURVEY REFERENCES

PLEASE NOTE: ZONING AND SETBACKS SHOULD BE CONFIRMED AND VERIFIED BY PLANNING AND ZONING PRIOR TO DESIGN OR CONSTRUCTION ACTIVITIES.

1> SURVEY FOR SOUTHERN CIVIL ENGINEERS, INC. AS PREPARED BY WATTS & BROWNING ENGINEERS, INC. DATED OCTOBER 26, 2011

GRAPHIC SCALE

CLOSURE STATEMENT

THIS PLAT HAS BEEN CALCULATED FOR CLOSURE AND WAS FOUND TO BE ACCURATE WITHIN ONE FOOT IN 465,947 FEET. CAJ INIT.

IF YOU DIG

N/F PROPERTY OF CAMDEN USA, INC. DEED BOOK 50277 / PAGE 588

(770) 795-9900 (770) 795-8880



Know what's **below**. **Call** before you dig. Dial 811 Or Call 800-282-7411


PARTIAL TOPO AND UTILITY SURVEY SURVEY OF


Camden Paces

FOR

Camden USA, Inc.

20124298	DRAWING SCAL	.E:	1 '	"= <i>50</i> "	SU	RVEY DAT	E: 03-06-2012
TB	CITY: ATLAN	<i>√TA</i>	STATE:	GEORGIA			REVISIONS
					No.		Description
CAJ	COUNTY:	FULTO.	N		2		REVISE ZONING ADDED PARTIAL TOPO & UTILITIES
IPC	LAND LOT:	08 %	00		3	04/16	ADDED PARTIAL TOPO & UTILITIES
UNC	LAND LOT.	<i>30</i> α			4	01/03/17	ADDED POTHOLE INFORMATION
20124298.dwg	DISTRICT:	17th					
	TB CAJ JRC	TB CITY: ATLAN CAJ COUNTY: JRC LAND LOT:	TB CITY: ATLANTA CAJ COUNTY: FULTO JRC LAND LOT: 98 &	TB CITY: ATLANTA STATE: CAJ COUNTY: FULTON JRC LAND LOT: 98 & 99	TB CITY: ATLANTA STATE: GEORGIA CAJ COUNTY: FULTON JRC LAND LOT: 98 & 99	TB CITY: ATLANTA STATE: GEORGIA No. CAJ COUNTY: FULTON 1 JRC LAND LOT: 98 & 99 3 4	TB CITY: ATLANTA STATE: GEORGIA No. Date 1 12/11/13 2 03/30/16 JRC LAND LOT: 98 & 99 3 04/16 4 01/03/17

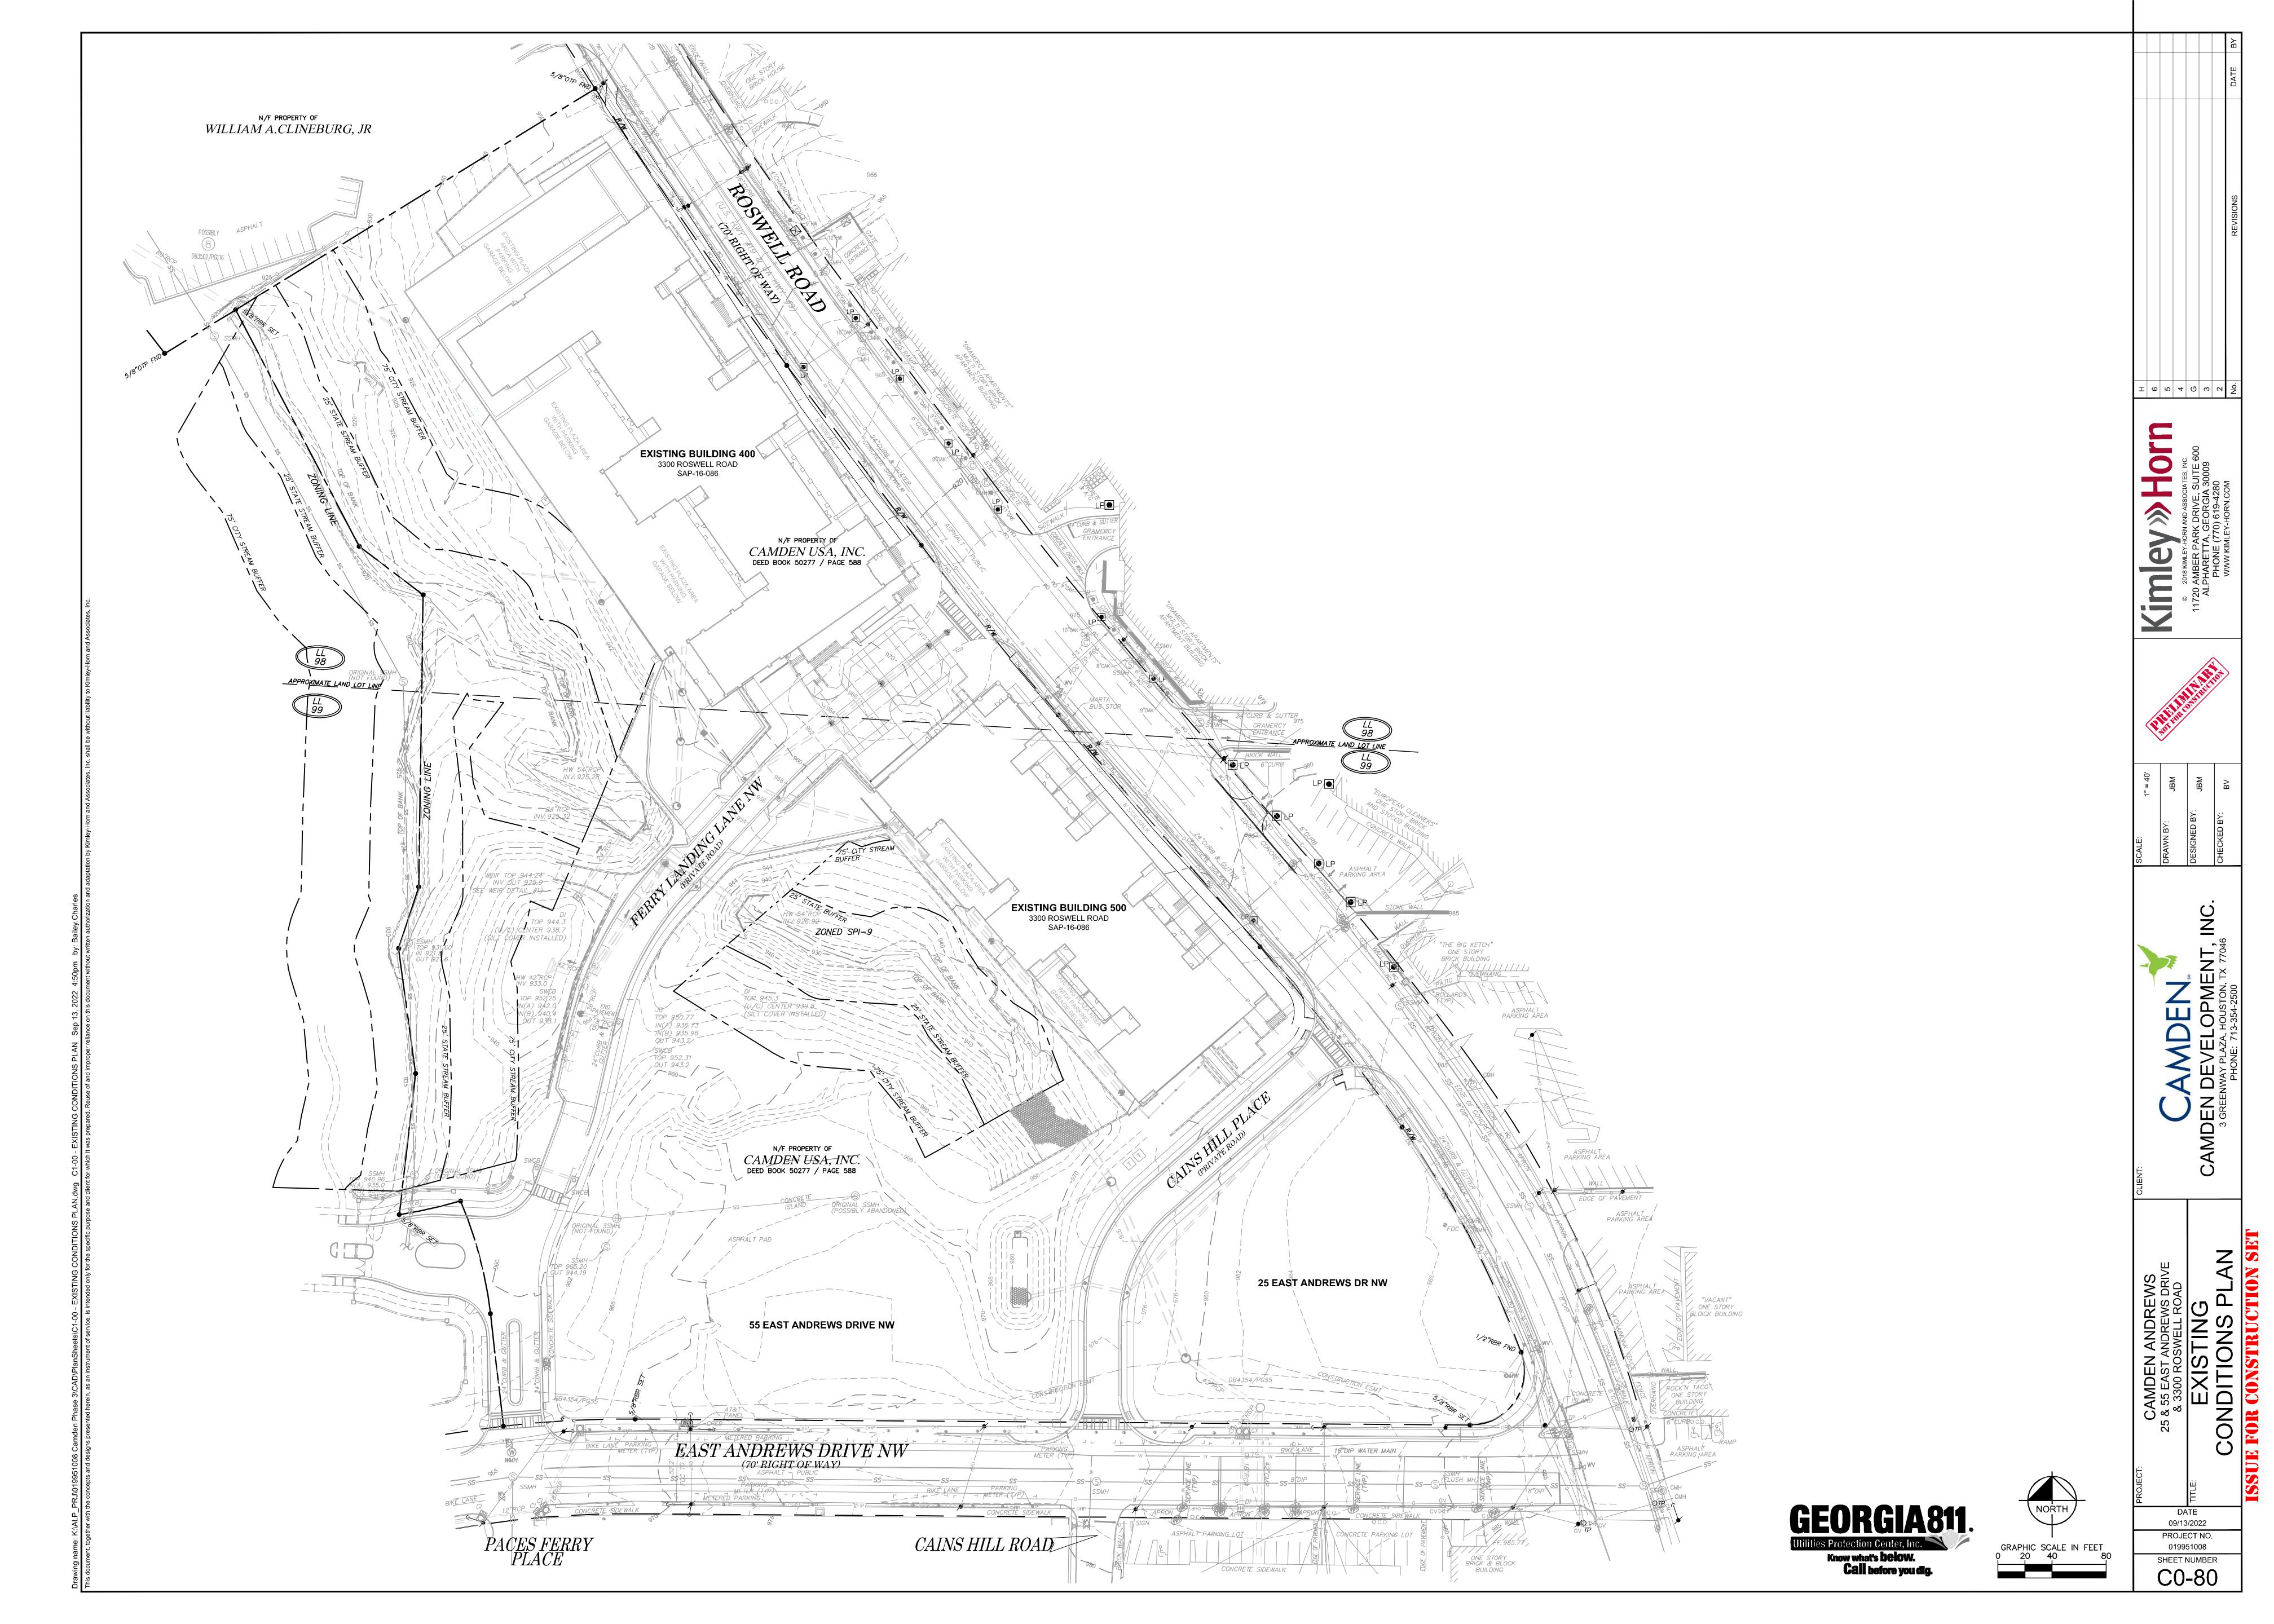

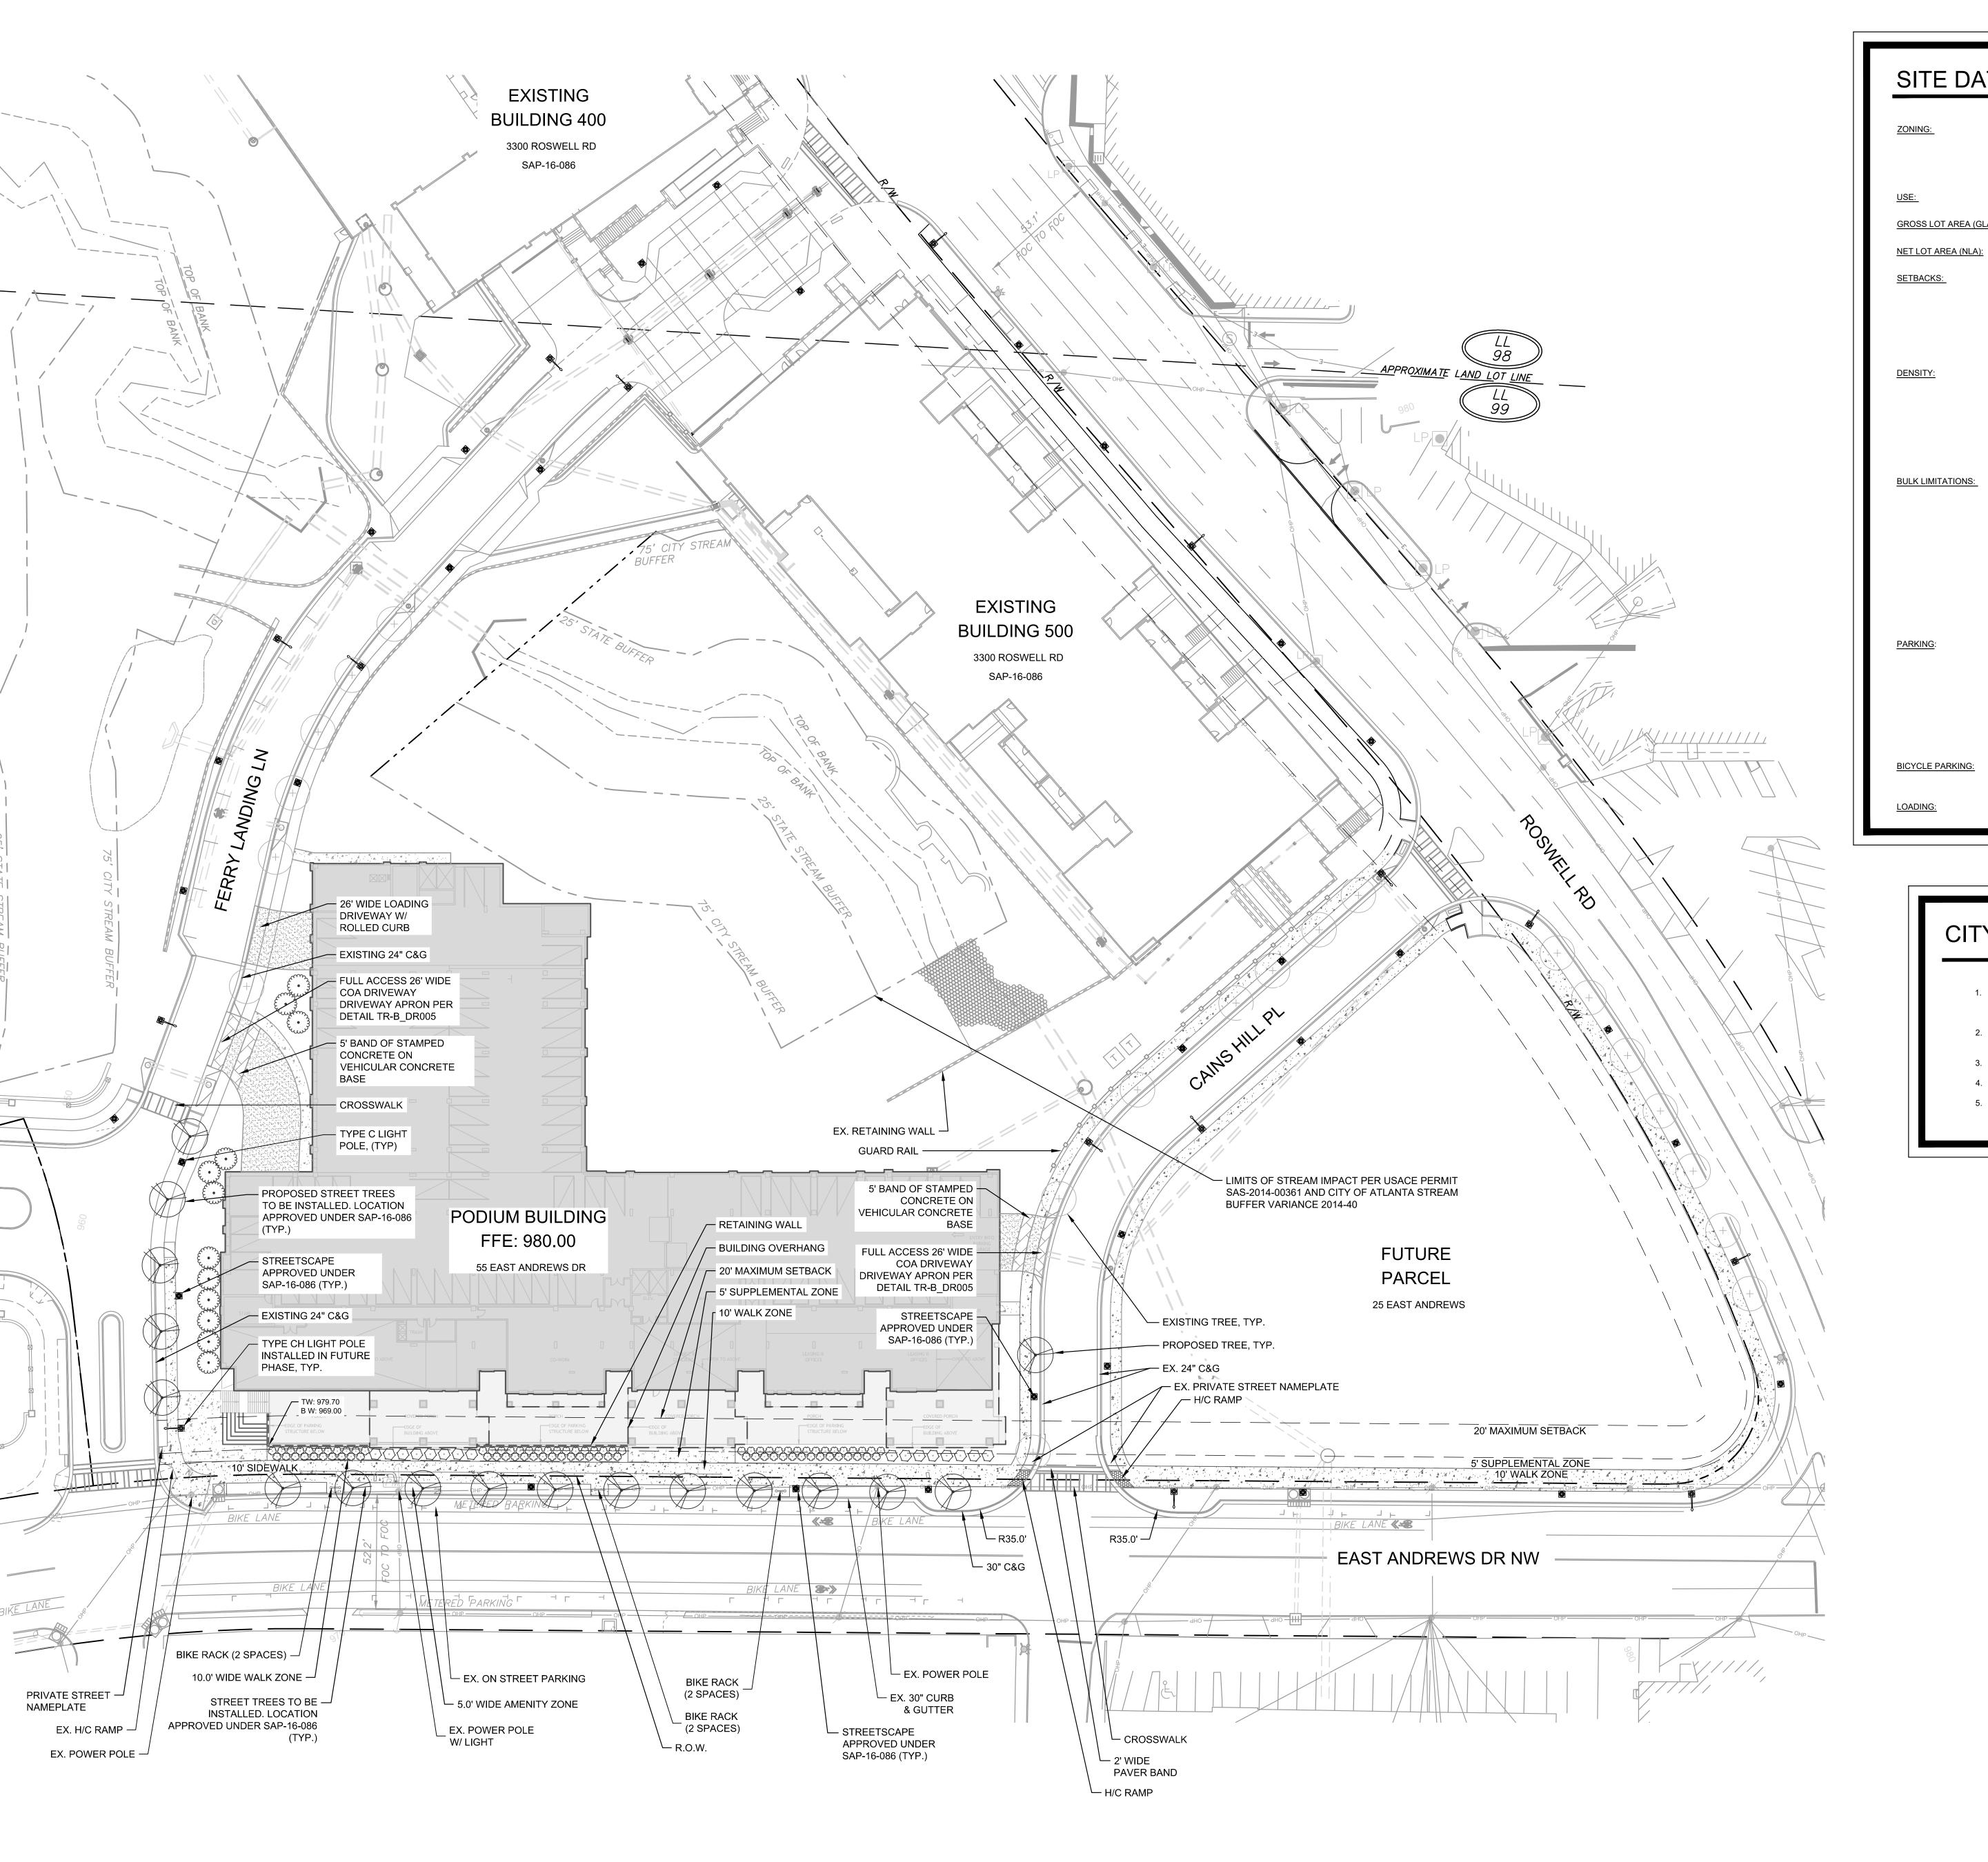

SITE DATA CHART

SPI-9 (BUCKHEAD VILLAGE DISTRICT) SUB AREA 2 (CORRIDOR AREAS) ROSWELL ROAD - TYPE 2 STREET

EAST ANDREWS DRIVE NW - TYPE 3 STREET

MULTI-FAMILY RESIDENTIAL DEVELOPMENT

13.15 ACRES (572,796 SF) GROSS LOT AREA (GLA):

11.50 ACRES (501,050 SF)

(EAST ANDREWS DRIVE NW SHOWN BELOW) 5' SUPPLEMENTAL FURNITURE ZONE

> 10' WALK ZONE 20' MAXIMUM SETBACK FROM THE WALK ZONE

5' AMENITY ZONE ON-STREET PARKING AND BICYCLE LANE

MULTI-FAMILY RESIDENTIAL (INCLUDES SAP-16-086)

DWELLING UNITS: 341 UNITS PROPOSED + 366 EXISTING = 707 TOTAL UNIT MATRIX (PROPOSED): UNIT MATRIX (SAP-16-086): 41 STUDIOS 225 ONE BEDROOMS

204 ONE BEDROOMS 136 TWO BEDROOMS 96 TWO BEDROOMS 5 THREE BEDROOMS 341 PROPOSED 366 EXISTING

BULK LIMITATIONS: MAX. BUILDING HEIGHT ALLOWED: 150 FT.

PROPOSED: 12 STORIES RESIDENTIAL (EXCLUDES SAP-16-086) MAX. FLOOR AREA RATIO (FAR) WITHOUT BONUSES: 1.2 x GLA = 687,355 SF

FAR WITH BONUS (1.0 W/ LEED OR COMPARABLE): 2.2 x GLA = 1,260,151 SF FAR PROVIDED: 972,456 INCLUDING SAP-16-086

MAX. BUILDING COVERAGE: NONE MIN. TOTAL OPEN SPACE REQUIRED: NONE

MIN. USABLE OPEN SPACE (RESIDENTIAL): 0.20 x GLA = 114,559 SF PROVIDED: 189,023 SF

MIN. PUBLIC SPACE (NON-RESIDENTIAL) REQUIRED: 0.1 x GLA = 57,300 SF

PROVIDED: 66,819 SF

MAX. ALLOWABLE PARKING (INCLUDES SAP-16-086):

1.25 SPACES FOR ONE BEDROOM UNITS x 470 (INCLUDES STUDIOS) = 586 SPACES 2.25 SPACES FOR TWO OR MORE BEDROOM UNITS x 237 = 534 SPACES

MAXIMUM ALLOWED PARKING: 1120 SPACES MINIMUM ALLOWED PARKING: 0.75 x 1120 = 840 SPACES

MINIMUM ACCESSIBLE SPACES REQUIRED: 20 SPACES MINIMUM ELECTRIC VEHICLE CHARGING SPACES REQUIRED: 10 SPACES

PARKING PROVIDED: 1004 SPACES (INCLUDES ACCESSIBLE AND ELECTRIC VEHICLE SPACES)

REQUIRED: 3 - 12' x 35' SPACES SAP-16-089 AND 2 - 12' x 35' SPACES PROPOSED, TOTAL 5 SPACES

MAXIMUM REQUIRED: 50 SPACES

PROVIDED: 50 SPACES SAP-16-086 AND 35 SPACES PROPOSED, TOTAL: 85 SPACES

CITY OF ATLANTA NOTES

THE STREET FURNITURE AND TREE PLANTING ZONE WILL HAVE BENCHES, LANDSCAPING, TRASH RECEPTACLES AND OTHER

PEDESTRIAN FRIENDLY AMENITIES. ALL INTERNAL SIDEWALKS WILL CONNECT TO EXISTING AND

MIN. 1.0 FOOT CANDLE LIGHTING THROUGHOUT PARKING FACILITY

BICYCLE RACKS WILL BE PROVIDED AT KEY LOCATIONS.

PROPOSED STREET SIDEWALKS.

TREE PLANTING SHALL BE 40' ON CENTER.

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No. PE36134

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CAMDEN 5 & 55 EAST A 8 3300 ROS


GEORGIA811

Know what's below. Call before you dig.

DATE 09/14/2022 PROJECT NO. 019951008 SHEET NUMBER

C0-01

	Proposed: Camden A	narews: 55	L Andrews	S DF					MILES	BOLTON ASSOCIATES				9/9/22					TOTALS
. 4						Unit	Mix - Alte	rnate Plans	La La								Building Areas		
				Ur	nit Count	Per Floor	r				Unit Area	\$	Total	Areas	Floors	Parking Areas	Circulation / Utility	Unit Gross Area	Unit GSF at Par
Туре	Description	U2 U	1 1 2	3	4 5	6 7	8 9	10 11 12	Total	Net	Balc.	Gross	Net	Gross				4 - 1 - 4 - 7 - 7 - 7	
	1BR 22' WIDE	4	0 4	4	7 7	7 7	7 7	7 7 7	71	734	176	910	52,114	64,610					
	1BR 25' WIDE	I I I I I I I I I	0 0	0	8 8	8 8	8 8	8 0 0	56	788	117	905	44,128	50,680	U2	44,573	11,926	0	
	1BR INSIDE CORNERS		0 1	5	7 7	7 7	7 7	7 3 3	61	805	117	922	49,105	56,242	U1	55,731	2,958	0	
	1BR INSIDE CORNER LG. (1+DEN)		0 1	0	0 0	0 0	0 0	0 4 4	9	927	120	1,047	8,343	9,423	1.	34,820	3,367	0	
	1 BR INSIDE CORNER		0 0	0	1 0	0 0	0 0	0 0 0	1	880	0	880	880	880	2	35,516	5,052	5,609	
	1 BR INSIDE CORNER (1+DEN)		0 0	0	0 1	1-1-	1 1 1	1 0 0	6	1,014	133	1,147	6,084	6,882	3	32,175	3,883	14,815	
										4.000	0.7	4 007	F. (000	F7 0/F	4		9,208	39,933	9,304
	2BR 2BA OUTSIDE CORNER		0 0	3	6 6	6 6	6 6	6 0 0	45	1,200	87	1,287	54,000	57,915	5	1	9,074	40,200	
2	2BR 2BA ROOMMATE PLAN (NOY CURRENTLY USED)		0 0	0	0 0	0 0	0 0	0 0 0	0	1,278	216	1,494	20.025	0	0 7		9,074	40,200	
3	2 BR 2 BA INSIDE CORNER		0 0	0	3 3	3 3	3 3	3 2 2	25	1,237	232 87	1,469	30,925	36,725	/		9,074	40,200	
4	OUTSIDE CORNER (E ANDREWS) 2BR 1 BA OUTSIDE CORNER		0 0	1	1 1	1 1	1 1	1 0 0	15	1,304	0/	1,391	19,560	20,865	0		9,074 9,074	40,200 40,200	
)	ZBR T BA OUTSIDE CORNER		0 0	U	1	ibs de	1 1 1 1 1	1 0 0		928	U	928	6,496	6,496	10				
						-			+ +						10		9,074 6,322	40,200 28,914	3,837
	1BR 1 BA STUDIO		0 0	1	2 2	2 2	2 2	2 0 0	15	579	52	592	8,685	8,880	12		5,203	17,704	3,03/
	1BR 1 BA STUDIO		0 0	0	1 1	1 1	1 1	1 0 0	7	524	0	524	3,668	3,668	12		3,203	17,704	
	1BR 1 BA STUDIO		0 0	1	2 2	7 7	2 2	2 2 2	19	577	144	721	10,963	13,699	Total	202,815	102,363	348,175	13,141
	TOIX T DA 310010		0 0		- -	2 2	L L	L L L	12	3//	130	721	10,703	13,077	Total	202,013	102,303	370,173	13,141
			+ + +	-							1				Efficiency at Typica	l Level (Level 5-10):			81.58%
H-1	2 STORY - LOFT			-	-	-		2 0	2	1,752	752	2,504	3,504		Total Project Net H				464,726
H-2	2 STORY - LOFT							2 0	2		002								
1-2	Z STORY - LOFT			1	->			2 0		2,198	903	3,101	4,396	6,202	Total Project Gross	Area			690,360
				-							1					1 5 6 6 6	or Office and Upsted Amenity	A.222	
					-		-				4		-		Lovel III	Leasi	ng Office and Heated Amenity	Areas:	
					+ +								ł		Level U1 Level 1		384 9,958		
+											1						9,936		
-		k		k - k			* *				X				Level 4		2 944		
4				-							4				Level 11		3,846		
									4						Level 12		0		
					_						*				Total:		14,188		
											*								
- K								 	+		+		-			ł:			
						-			+ +				1						
+				k k	4=				+ +										
													ł			-	xterior Amenity Space (Roofto	nn\	
	Total Units	. 0 0	0 6	15	10 10	40 40	40 40	40 22 18	341						Level 4		xterior Amenity space (Rootto	ib)	
	Total office		7 0 0	13.	40 40	40 40	40 40	40 22 10	341	Pontah	le at Apartm	ant Buildings	302,851	240 475		£	9,678		
								Avorago	Net Unit Size:	Rentab			302,851	348,175					
												Sq. Ft.			Total:		9,678		
									ross Unit Size:			Sq. Ft.		120/	,				
									edroom Units:		20-	No.		12%	-4				
									edroom Units:		20			28%					
								Total Two B	learoom ones.		130			20/0	0				
								To	otal Bedrooms:		43	1		100.0%	6				
								,,,	reat beardonis.		13			100.0%					
						Zo	oning										Parking Spaces:		
		Total Site A	Area							Usabl	e Open Space	Requiremen	ts		Parking Spaces Provide	ed			
				Net L	ot Area:			501,050		Required Usable Open			1	,559			00 Spaces		
			Gi	ross Lar				572,796		Square Footage I							14 Spaces/Unit		
		Max	x. Allowable	Area (F	AR 1.2):			687,355				Balconies		/A			12 Spaces/Bedroom		
	Area Used at Camden B							507,730							*Note: Leasing spaces				
		aining Area (Fo						179,625		Gree	n Roofs/Roo	top Teraces:	9,	678		No. 20 April 10 THE			
	GFA Bonus (Connectivity Improvement							217,210			ndscape Ared			948					
			Phase 3 (Cam					396,835			andscape Are		+						
	Prop	osed Area for						464,726			utside Buildi			572					
					Delta:			-67,891		Portions of Sidewalks on		77.	-	457					
			Ava	ailable B	onuses:						- 3-5	. 407							
	FAR Bonus (Section 16-181.013 LEED Silver or Sim.	= FAR 1.0 for n						572,796											
		ble Area (FAR						1,260,151											
		ing Area after						287,695		Portion	ns of Landsca	ped Areas in		44					
			A PARTY										2.4	762					
										רוטייווין א	way adjacent	to Property.	2,	703					
									10	Total Proposed Usable C			10.4	,418					

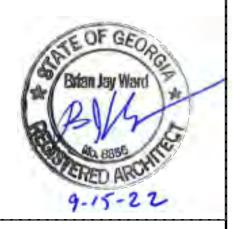

NILES BOLTON ASSOCIATES

CAMDEN

Living Excellence

Kimley » Horn

3060 Peachtree Rd. N.W. Suite 600 Atlanta, GA 30305

T 404 365 7600

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No. Description Date

SAP APPLICATION 9/15/2022

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55 E ANDREWS DRIVE
ATLANTA, GEORGIA 30305
FULTON COUNTY

SHEET TITLE:


UNIT MATRIX

SHEET NUMBER:

SAP_01

09-15-2022

9/14/2022 6:22:15 6:\Tomo\121304 CAMPEND2 ABCH NDA D22 CENTDAL

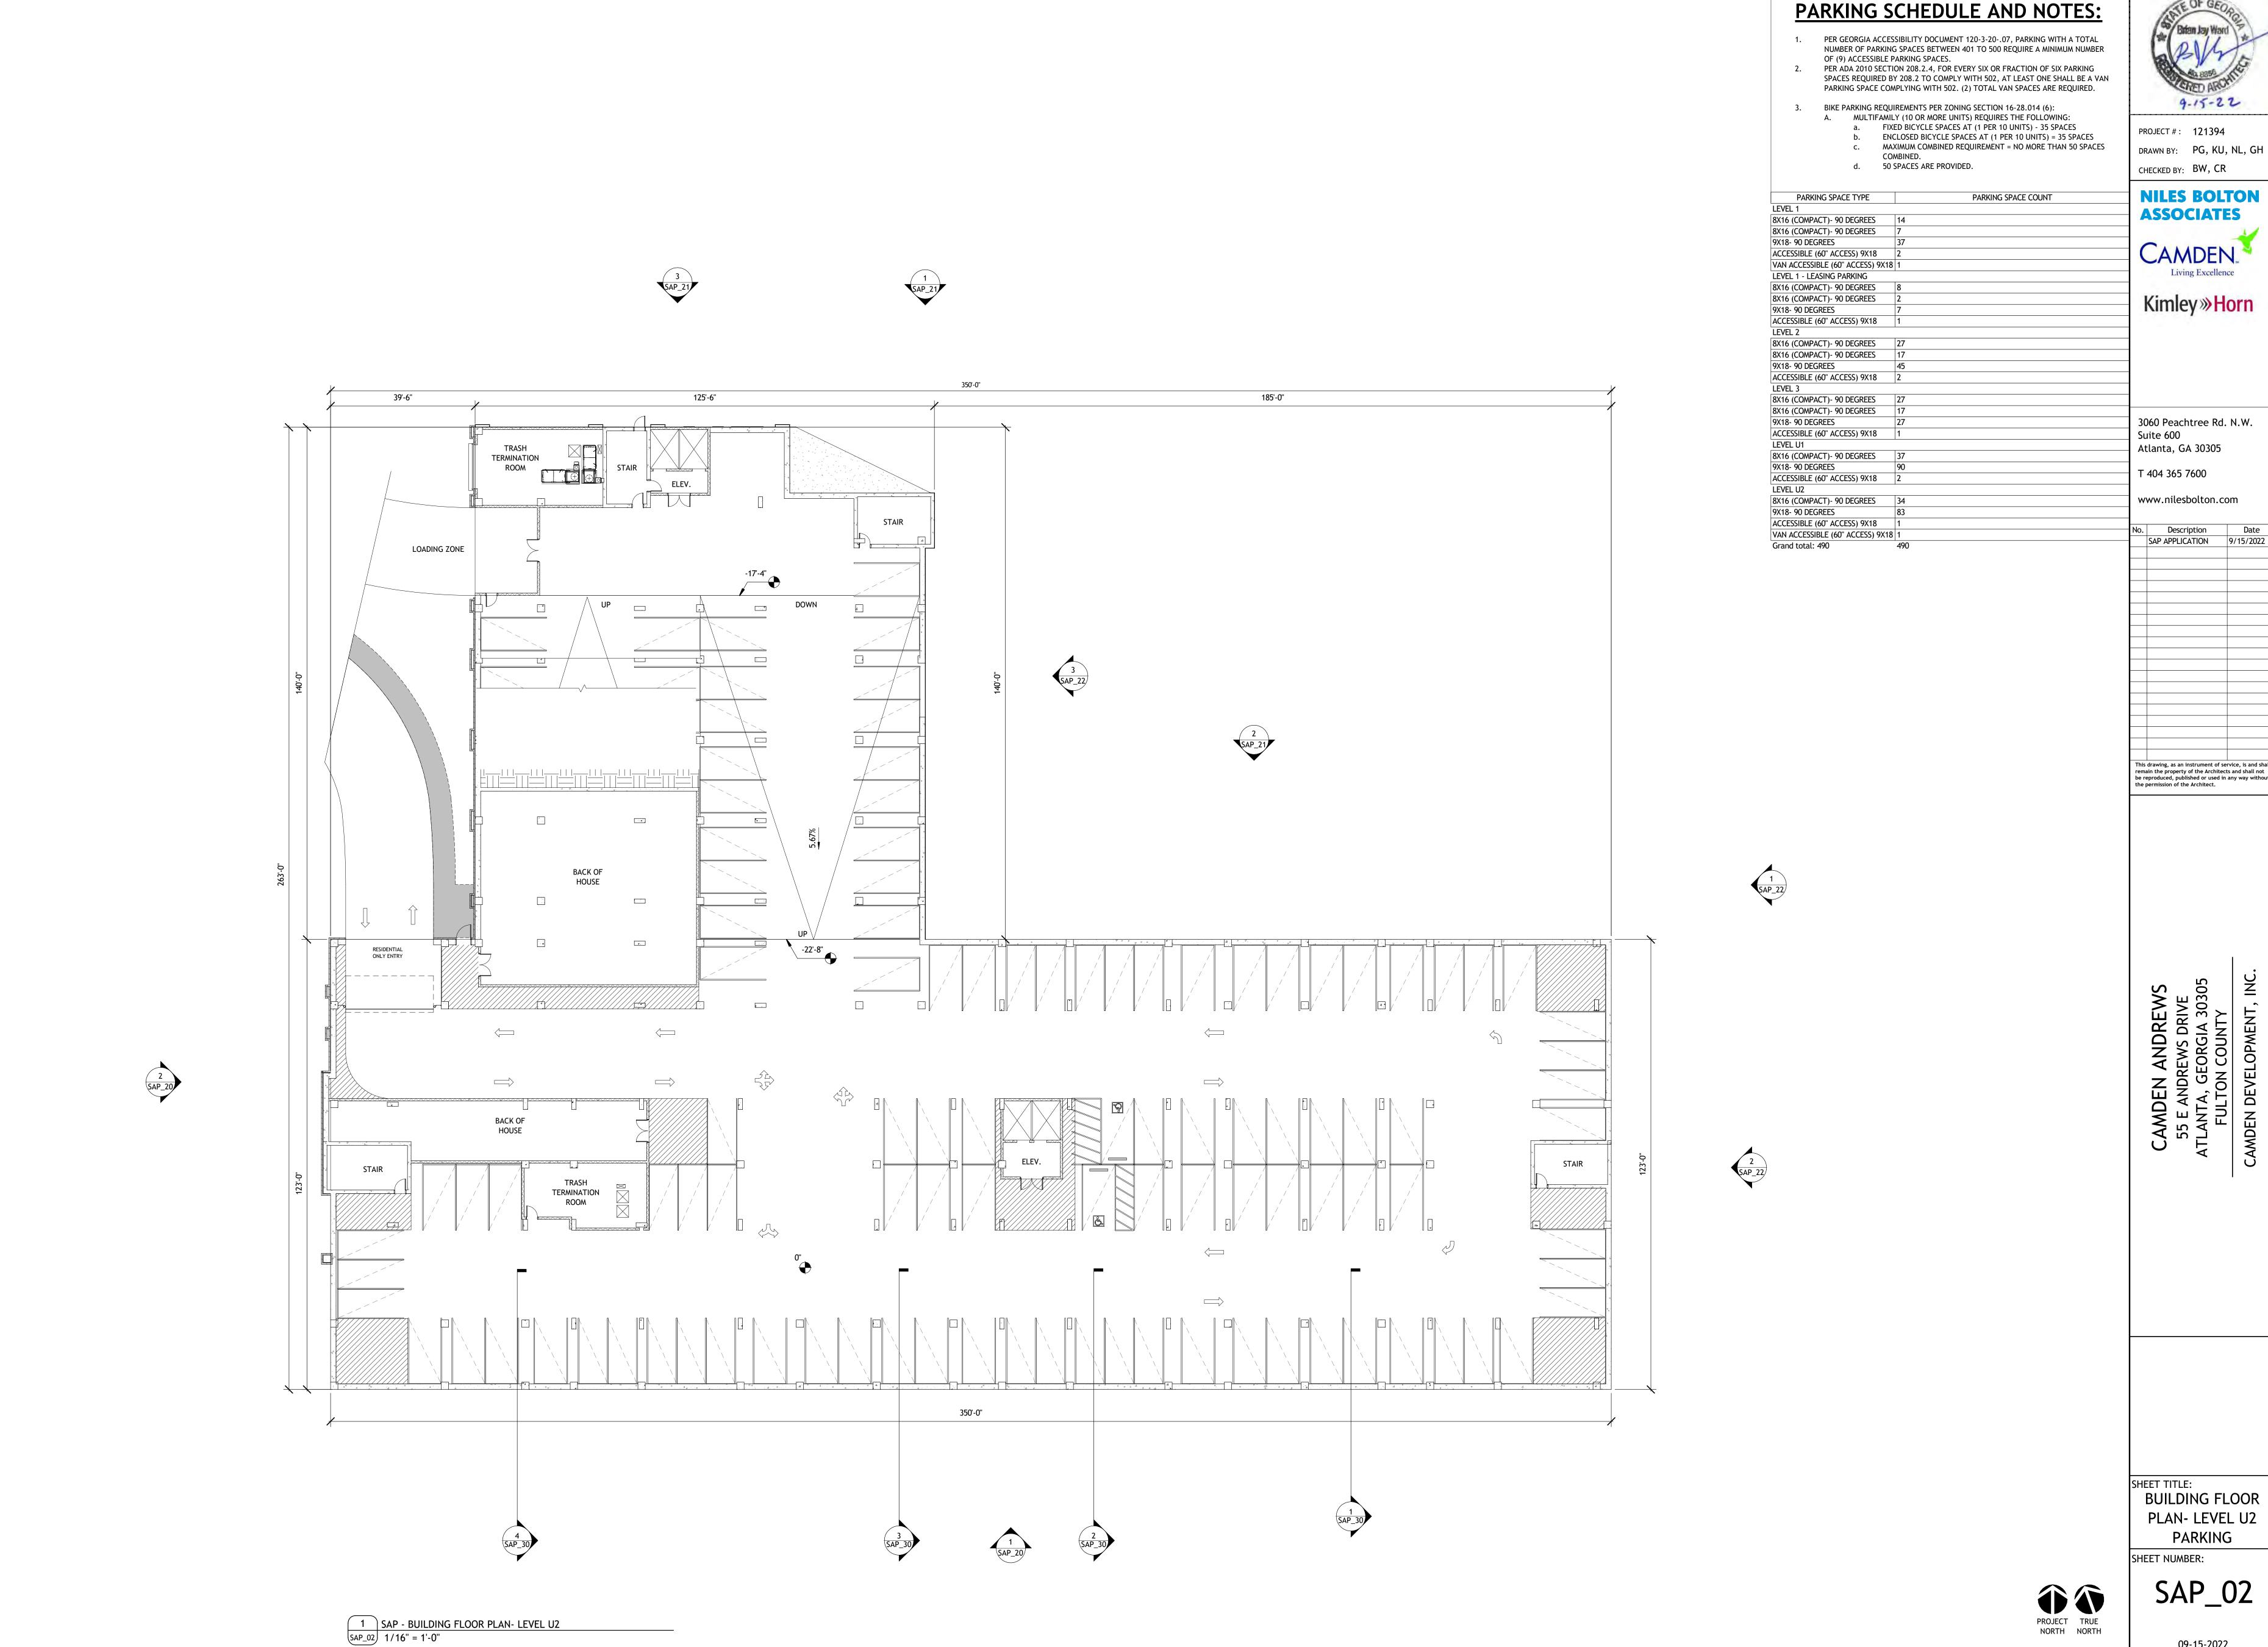



CHECKED BY: BW, CR **NILES BOLTON**


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SHEET TITLE:
BUILDING FLOOR PLAN- LEVEL U2







DRAWN BY: PG, KU, NL, GH

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PLAN- LEVEL U1

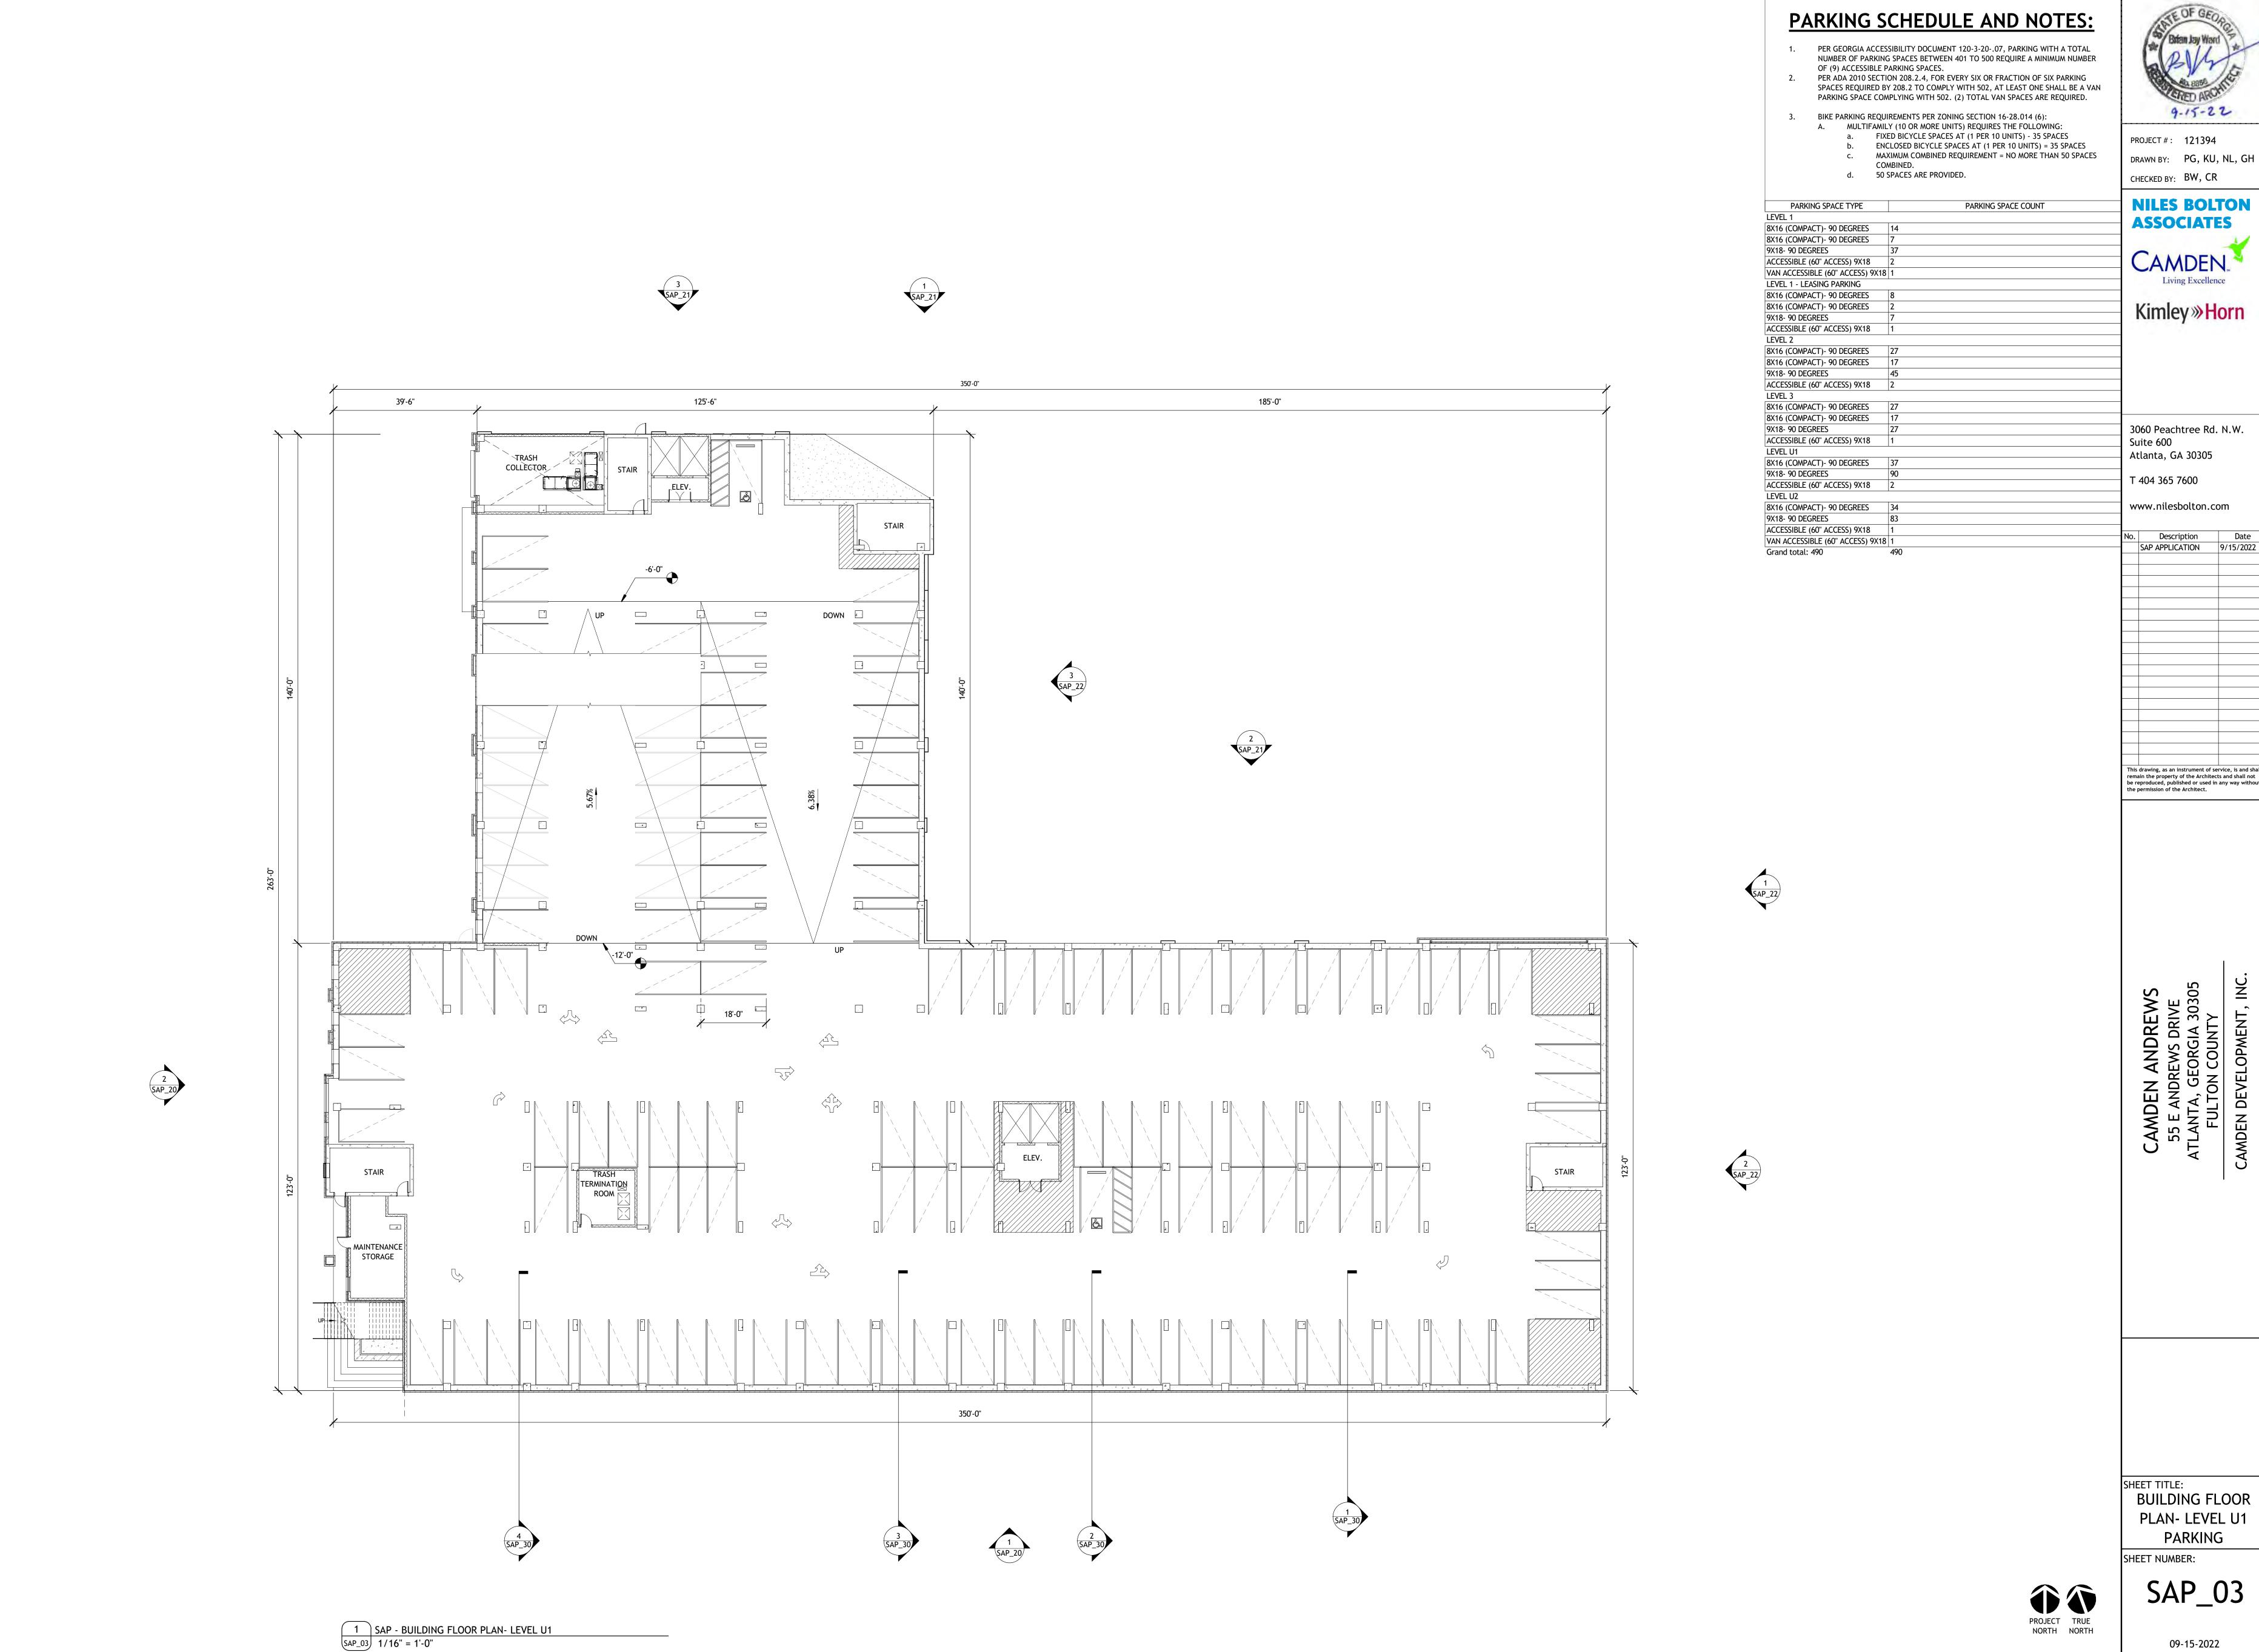

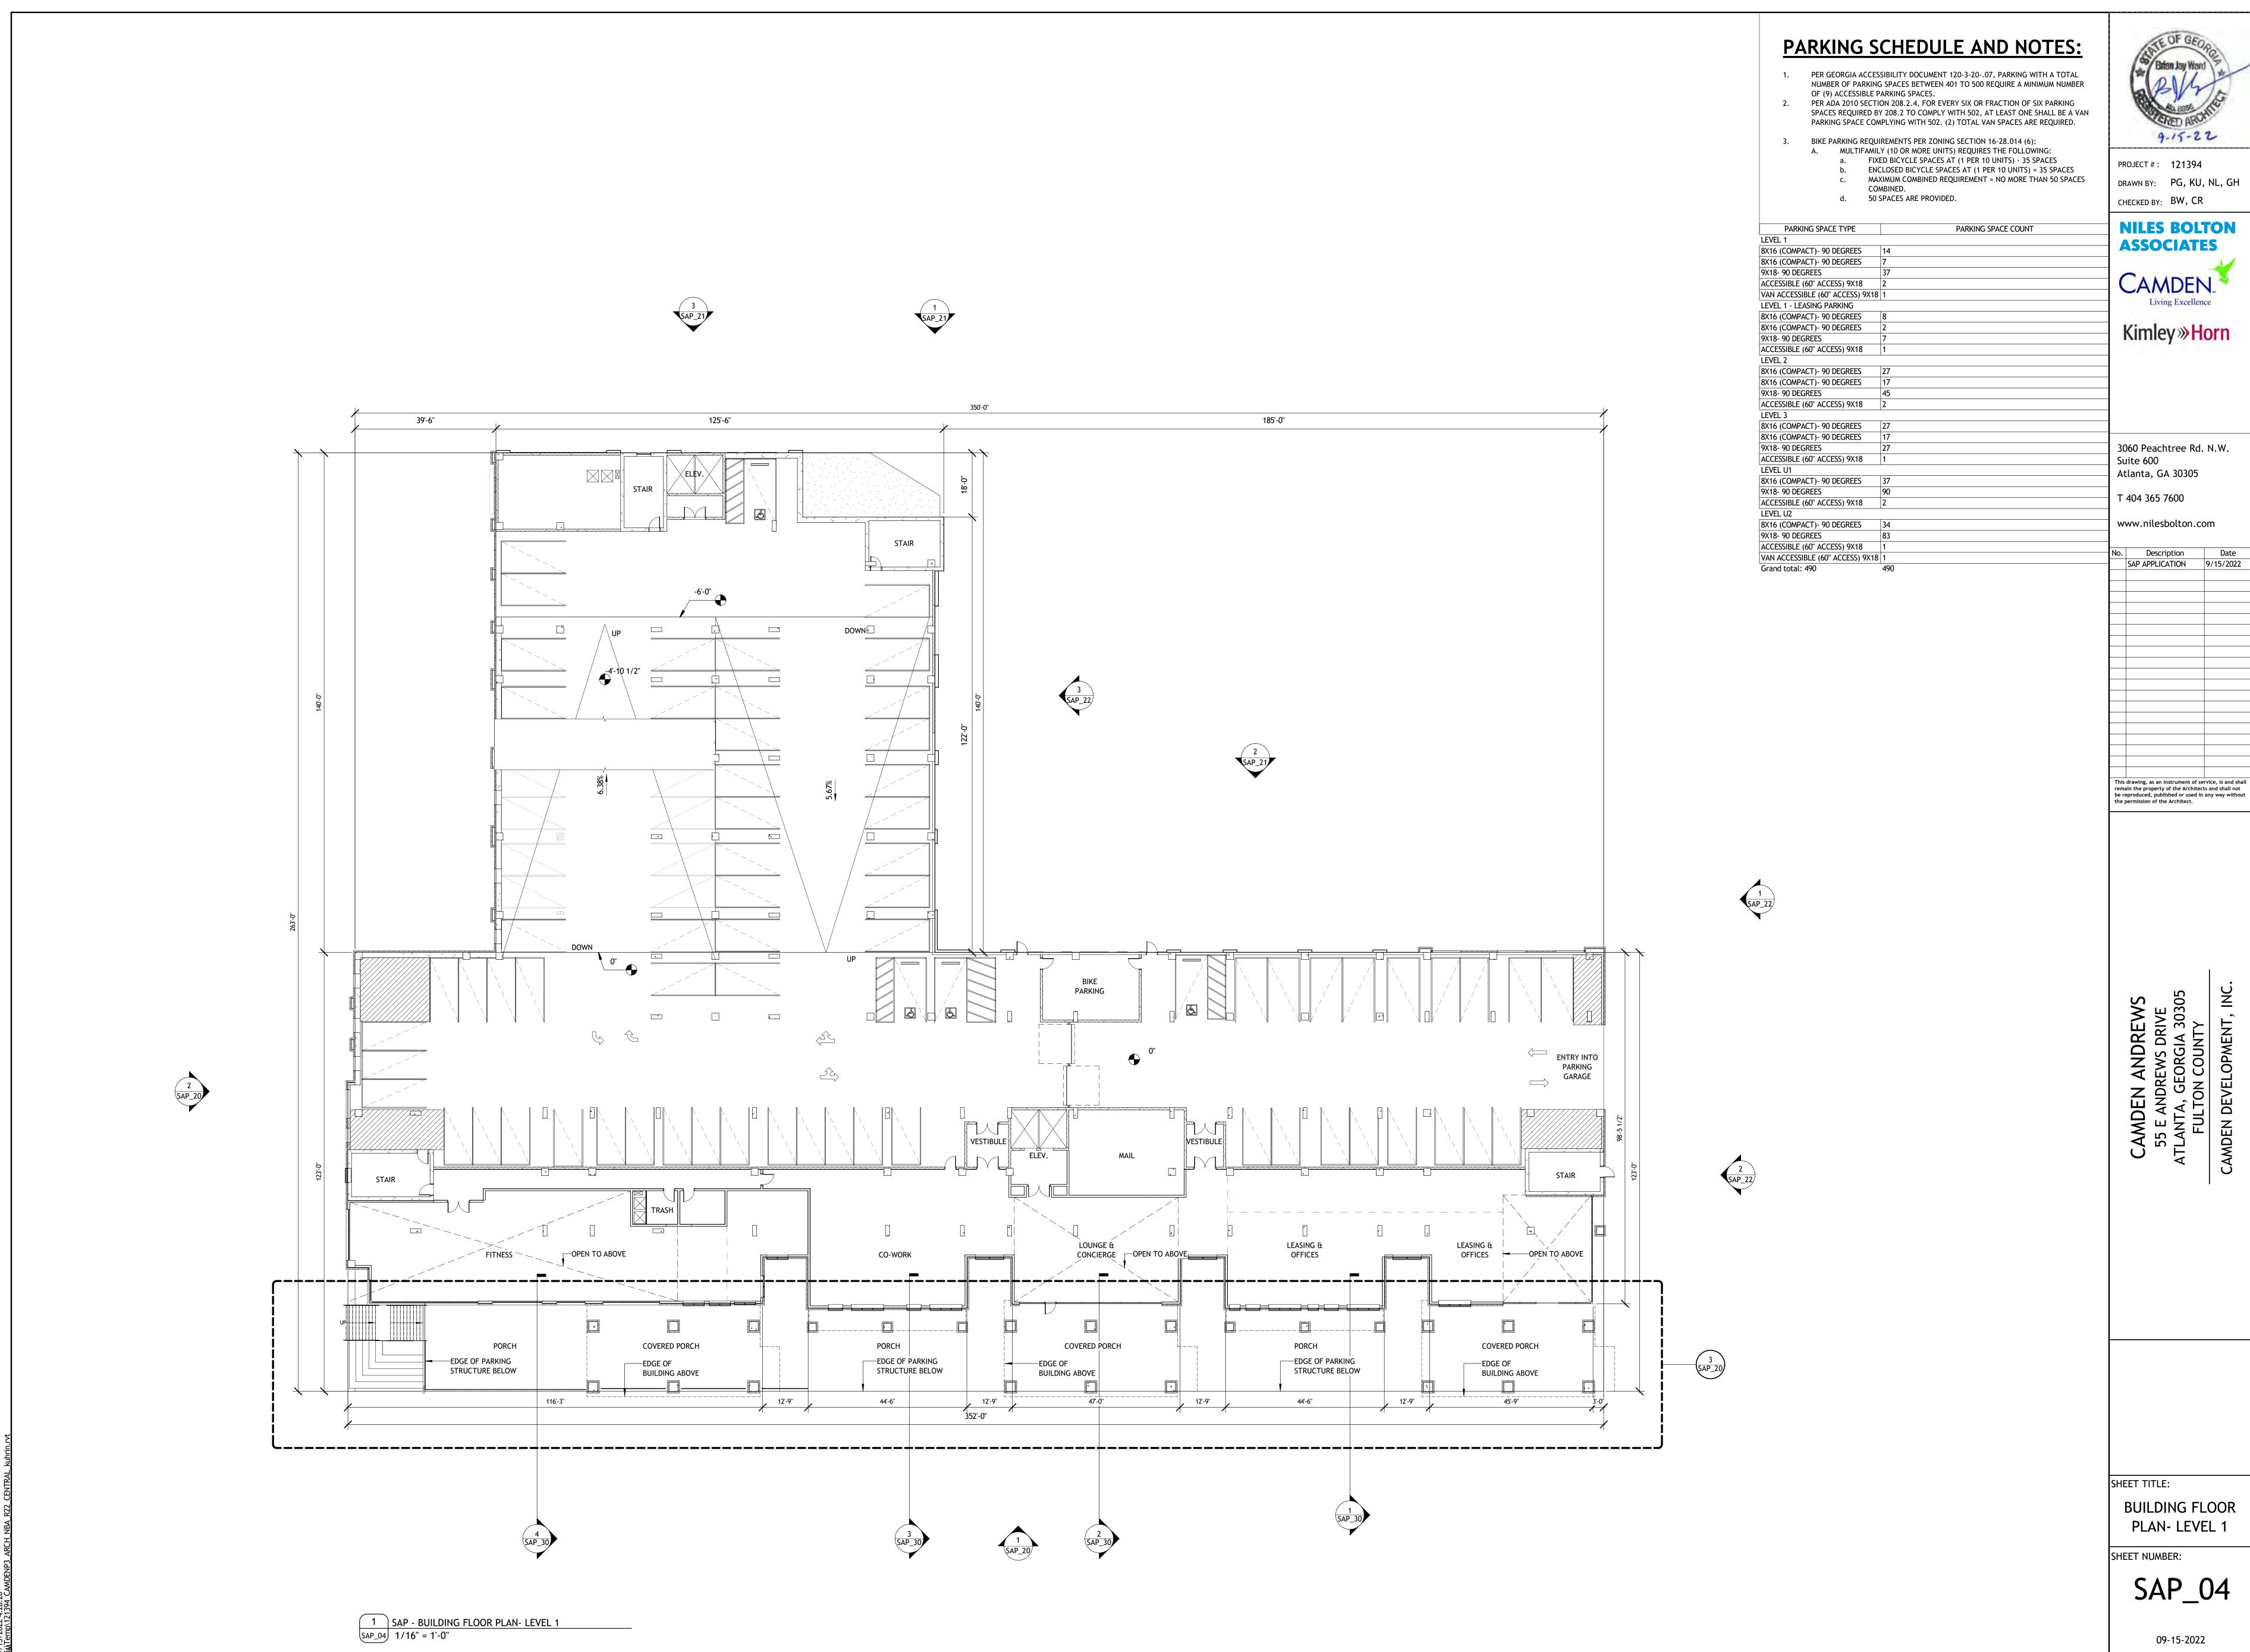

PARKING SCHEDULE AND NOTES:

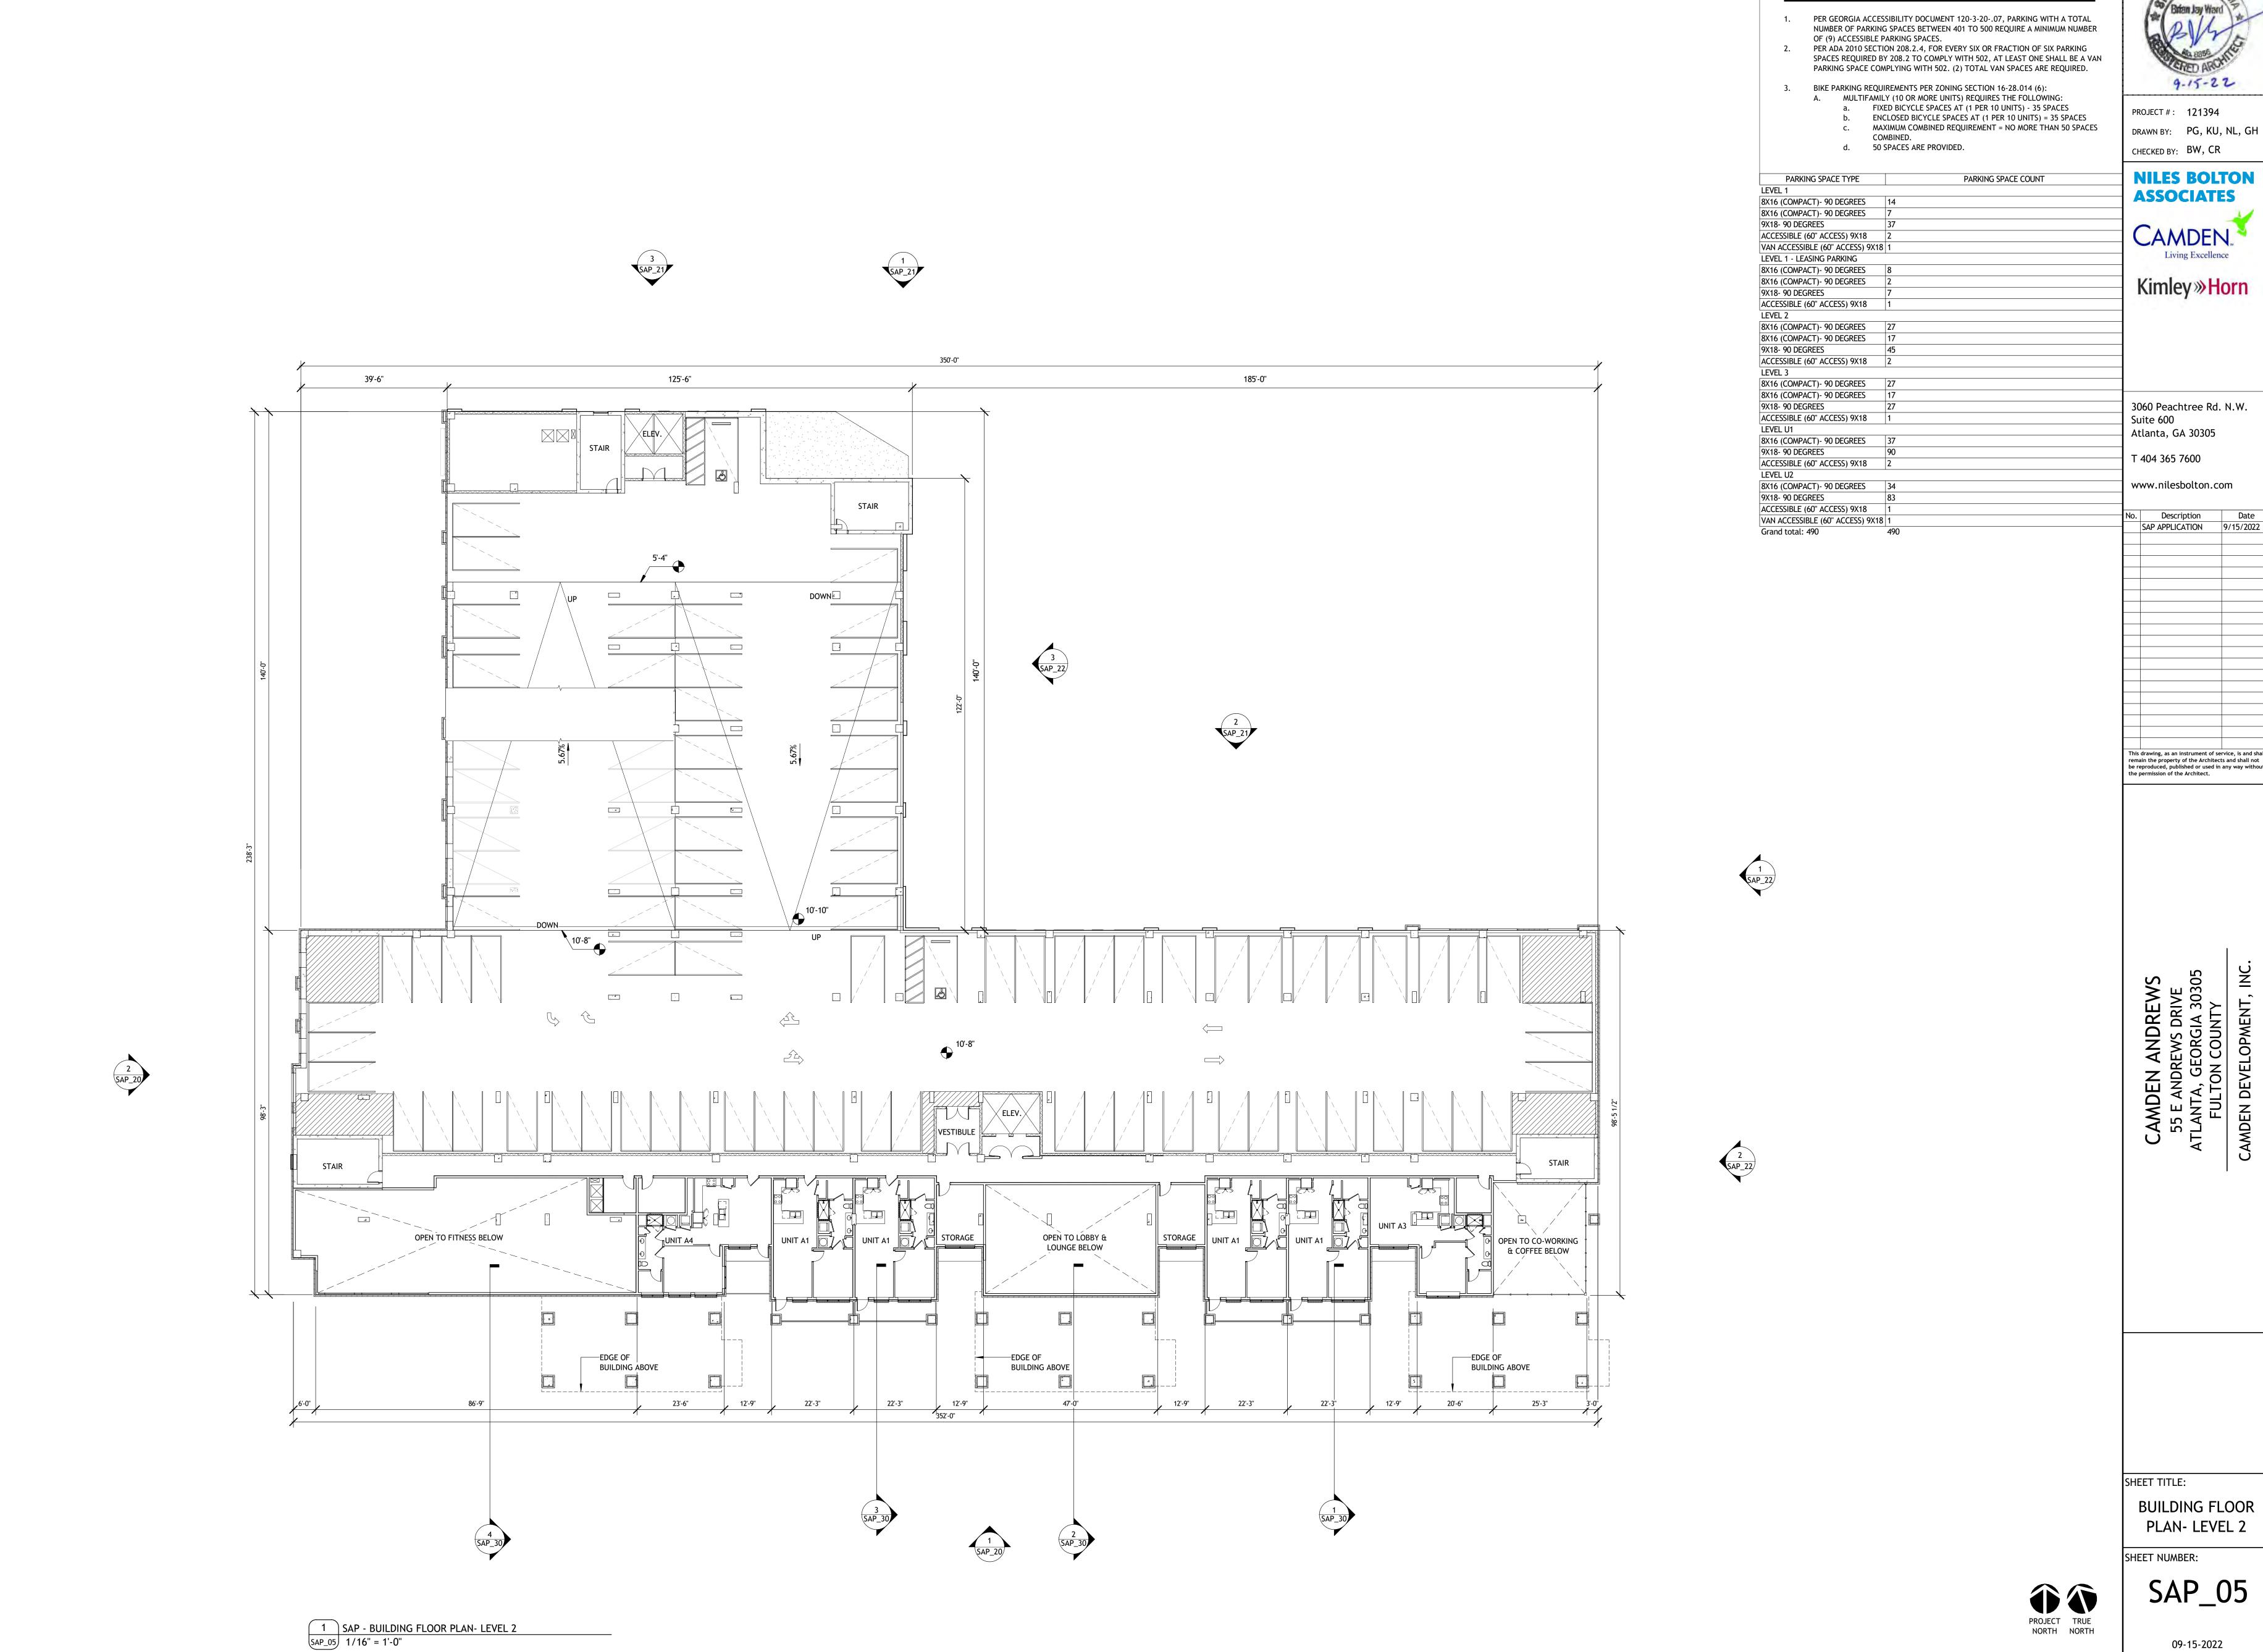PROJECT #: 121394 DRAWN BY: PG, KU, NL, GH CHECKED BY: BW, CR

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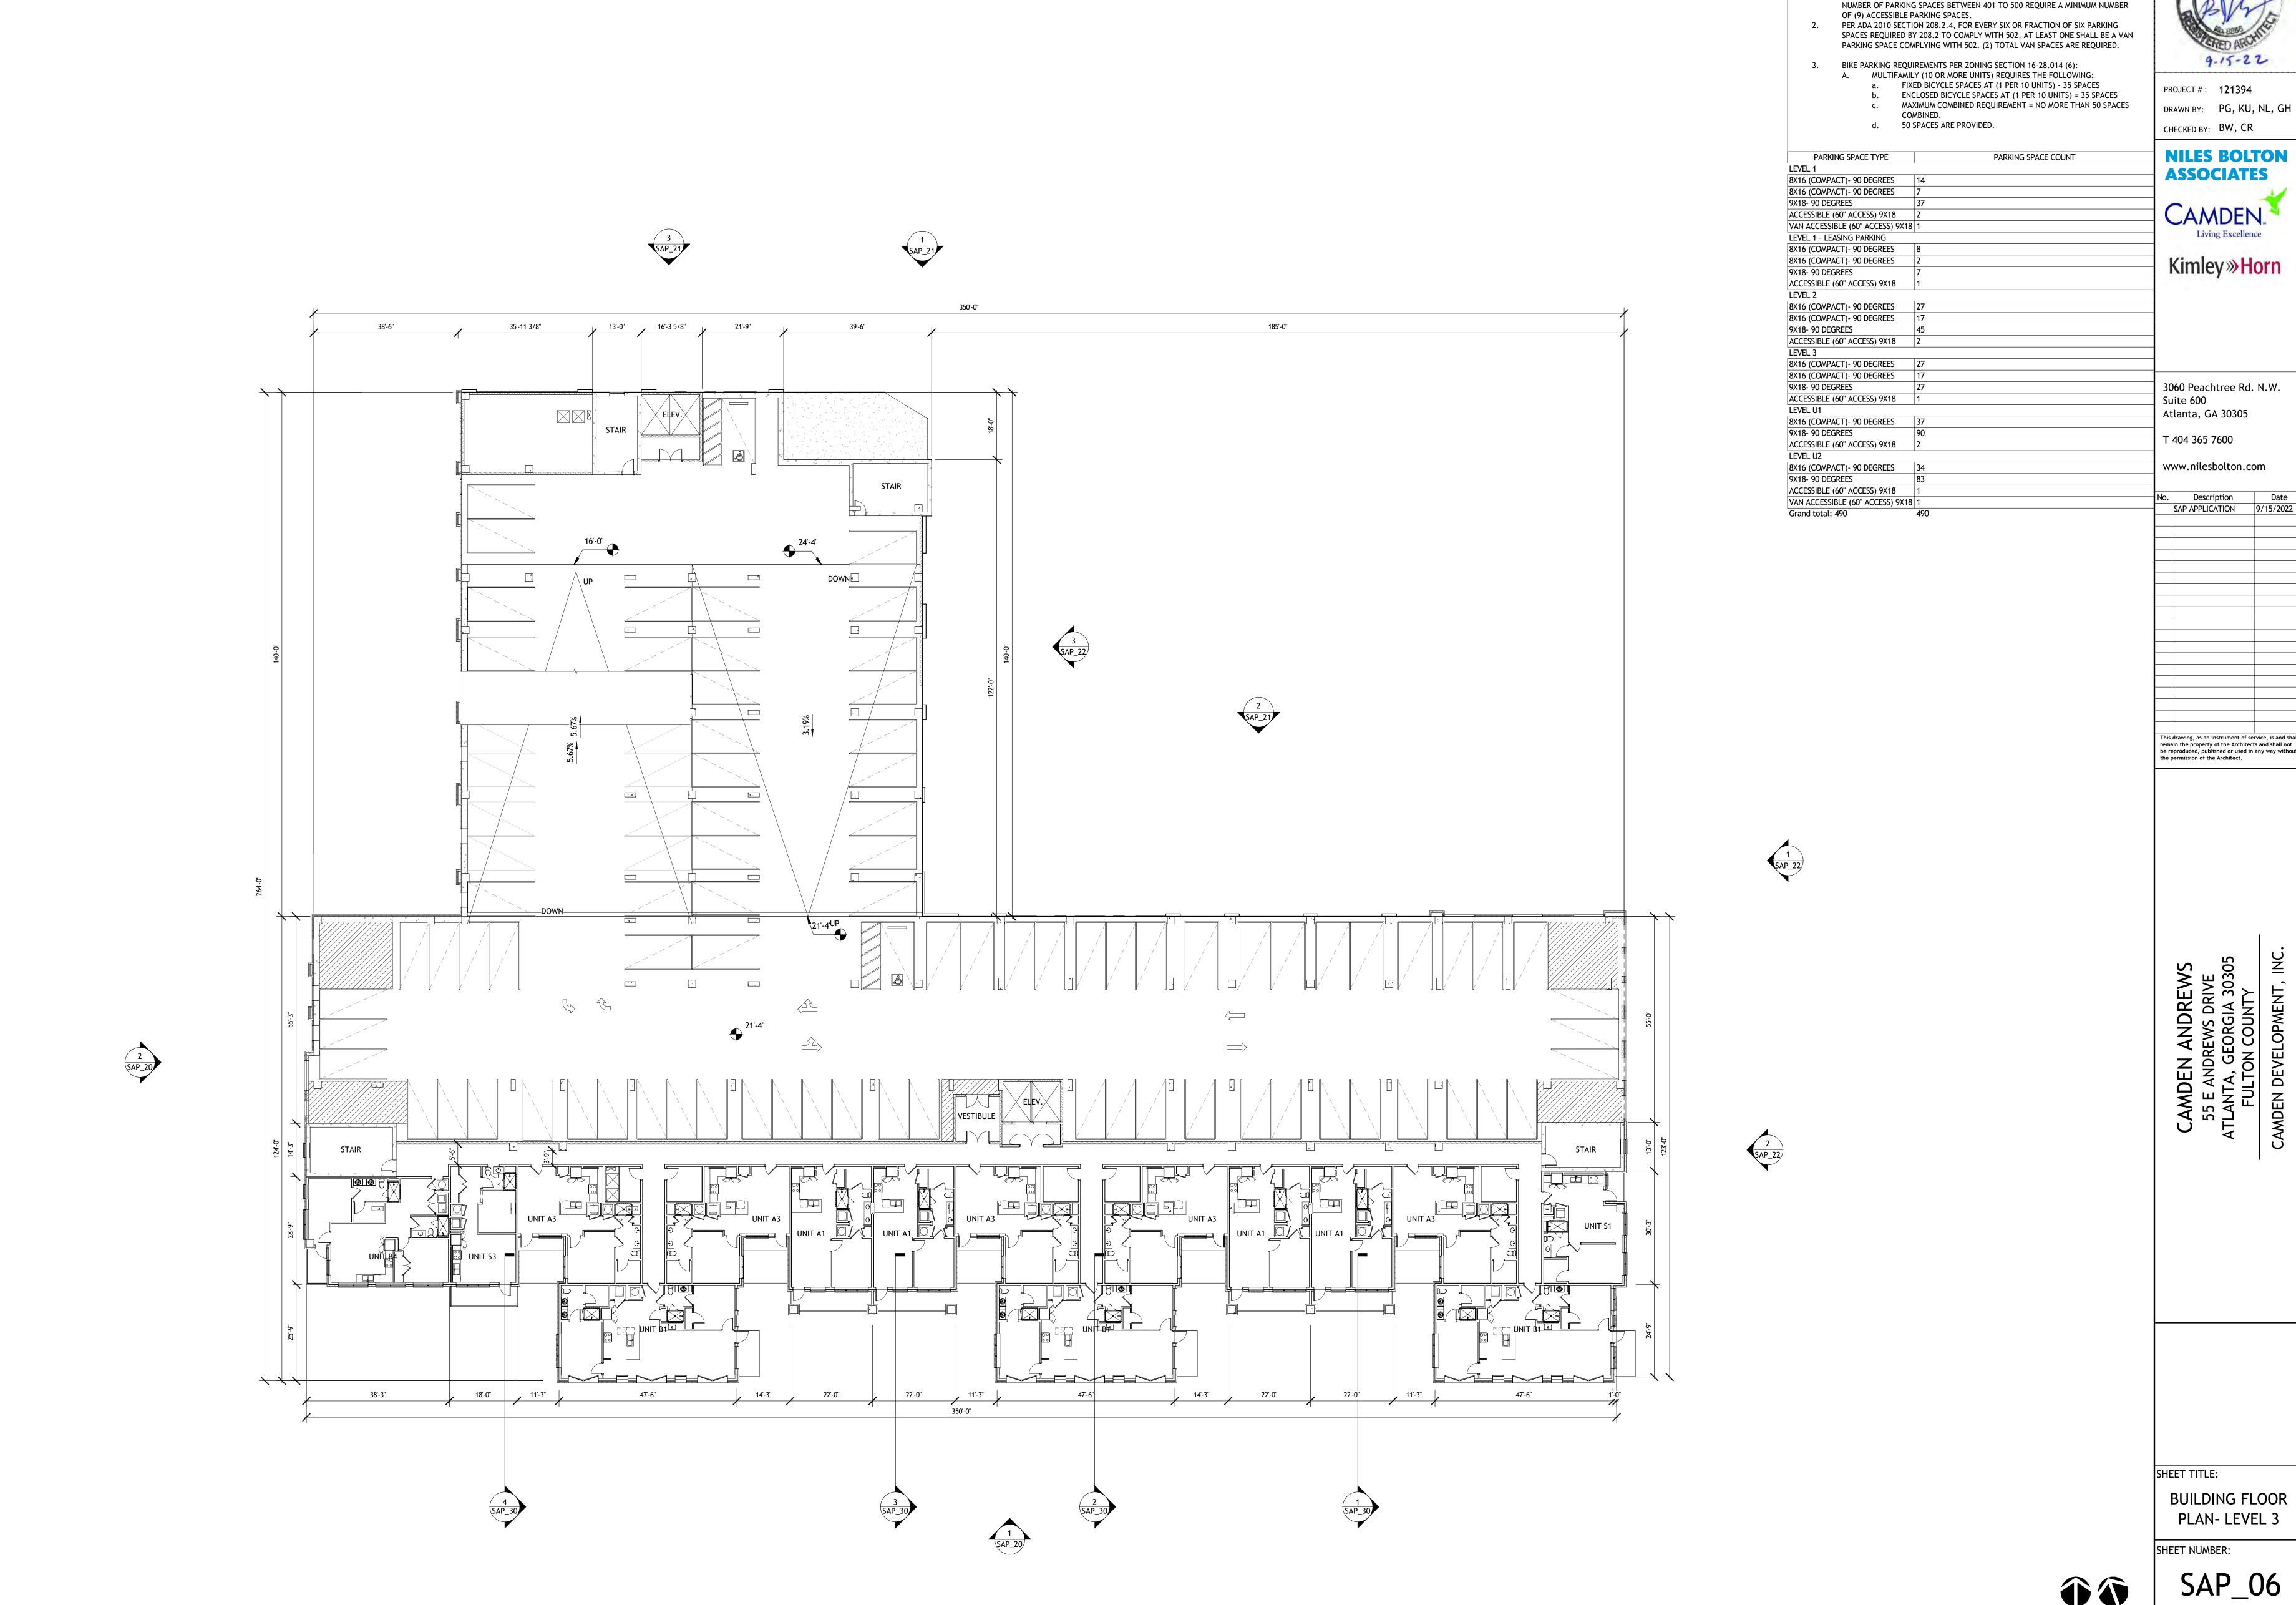
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SHEET TITLE:

BUILDING FLOOR PLAN- LEVEL 2

SHEET NUMBER:

SAP_05



1 SAP - BUILDING FLOOR PLAN- LEVEL 3 SAP_06 1/16" = 1'-0"



PARKING SCHEDULE AND NOTES:

1. PER GEORGIA ACCESSIBILITY DOCUMENT 120-3-20-.07, PARKING WITH A TOTAL

PROJECT #: 121394 DRAWN BY: PG, KU, NL, GH

NILES BOLTON ASSOCIATES

Kimley » Horn

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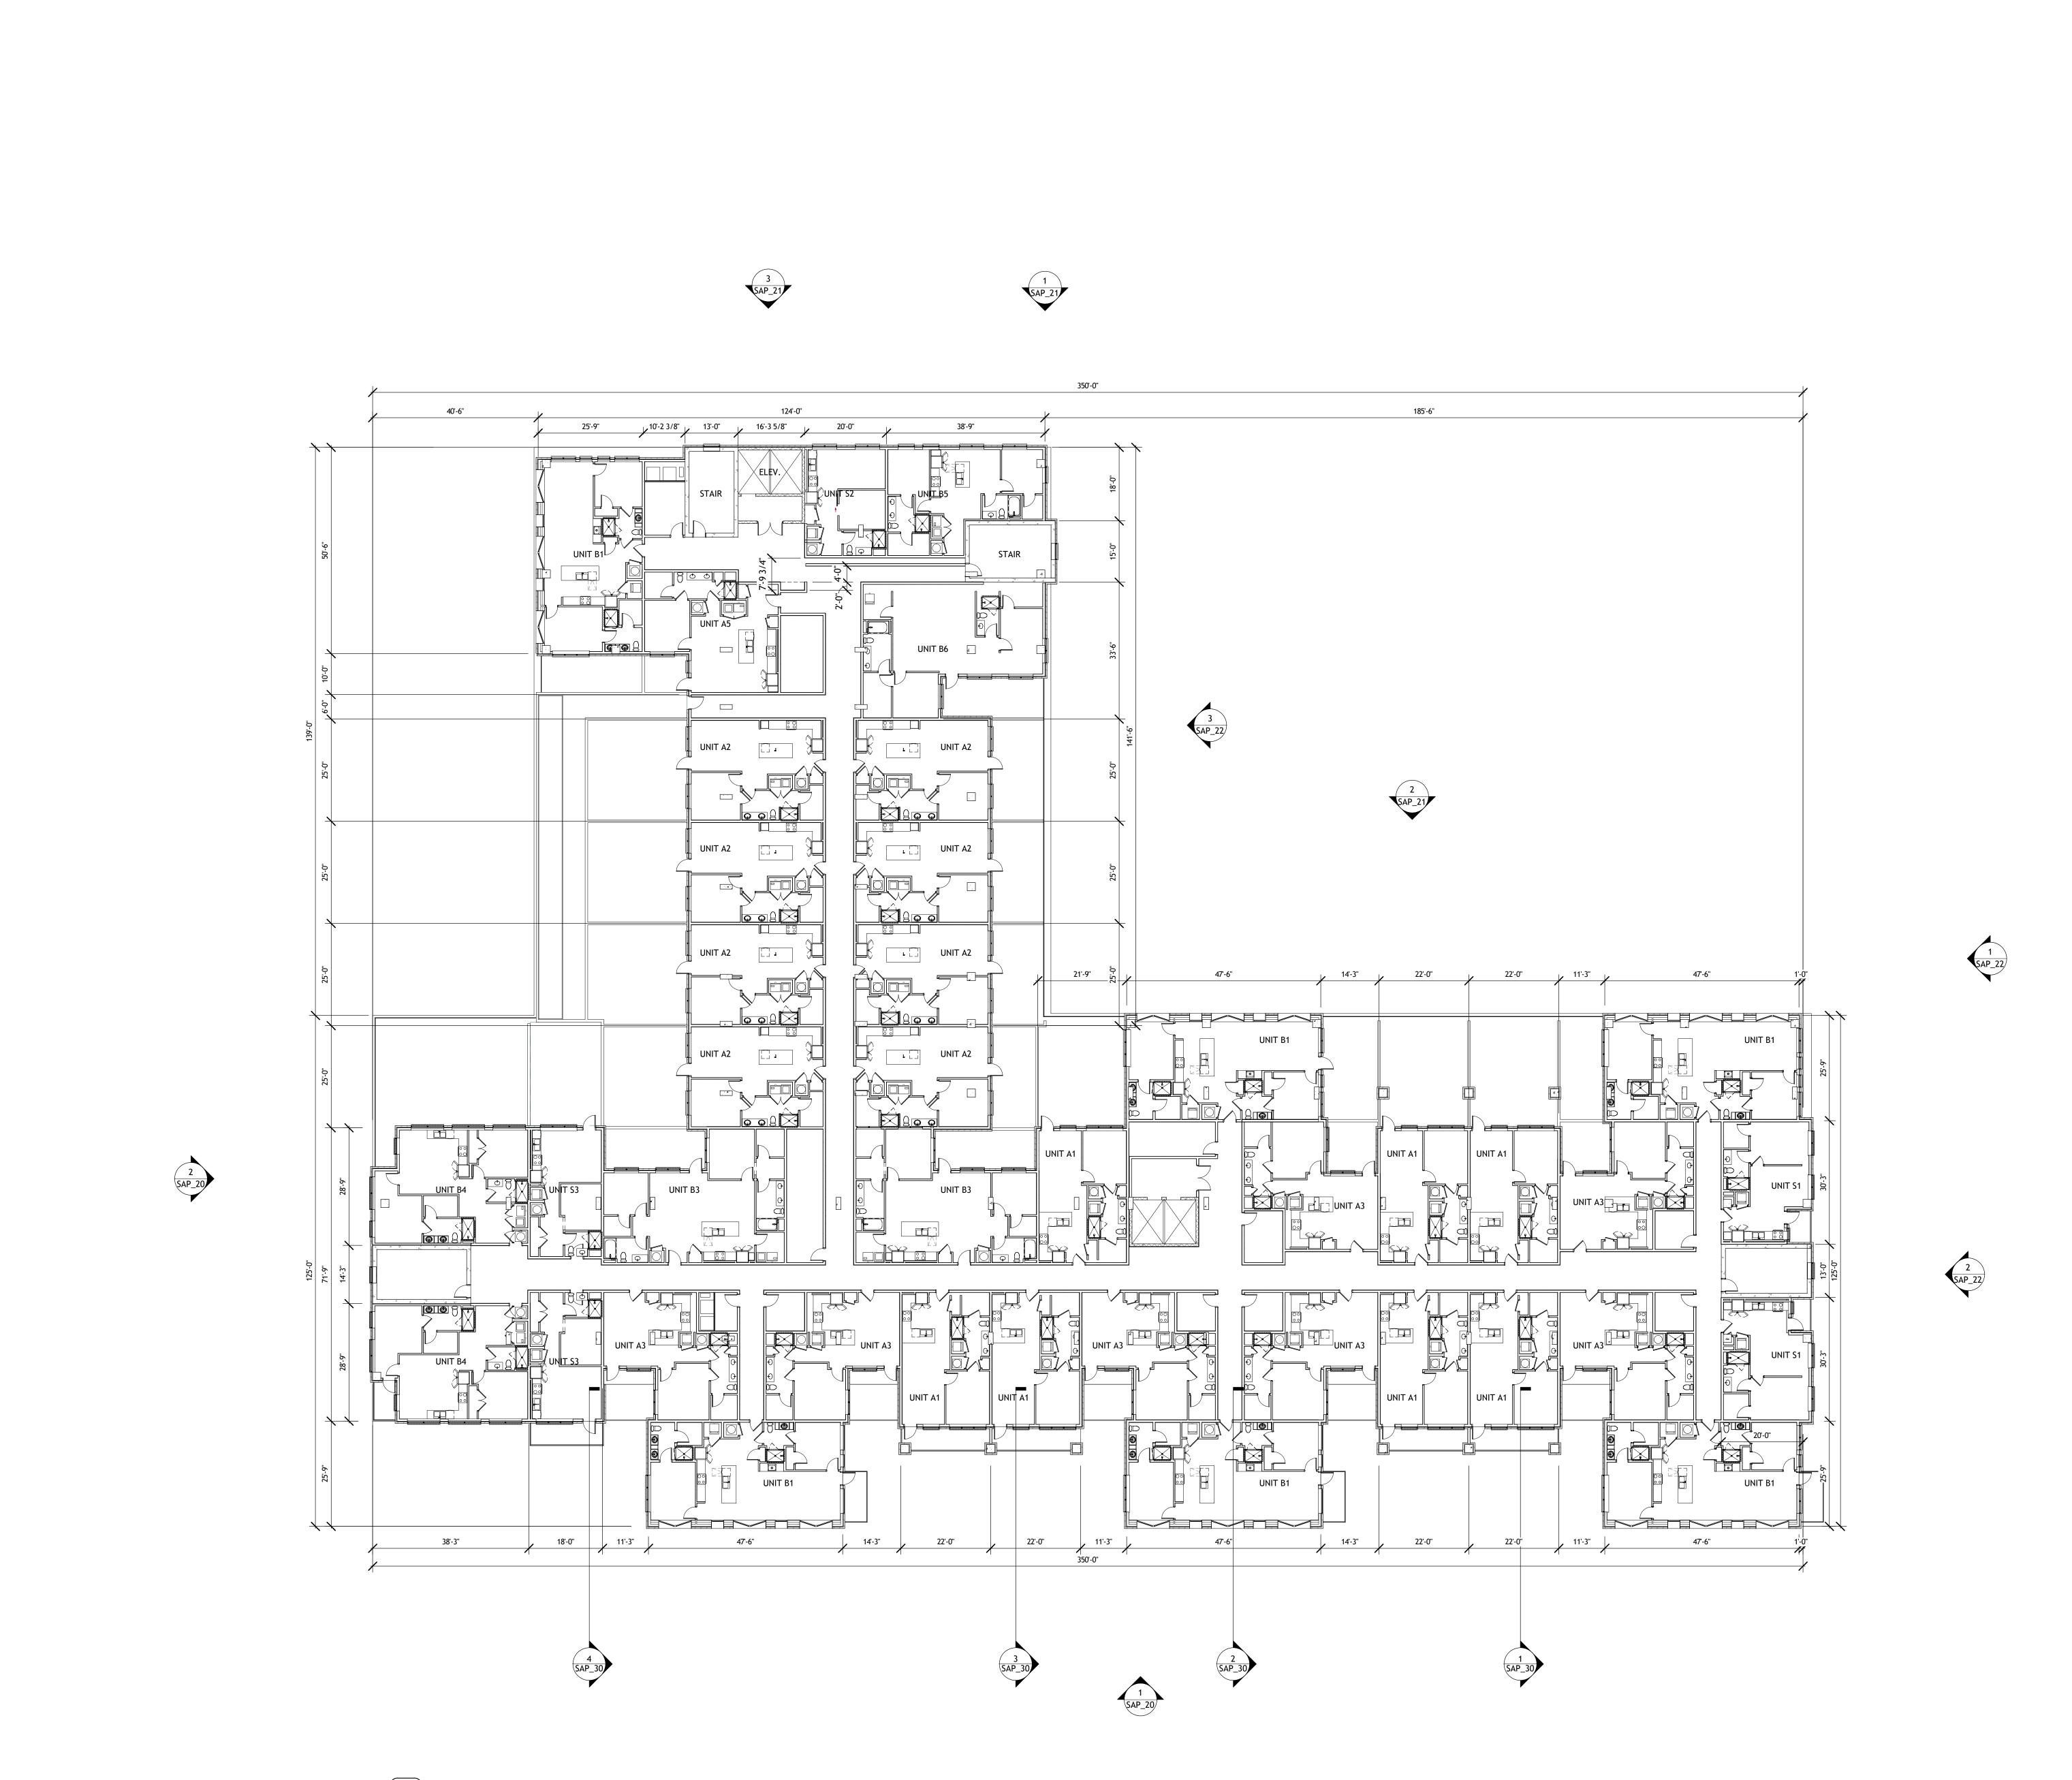
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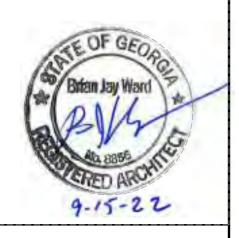
SHEET TITLE:

PLAN- LEVEL 3

SHEET NUMBER:

SAP_06





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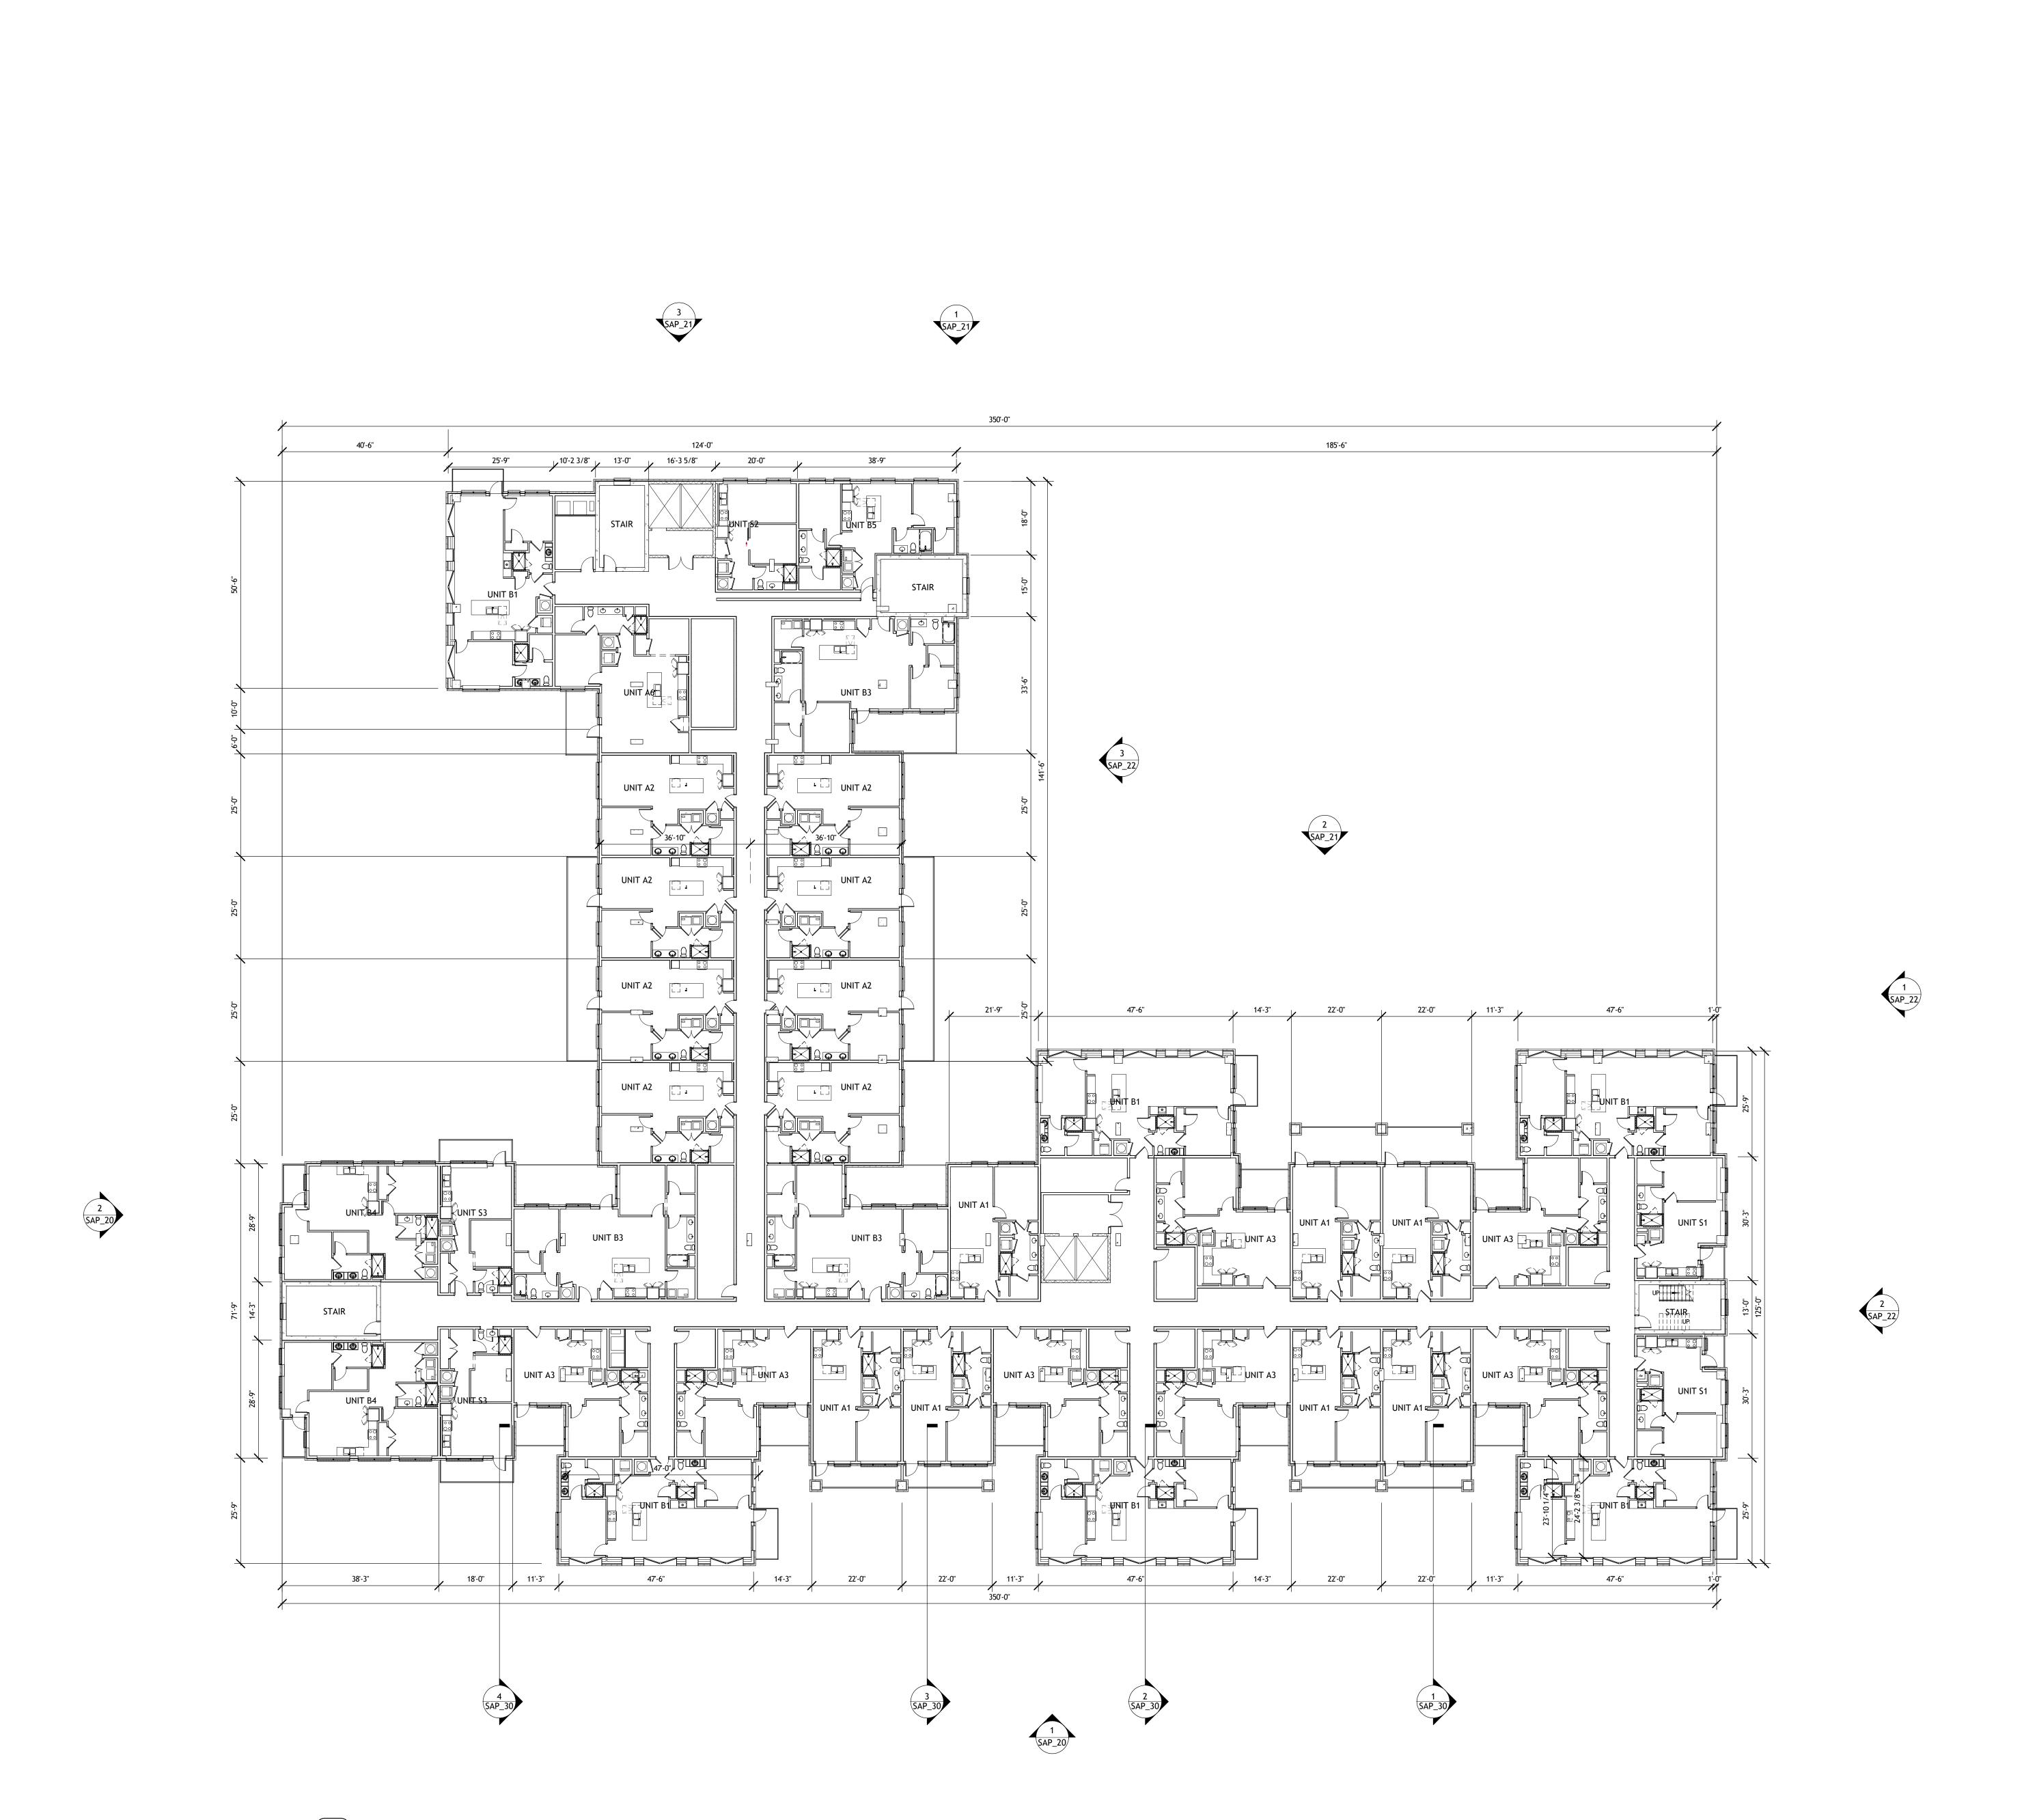
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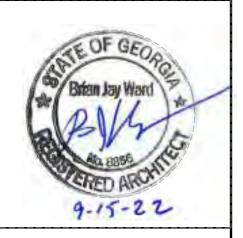
SHEET TITLE:

BUILDING FLOOR PLAN- LEVEL 4

SHEET NUMBER:

SAP_07





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FULTON COUNTY

SHEET TITLE:
BUILDING FLOOR
PLAN- LEVEL 5-10
TYPICAL


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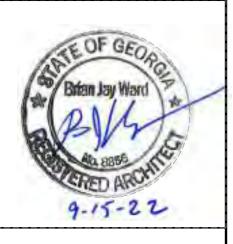
SAP_08

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09-15-2022

PROJECT TRUE



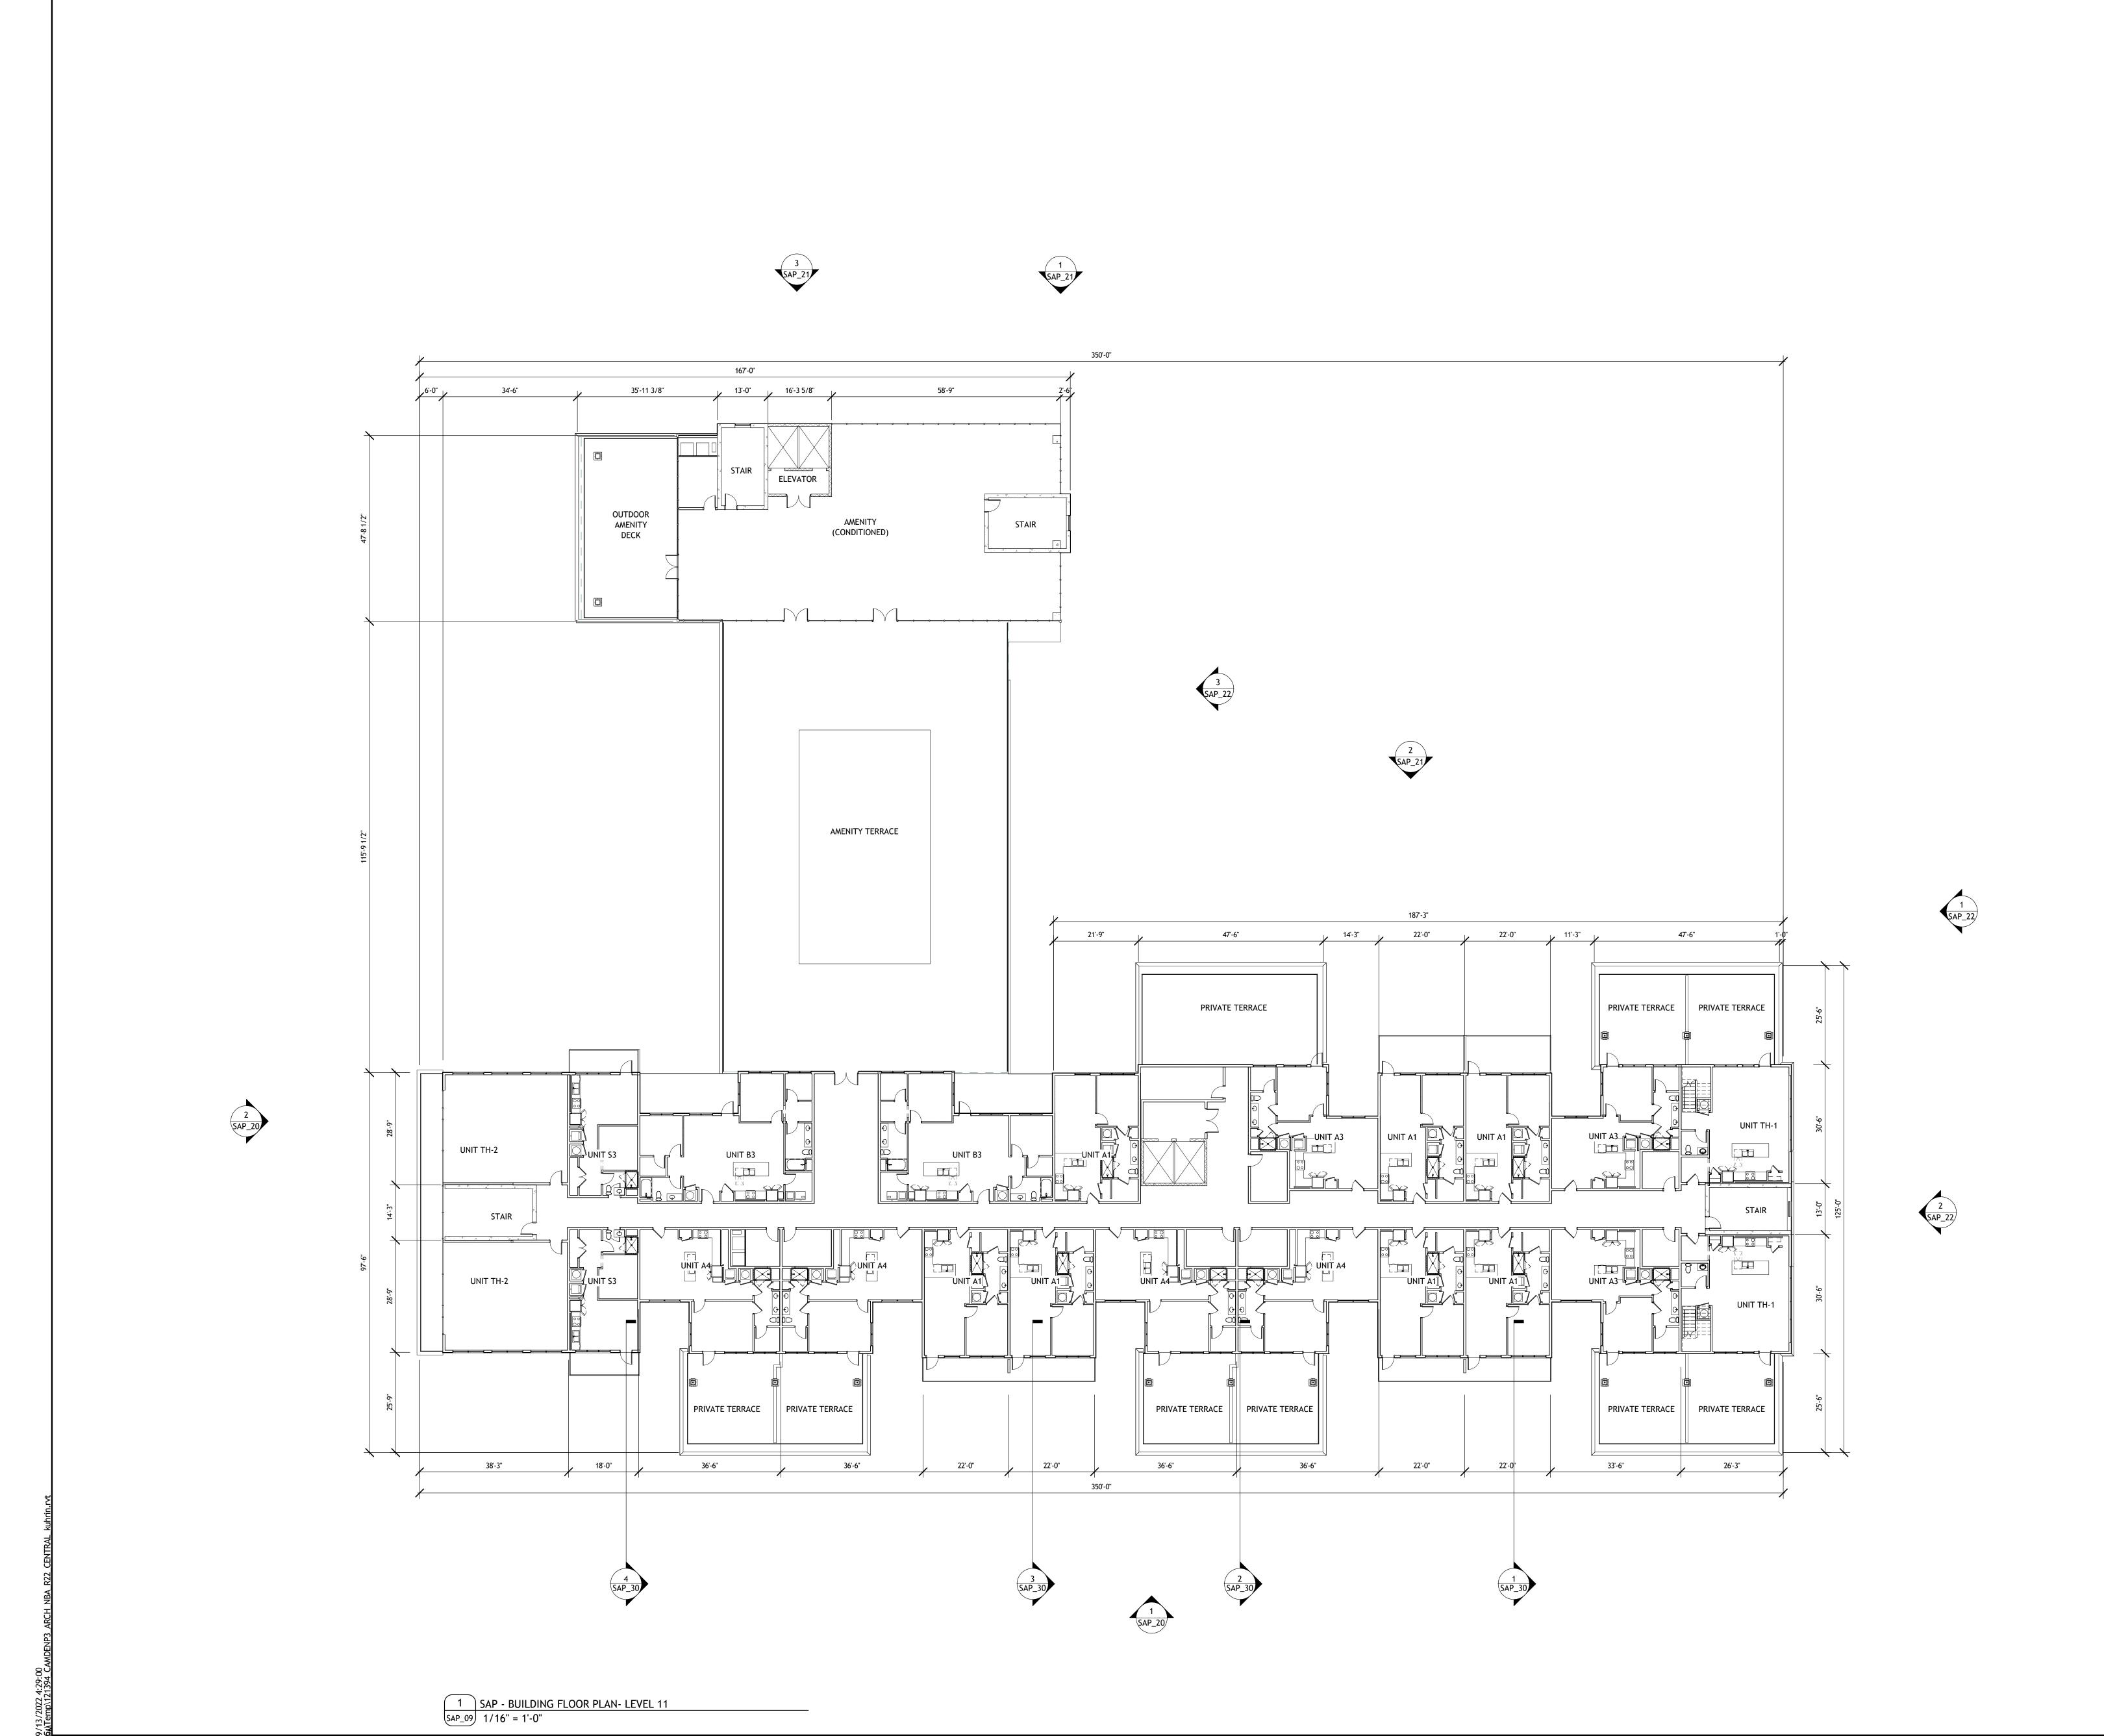

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	SAP APPLICATION	9/15/2022


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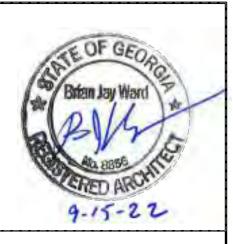
SHEET TITLE:

BUILDING FLOOR PLAN- LEVEL 11

SHEET NUMBER:

SAP_09



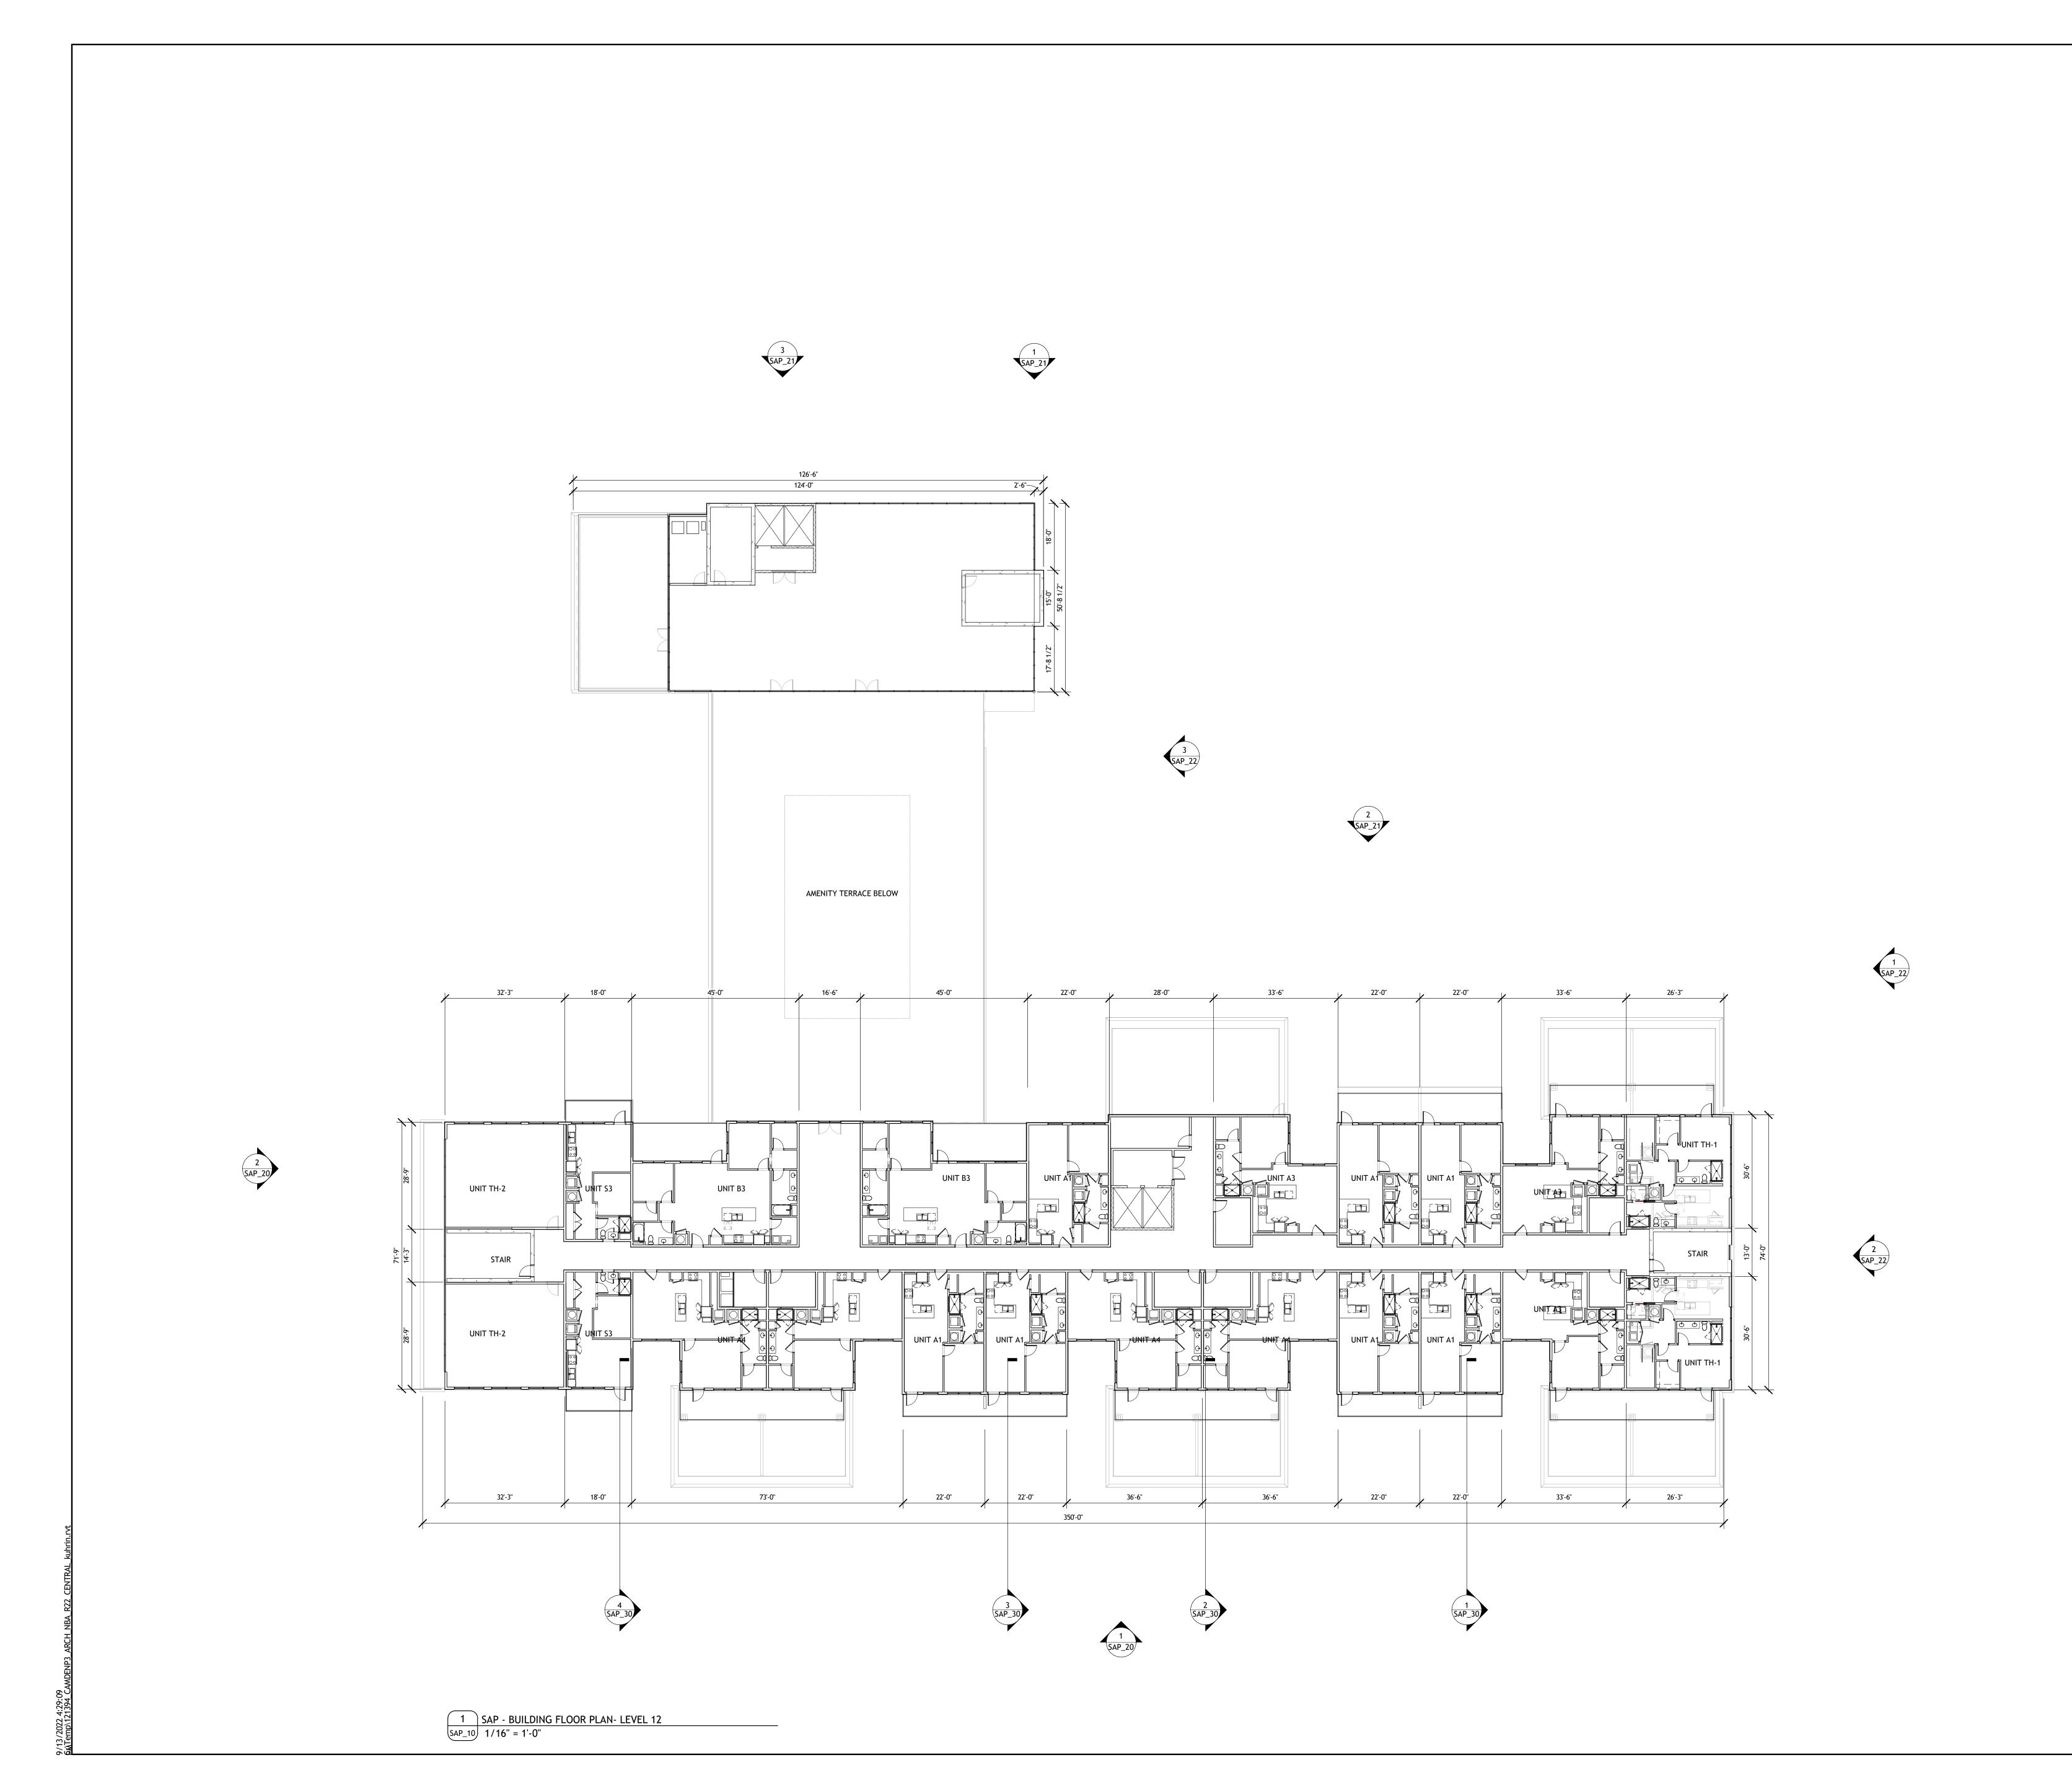

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o.	Description	Date
	SAP APPLICATION	9/15/2022
his	drawing, as an instrument of se	rvice, is and shall

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FULTON COUNTY

SHEET TITLE:

BUILDING FLOOR PLAN- LEVEL 12

SHEET NUMBER:

SAP_10

09-15-2022

PROJECT TRUE NORTH NORTH



— E ANDREWS DRIVE—

3 SAP - BUILDING FLOOR PLAN- ON E ANDREWS DR SAP_20 1/16" = 1'-0"

PROJECT #: 121394 DRAWN BY: PG, KU, NL, GH CHECKED BY: BW, CR

NILES BOLTON ASSOCIATES Living Excellence

PROJECT NORTH

T 404 365 7600

Atlanta, GA 30305

Suite 600

3060 Peachtree Rd. N.W.

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	SAP APPLICATION	9/15/2022	
			l

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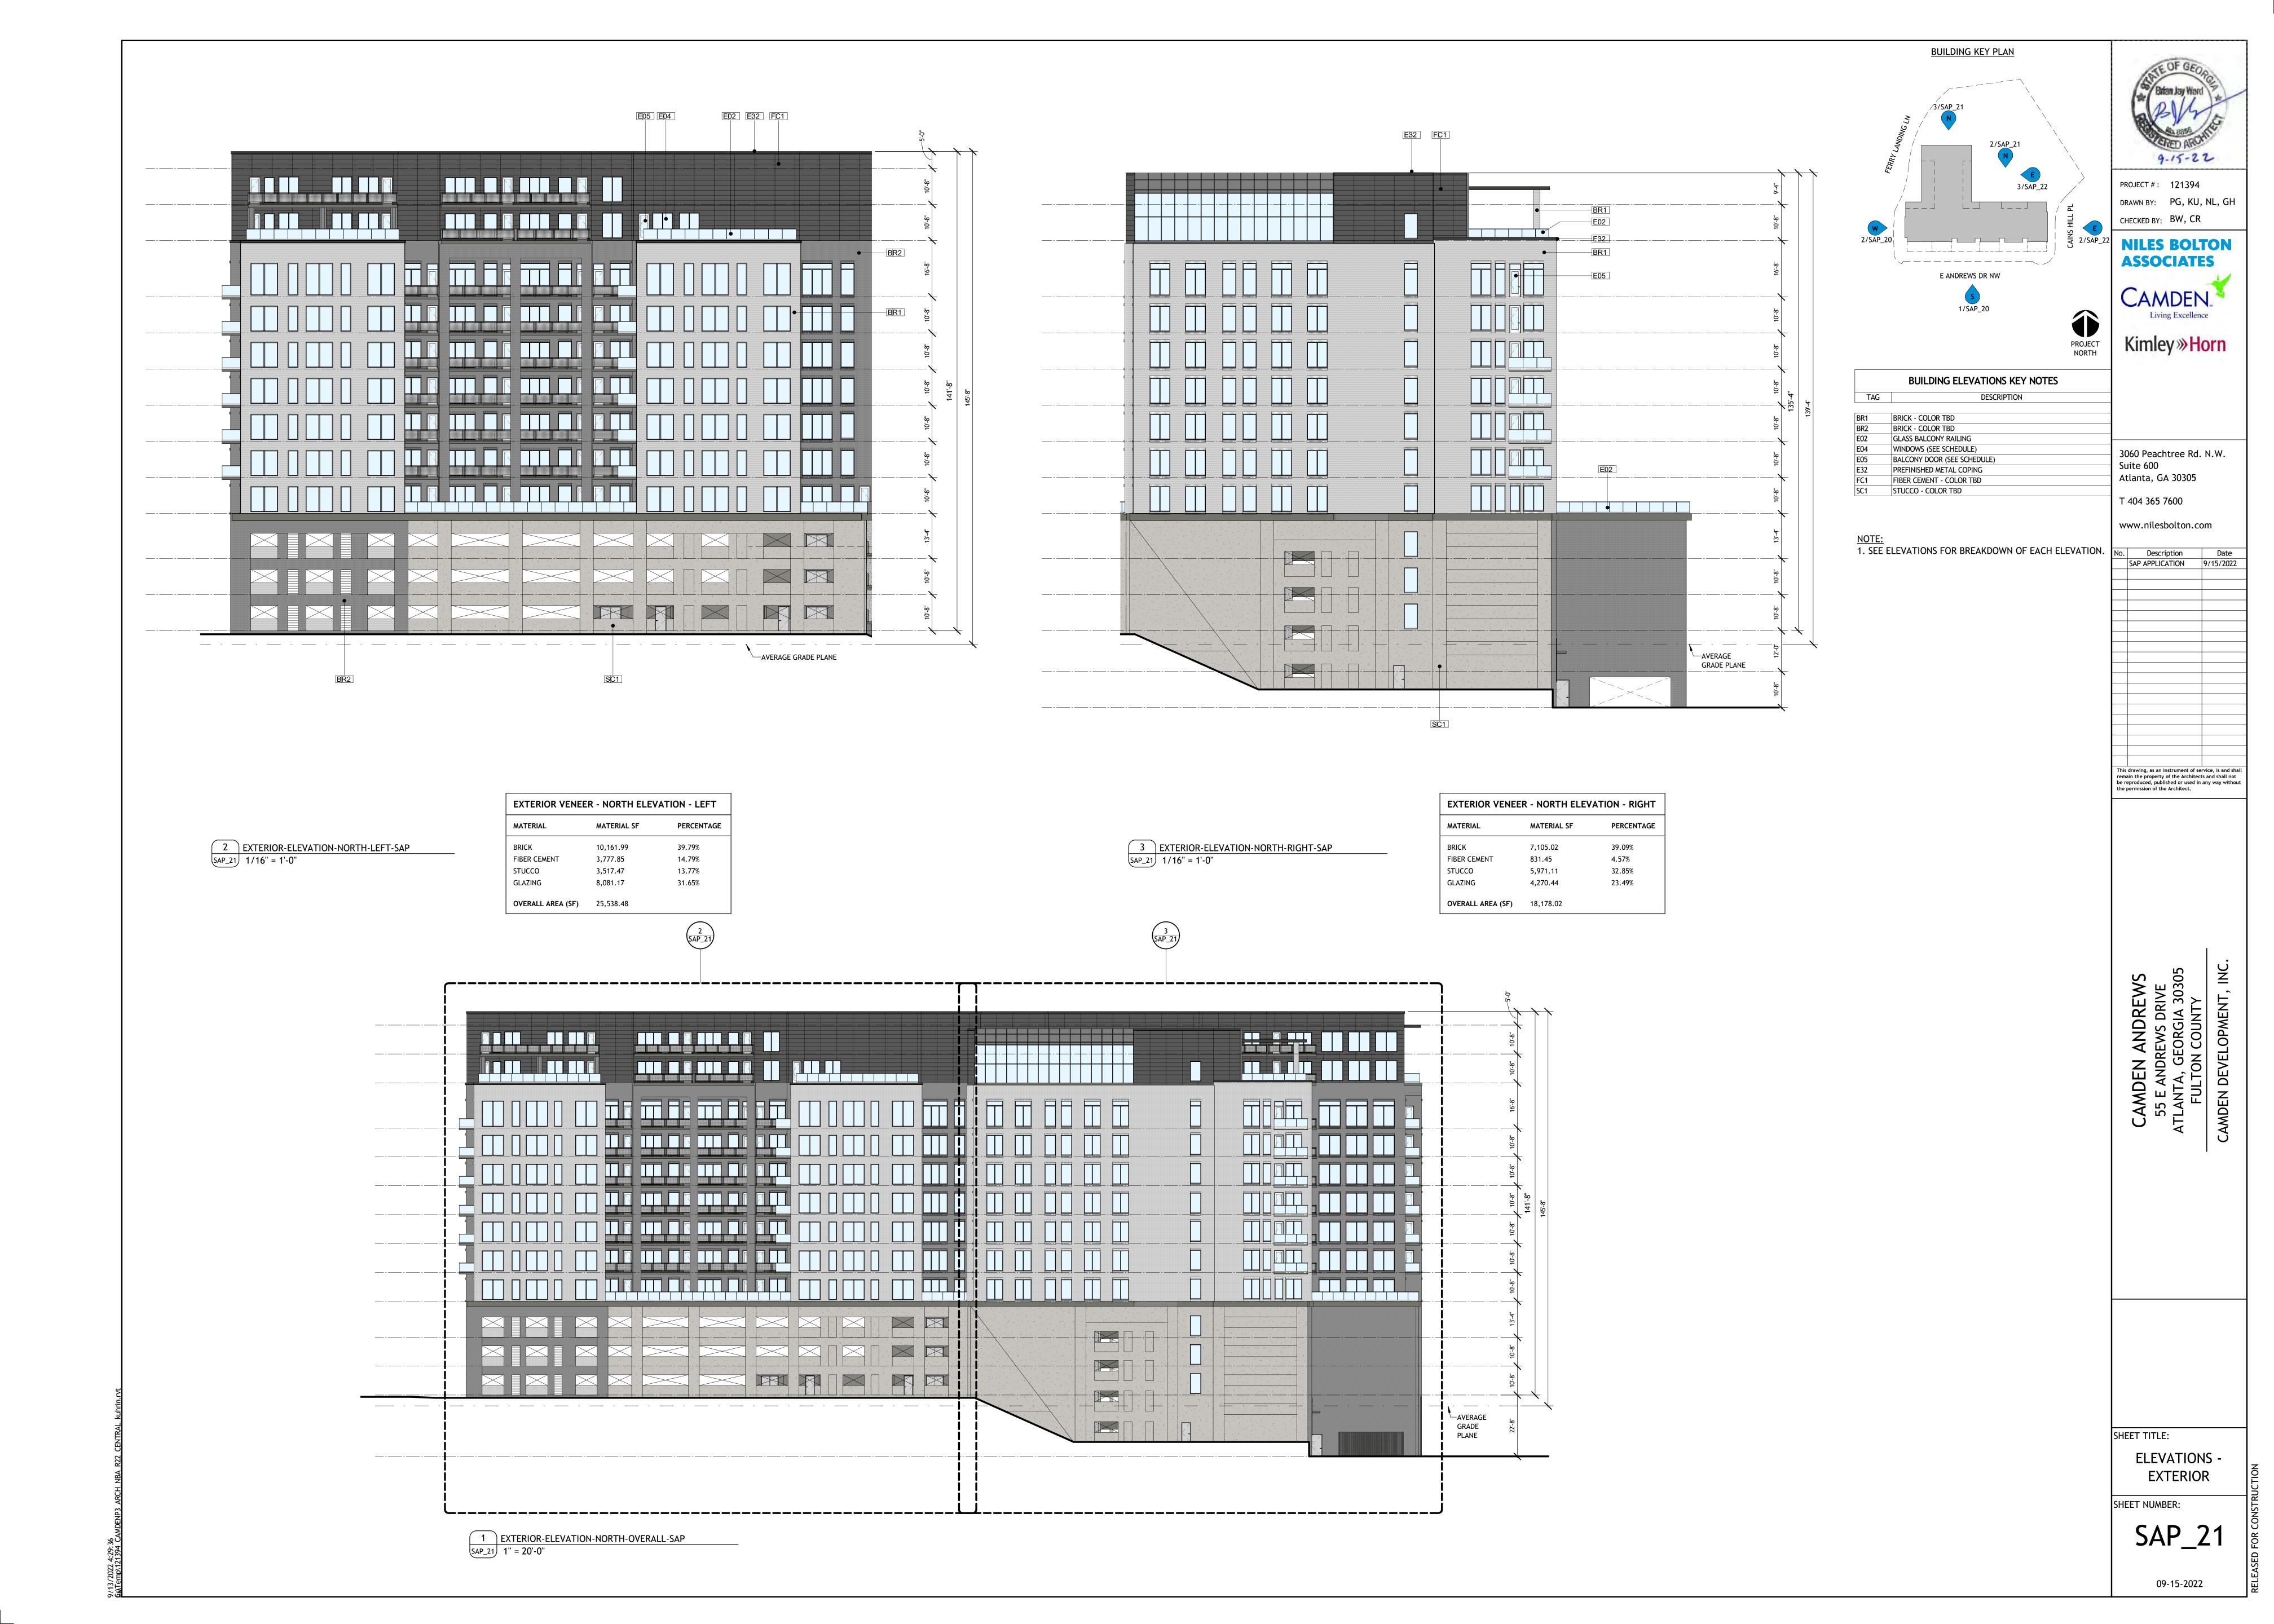
CAMDEN ANDREWS 55 E ANDREWS DRIVE ATLANTA, GEORGIA 30305 FULTON COUNTY

SHEET TITLE:

ELEVATIONS EXTERIOR


SHEET NUMBER:

SAP_20







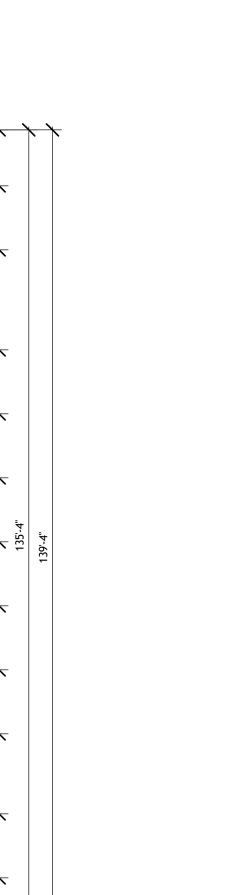

PROJECT #: 121394 DRAWN BY: PG, KU, NL, GH CHECKED BY: BW, CR **NILES BOLTON ASSOCIATES** E ANDREWS DR NW CAMDEN ...
Living Excellence PROJECT NORTH Kimley » Horn

	BUILDING ELEVATIONS KEY NOTES	
TAG	DESCRIPTION	
BR1	BRICK - COLOR TBD	-
BR2	BRICK - COLOR TBD	1
E02	GLASS BALCONY RAILING	
E04	WINDOWS (SEE SCHEDULE)	3060 Peachtree Rd. N.W.
E05	BALCONY DOOR (SEE SCHEDULE)	
E32	PREFINISHED METAL COPING	Suite 600
FC1	FIBER CEMENT - COLOR TBD	Atlanta, GA 30305
SC1	STUCCO - COLOR TBD	1
		T 404 365 7600
		www.nileshelton.com

BUILDING KEY PLAN

www.nilesbolton.com NOTE:

1. SEE ELEVATIONS FOR BREAKDOWN OF EACH ELEVATION.

No. Description Date

| SAP APPLICATION | 9/15/2022 |

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	rema	drawing, as an instrument of sin the property of the Archite produced, published or used sermission of the Architect.	cts and shall not
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CAMDEN DEVELOPMENT, INC.

SHEET TITLE: **ELEVATIONS EXTERIOR**

SHEET NUMBER:


09-15-2022


1 EXTERIOR-ELEVATION-EAST-SAP

EXTERIOR VENEER - EAST ELEVATION - LEFT MATERIAL PERCENTAGE 2 EXTERIOR-ELEVATION-EAST-LEFT-SAP SAP_22 1/16" = 1'-0" 52.78% FIBER CEMENT GLAZING **OVERALL AREA (SF)** 15,235.49

3 EXTERIOR-ELEVATION-EAST-RIGHT-SAP SAP_22 1/16" = 1'-0"

EXTERIOR VENEER - EAST ELEVATION - RIGHT							
MATERIAL	MATERIAL SF	PERCENTAGE					
BRICK	7,318.68	45.18%					
FIBER CEMENT	286.41	1.77%					
STUCCO	4,273.06	26.38%					
GLAZING	4,320.83	26.67%					
OVERALL AREA (SF)	16,198.98						

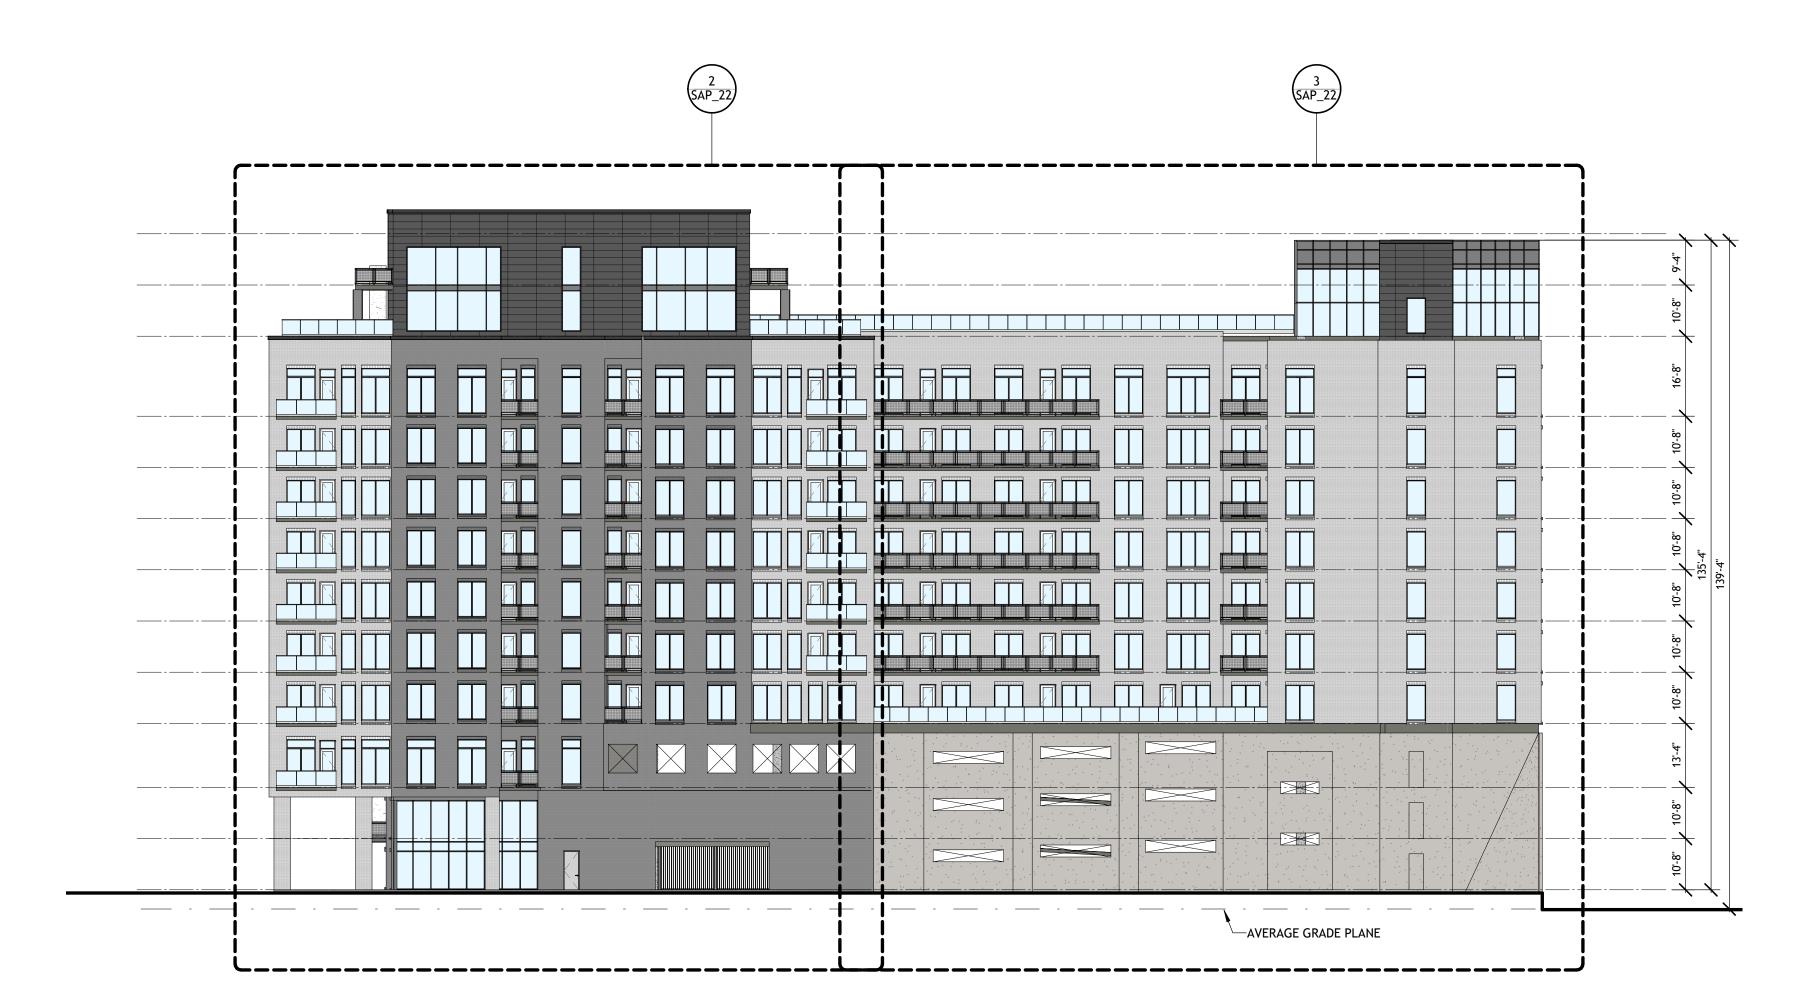

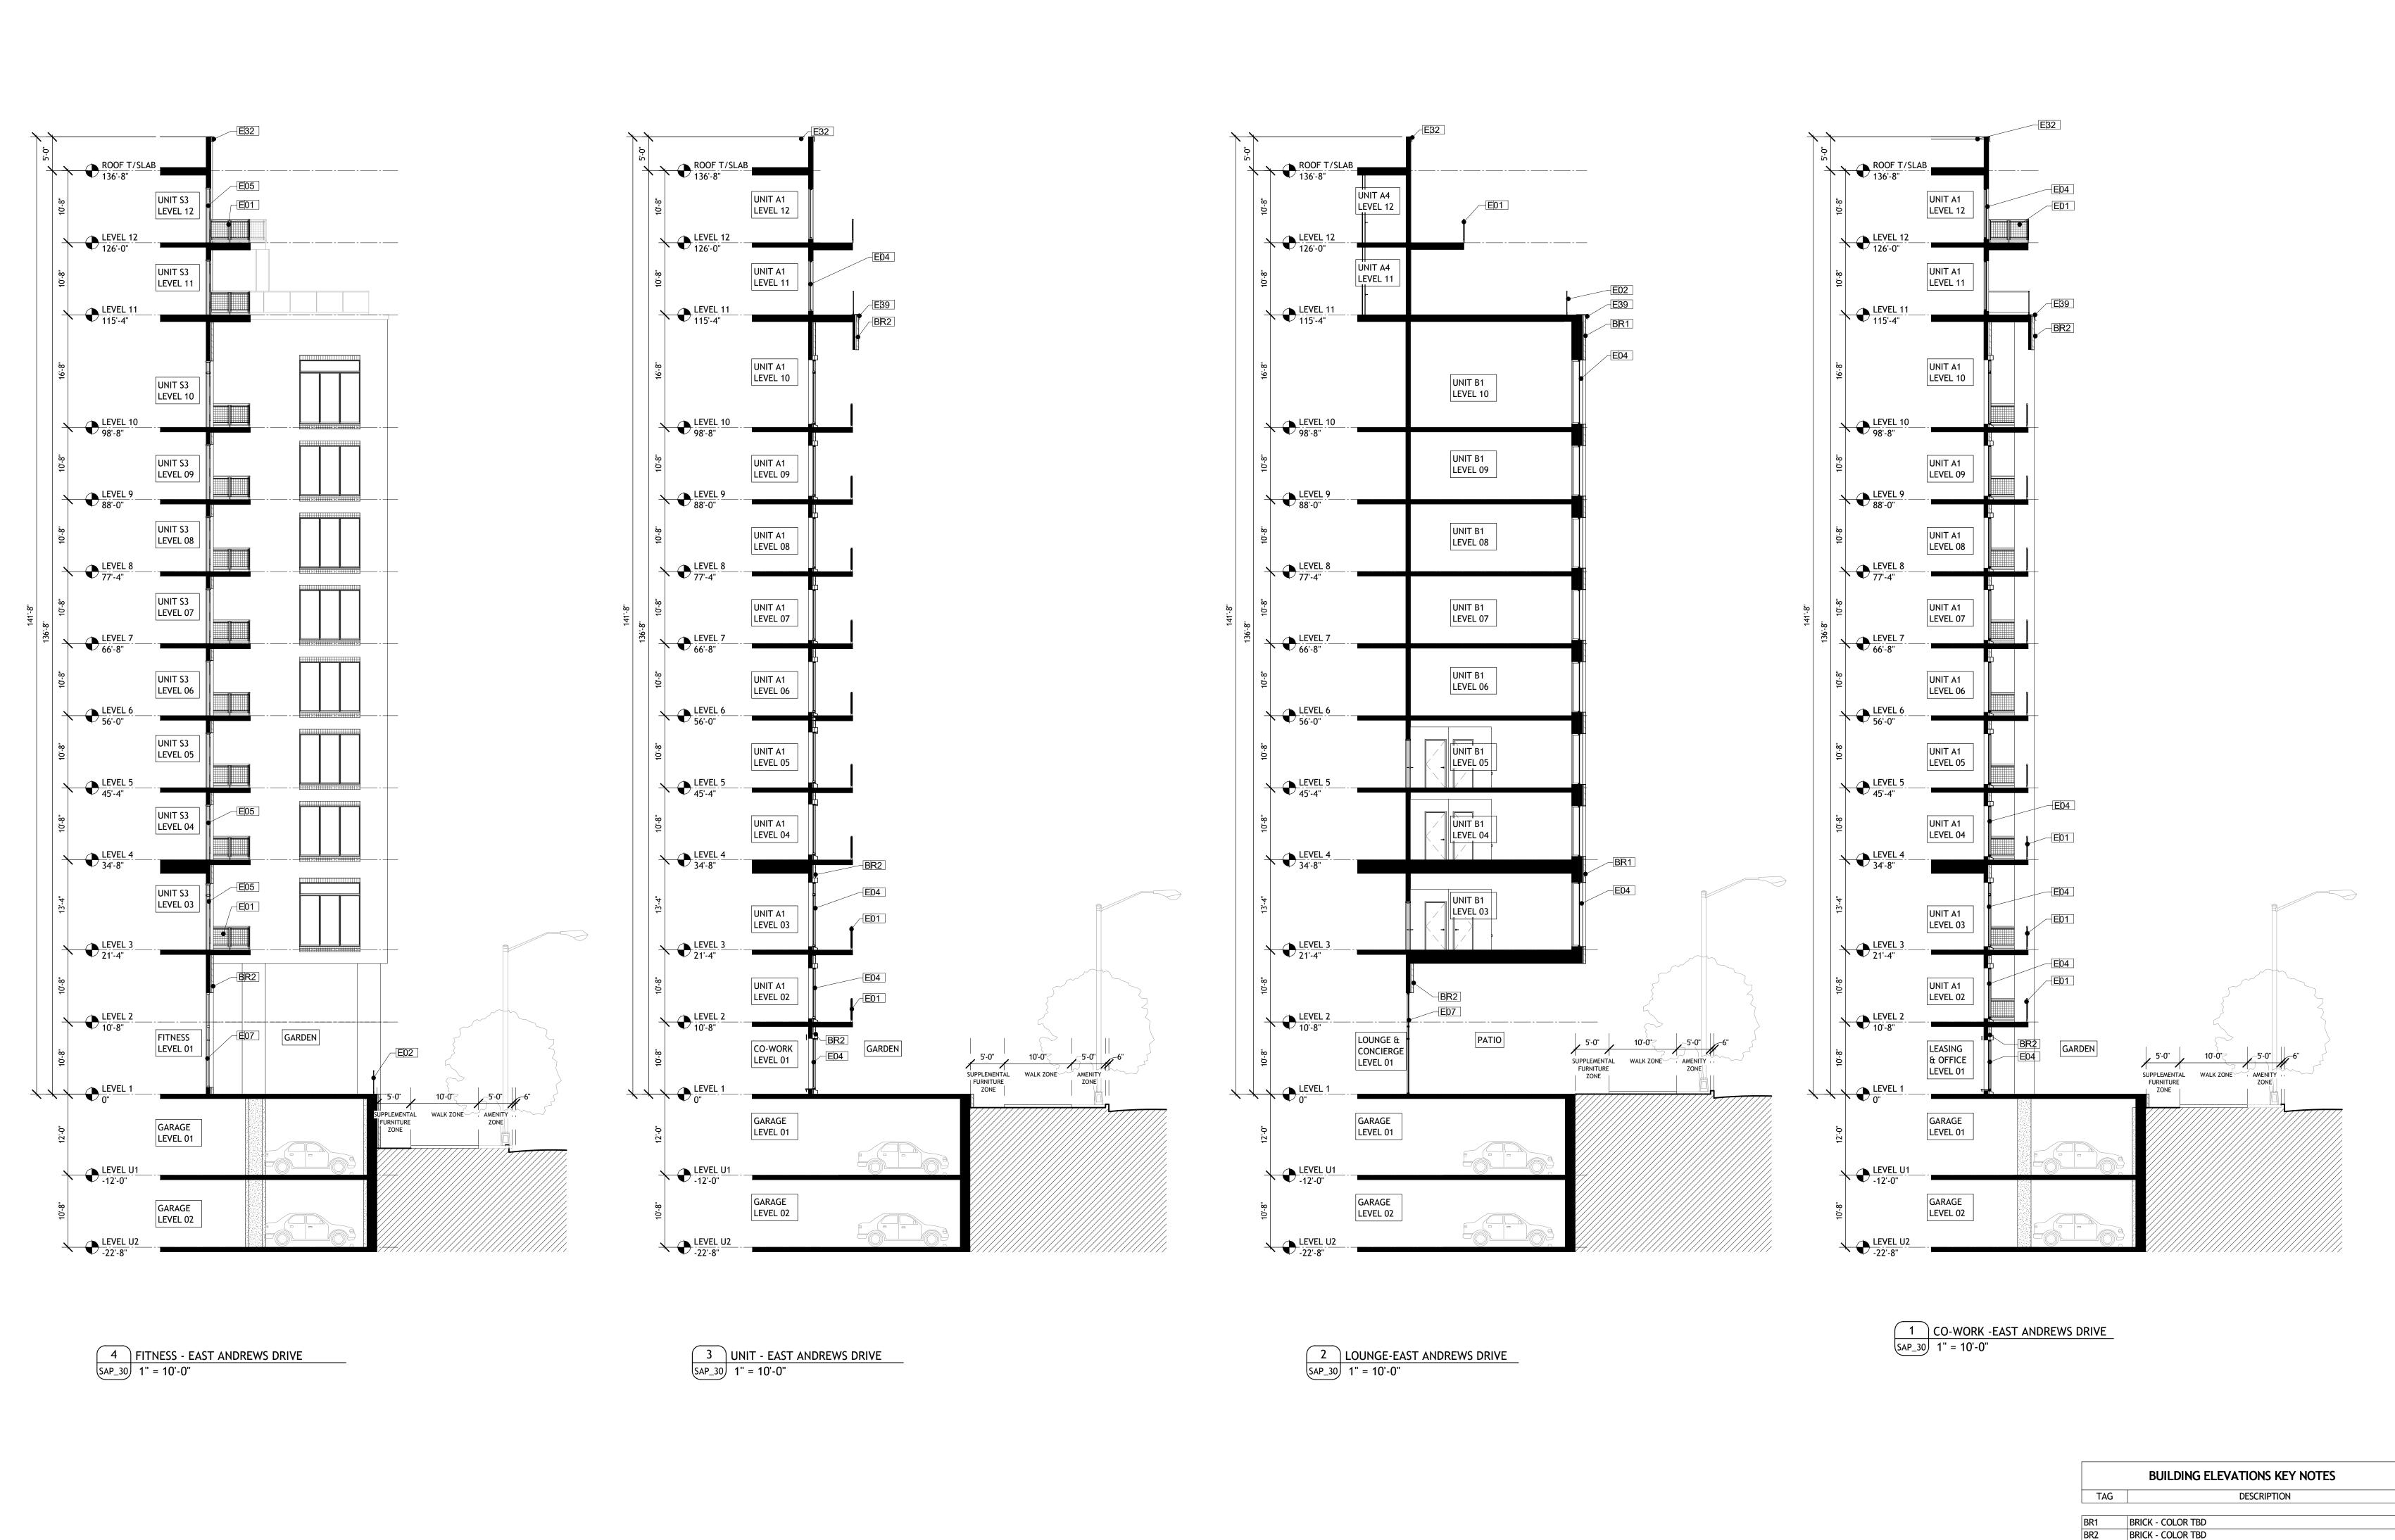

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SAP APPLICATION 9/15/2022

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CAMDEN ANDREWS 55 E ANDREWS DRIVE ATLANTA, GEORGIA 30305 FULTON COUNTY

SHEET TITLE: BUILDING SECTIONS AT STREET

BALCONY RAILING GLASS BALCONY RAILING

WINDOWS (SEE SCHEDULE) BALCONY DOOR (SEE SCHEDULE)

PREFINISHED METAL COPING

STOREFRONT DOOR (SEE SCHEDULE)

E39 PRE-FABRICATED METAL FLASHING - DARK BRONZE

SHEET NUMBER:

SAP_30