


EXAMPLE OF PROPRIETARY MULTI-LAYERED "NAGOYA" GLAZING SYSTEM. TO BE USED AS GENERAL (MAIN) GLASS FACADE, ON PEACHTREE ROAD.

N

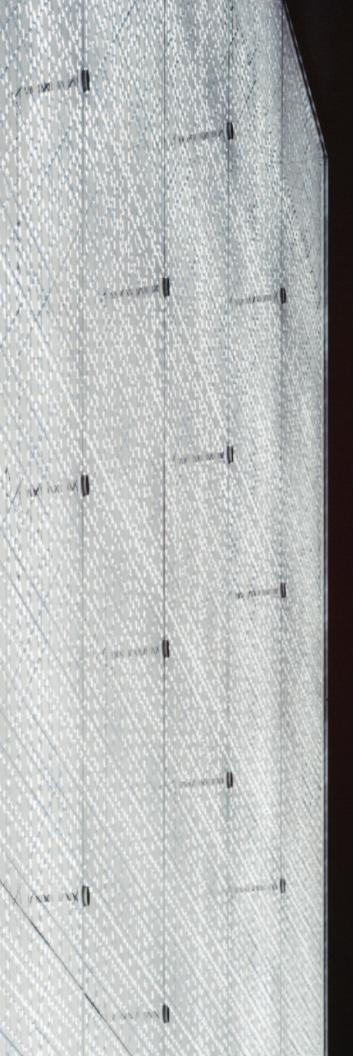

AN WM

M

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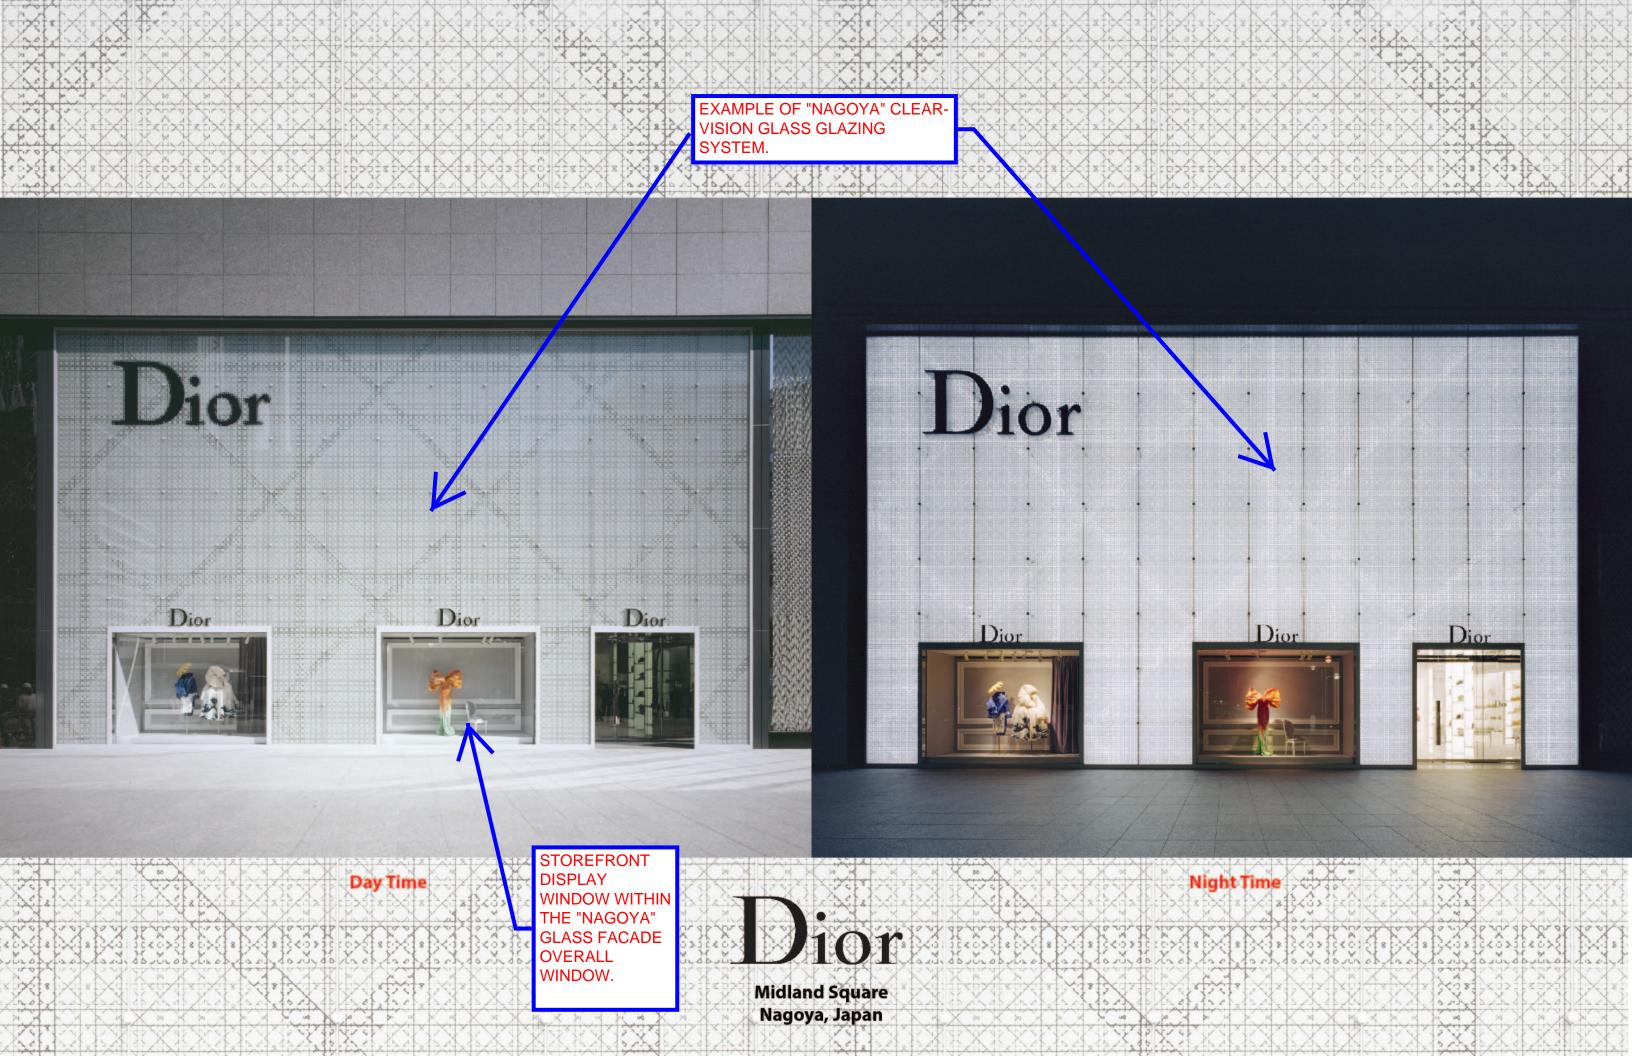
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Presentation Prepared By: AGD





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Dior 19 East 57th Street New York City, USA

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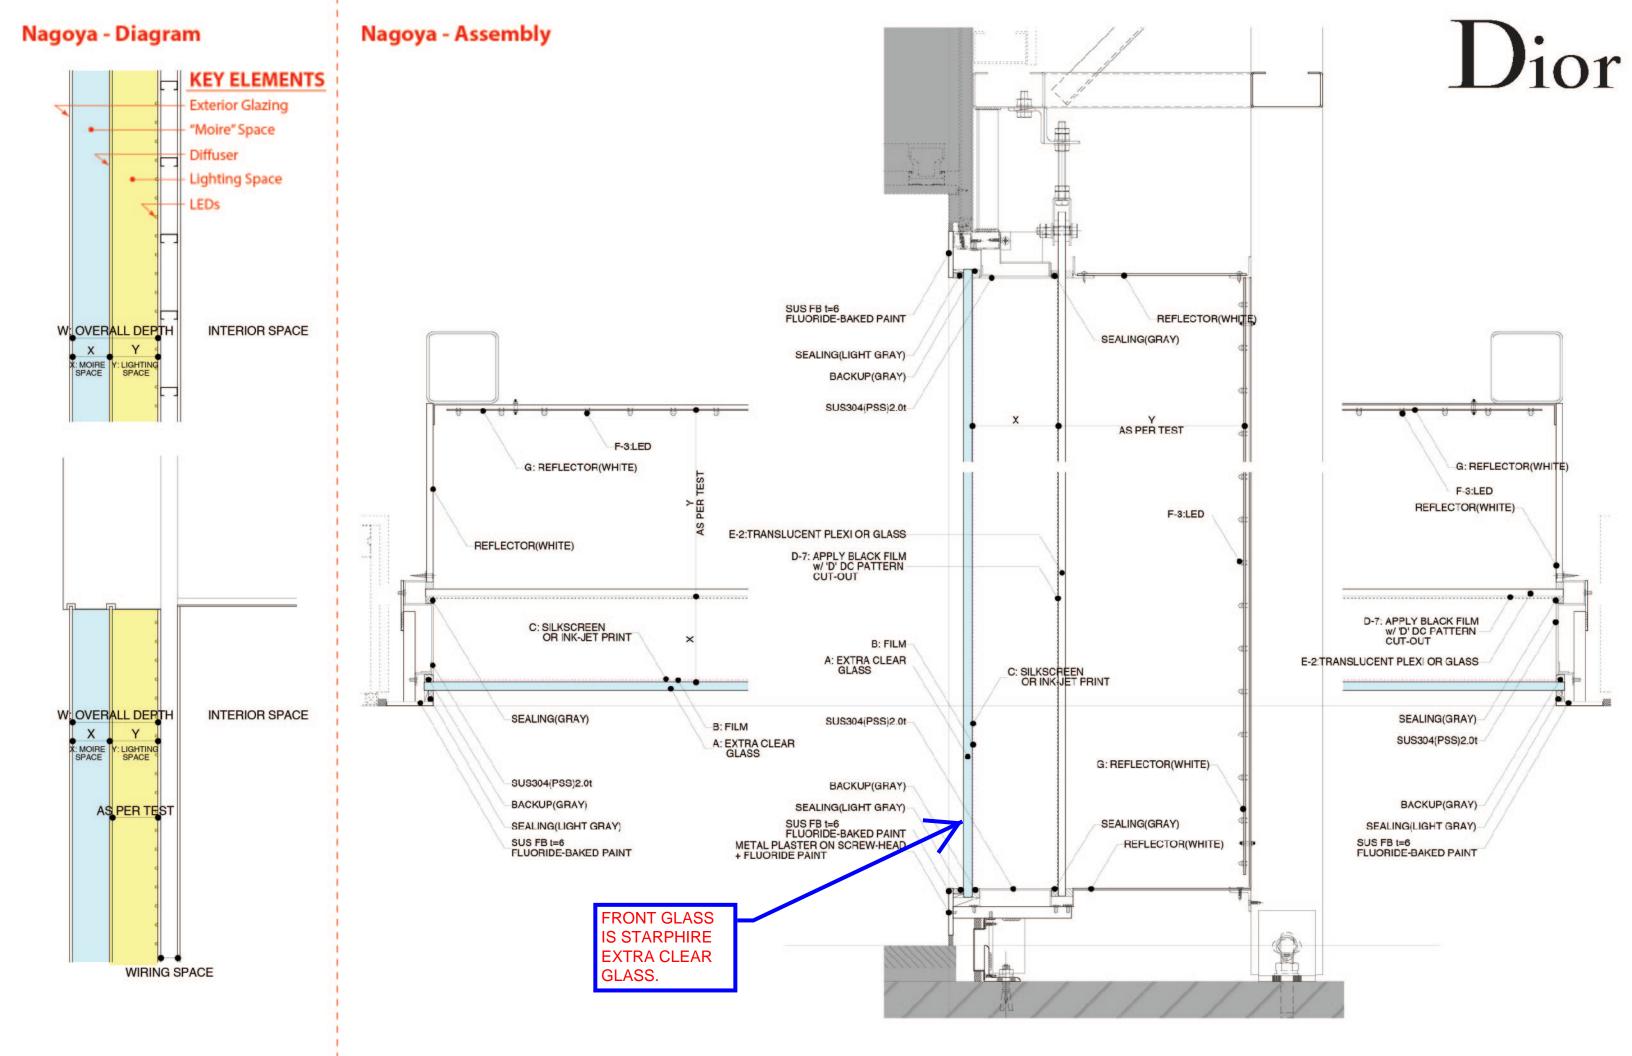
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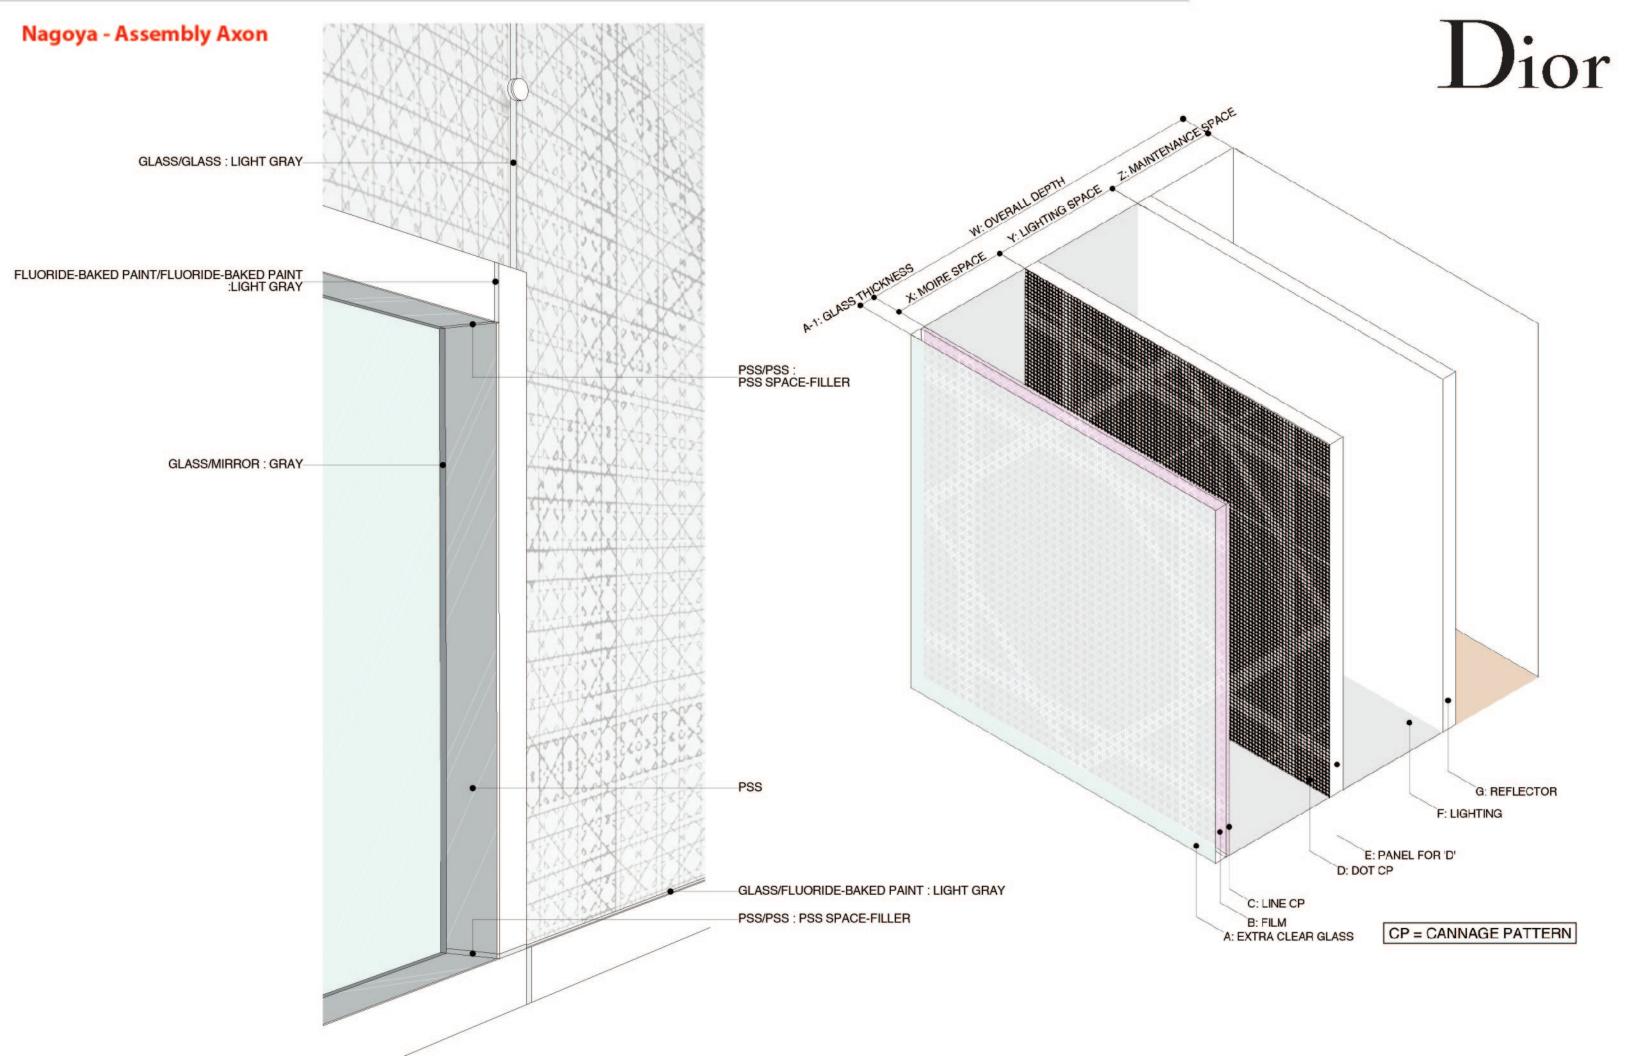
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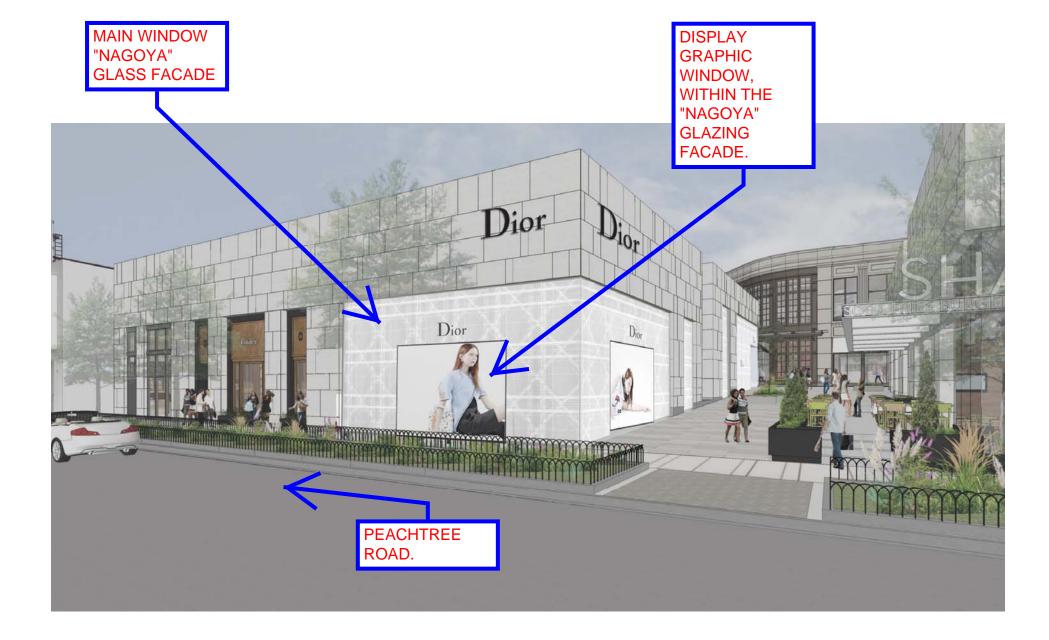
























10'-0" (DISPLAY WINDOW LENGTH) / 43'-6 $\frac{1}{2}$ " (BUILDING LENGTH) = 23% (COMPLIES)

= MAX. 25% OF BUILDING LENGTH

35'-5" (FENESTRATION LENGTH) / 43'-6 1/2" (BUILDING LENGTH) = 81% (COMPLIES) 2. DISPLAY WINDOW ALLOWANCE FOR FENESTRATION INCLUSION


= MIN. 65% OF BUILDING LENGTH

1. FENESTRATION ALLOWANCE


WINDOW CALCULATIONS:

*REFER ATLANTA MUNICODE 16-181.017 (5) "RELATIONSHIP OF BUILDING TO STREET":

35'-5" [10795] WINDOW 6 43'-61" [13271] FACADE LENGTH

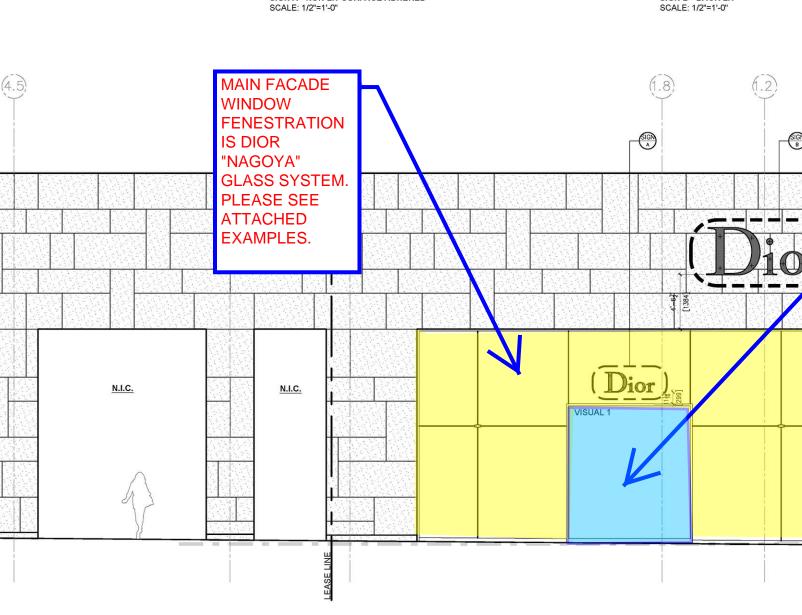


| ELEVATION AREA: | 1,353 SF |
|--------------------------|-------------------|
| SIGNAGE AREA: | |
| SIGN A | 7 SF |
| SIGN B | 40 SF |
| SIGNAGE SUB-TOTAL | 47 SF |
| SIGNAGE TO ELEVATION % : | 3.47% Complies |

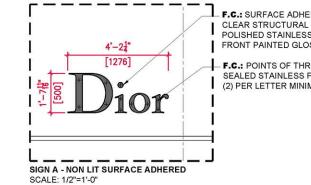


- F.C.: SURFACE ADHERED LOGO WITH CLEAR STRUCTURAL SILICONE. POLISHED STAINLESS STEEL SIDES, FRONT PAINTED GLOSS BLACK, TYP. F.C.: POINTS OF THROUGH-GLASS

SEALED STAINLESS FASTENER, TYP. (2) PER LETTER MINIMUM.

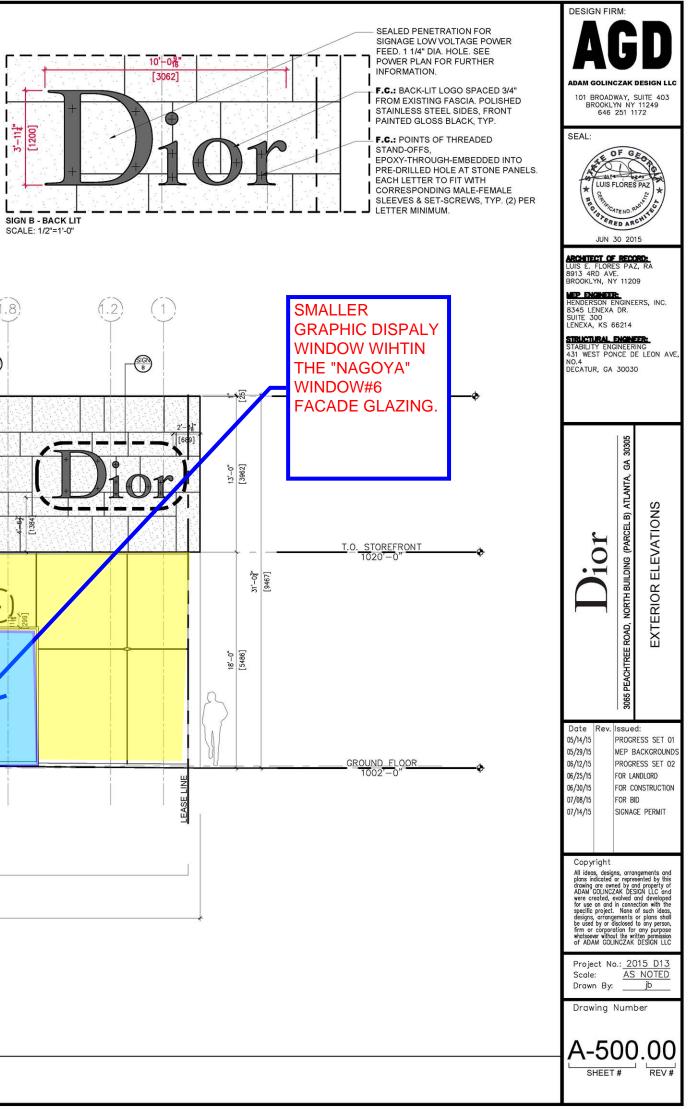


PROPOSED INTERIOR RENDERING

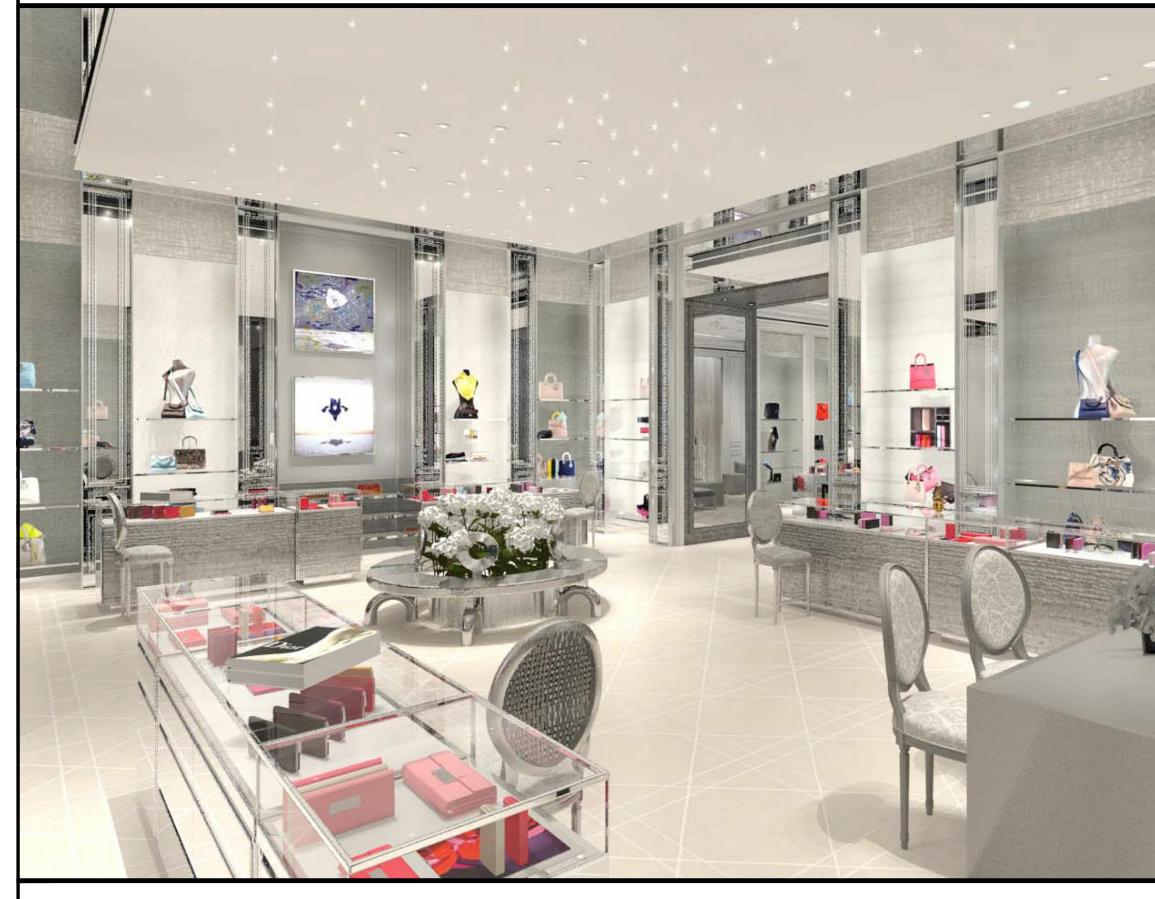


| TENANT: | LANDLORD: | TENANT COORDINATION: | EXPEDITOR: |
|-----------------------------|-----------------------------|-------------------------|------------------|
| CHRISTIAN DIOR COUTURE | OLIVER McMILLAN | SKYE GROUP | NATIONWIDE E |
| 19 EAST 57th STREET | 733 8тн AVENUE | 1100 SUPERIOR AVE | 691 JOHN WES |
| 11th FLOOR | SAN DIEGO, CA 92101 | SUITE 600 | AVE. NE |
| NEW YORK, NY 10022 | CONTACT: GREGORY WATTSON | CLEVELAND,OH 44114 | SUITE W |
| CONTACT: ADAM KOVACEVIC | PHONE: (619) 321-1111 | CONTACT: THOMAS DOWLING | ATLANTA,GA 3 |
| PHONE: (212) 931-2605 | gwattson@olivermcmillan.com | PHONE: (216)658-4306 | CONTACT: JOI |
| adam.kovacevic@lvmhuspc.com | | tdowling@skye-group.net | PHONE: (404) 2 |
| | | | permitconsulting |
| | | | |

BUCKHEAD ATLANTA, GA

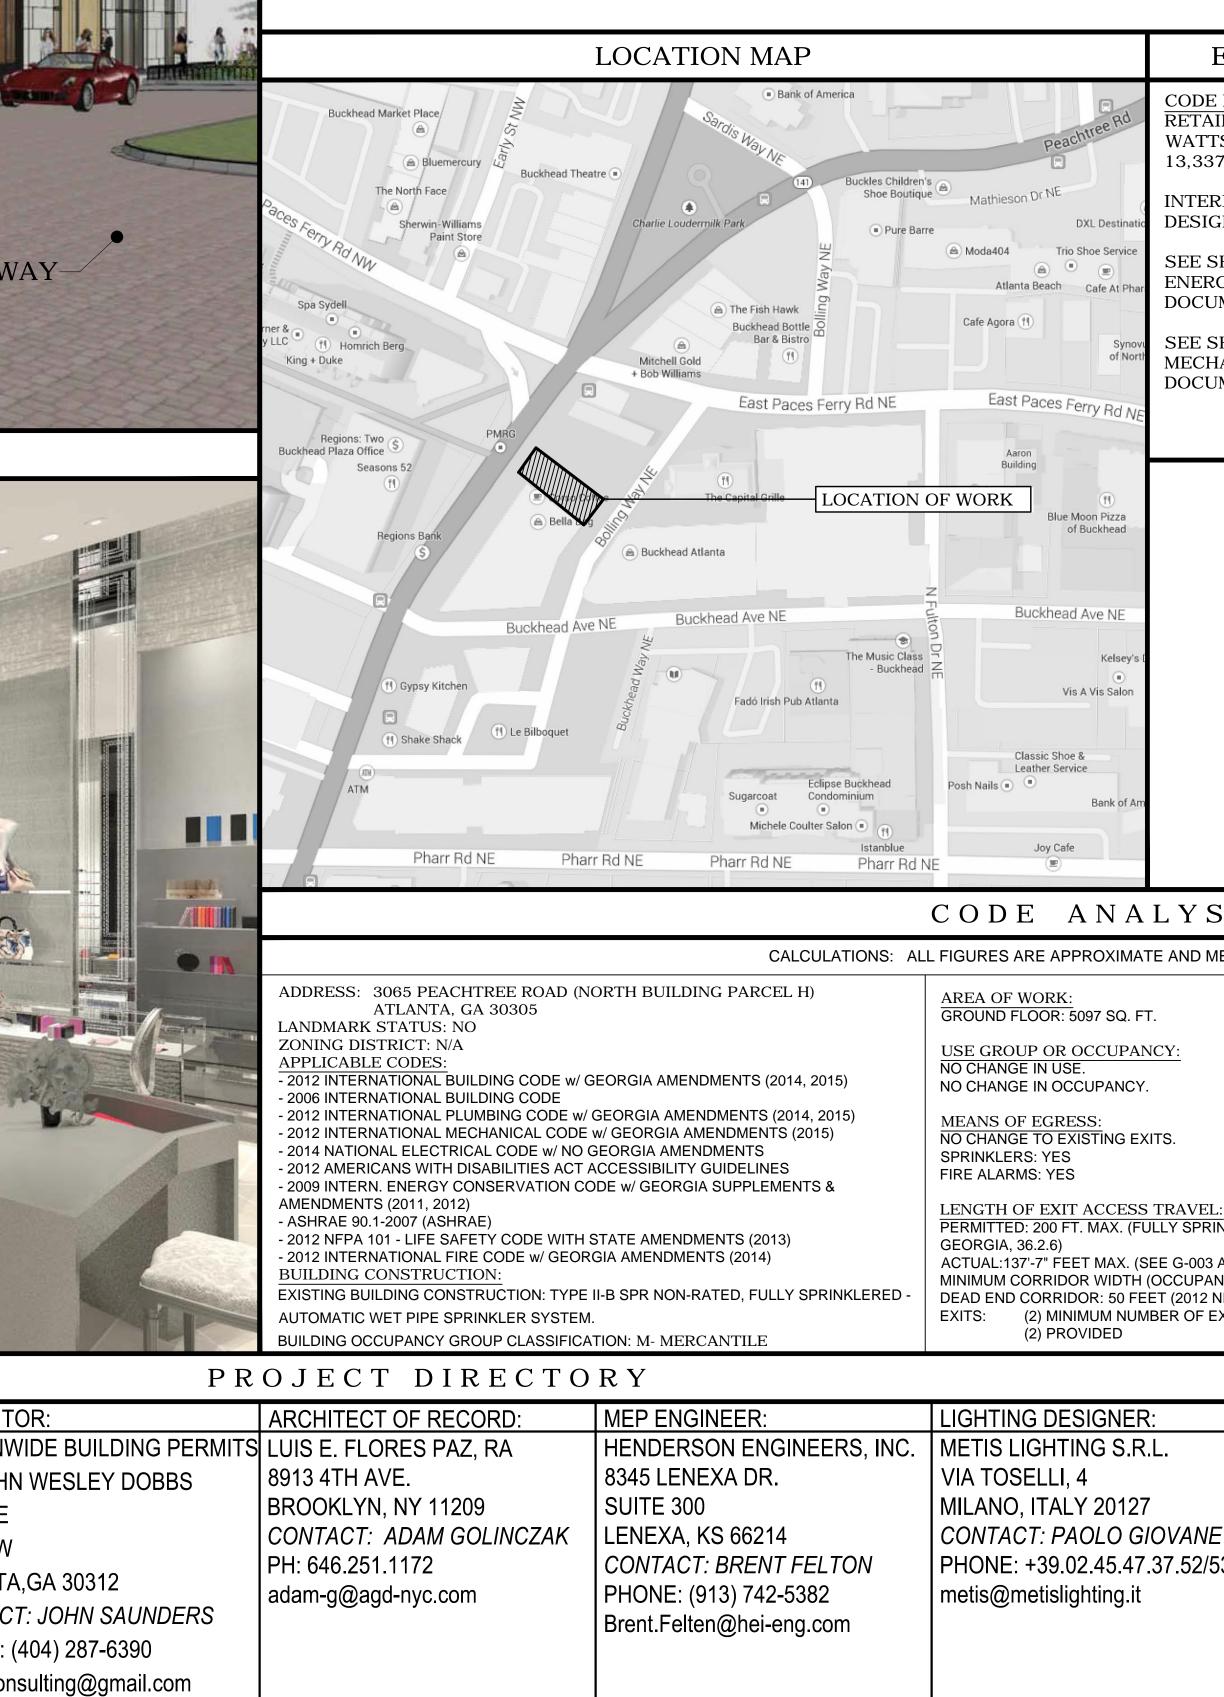


| 11 | | | GD |
|--|--|---|--|
| | | 101 BROAD BROOKL | ICZAK DESIGN LLC DWAY, SUITE 403 YN NY 11249 251 1172 |
| λ | | | |
| ENERCY ANALVSIS | SCOPE OF WORK | | 30 2015 |
| IL BUILDING TYPE IS / SQ. FT. ALLOWED: 7 TOTAL WATTAGE ALLOWED RIOR RETAIL STORE GNED WATTAGE: 12,918W TOTAL. HEET E-500 FOR ELECTRICAL GY COMPLIANCE MENTATION. HEET M-500 - M-502 FOR IANICAL ENERGY COMPLIANCE | SCOPE OF WORK 1. THE SCOPE INCLUDES INTERIOR RENOVATION, TRADES INCLUDE MECHANICAL, ELECTRICAL, PLUMBING AND STRUCTURAL. 2. NEW INTERIOR PARTITIONS, FINISHES & MILLWORK. 3. NEW SPRINKLER SYSTEM. 4. NEW STOREFRONT INFILL GLAZING SYSTEM AT EXISTING STOREFRONT STREET OPENINGS. | 8345 LENEXA SUITE 300 LENEXA, KS STRUCTURAL STABILITY EN | ES PAZ, RÁ /E. /Y 11209 R: ENGINEERS, INC. A DR. 66214 ENGINEER: GINEERING DNCE DE LEON AVE, |
| MENTATION. | | | 30305 |
| | SPECIAL INSPECTIONS | | TA, GA |
| • • • | ELECTRICAL INSPECTION MECHANICAL INSPECTION FINAL INSPECTION STRUCTURAL - SEE STRUCTURAL DRAWINGS FOR FURTHER INFORMATION | OT | NG (PARCEL B) ATLANTA SHEET |
| | FINISH REQUIREMENTS | $\mathbf{)}_{\mathbf{i}}$ | VER SH |
| | MERCANTILE SHOWROOMS ARE REQUIRED TO HAVE CLASS 'C' (OR HIGHER) FINISHES ON WALLS AND CEILING. CLASS 'C' FINISH REQUIRES FLAME SPREAD 76-200 SMOKE DEVELOPED INDEX 0-450 | | EACHTREE ROAD, NORTH I COV |
| SIS | | | L L |
| EASURED IN SQUARE FEET | | | 3065 |
| : IST FLOOR RETAIL (SALES AL CIRCULATION (E) STORAGE (B.O.H. TOTAL OCCUPA | DAD CALCULATION (TABLE 1004.1.2): AREA): 2350 SQ. FT. / 30 = 79 XIT STAIR) : 110 SQ. FT. / 100 = 2 A. & STORAGE): 2637 SQ. FT. / 100 = 27 ANCY LOAD: 108 OCC. | Date Rev. 05/14/15 05/29/15 06/12/15 06/25/15 06/30/15 | Issued: PROGRESS SET 01 MEP BACKGROUNDS PROGRESS SET 02 FOR LANDLORD FOR CONSTRUCTION |
| NKLERED) (2012 NFPA 101 AND G-004) NCY >50): 36 INCHES NFPA 101 GEORGIA, 36.2.5.2) XITS REQUIRED | | for use on and | gns, arrangements and or represented by this ned by and property of ZAK DESIGN LLC and evolved and developed in connection with the t. None of such ideas, gements or plans shall |
| STRUCTURAL ENGINEER: | DESIGNER/ MANAGER: | firm or corpor whatsoever withc of ADAM GOL | disclosed to any person, ration for any purpose but the written permission INCZAK DESIGN LLC |
| STABILITY ENGINEERING 431 WEST PONCE DE LEON AVE, NO. 4 | ADAM GOLINCZAK DESIGN LLC 101 BROADWAY, SUITE 403 BROOKLYN, NY 11249 | Project N Scale: Drawn By: | o.: <u>2015 D13</u> <u>AS NOTED</u> : jb |
| E DECATUR, GA 30030 53 <i>CONTACT: CHRIS MURPHY</i> PHONE: 404.377.9316 | CONTACT: ADAM GOLINCZAK PHONE: (646)251-1172 com adam-g@agd-nyc.com | Drawing | Number |

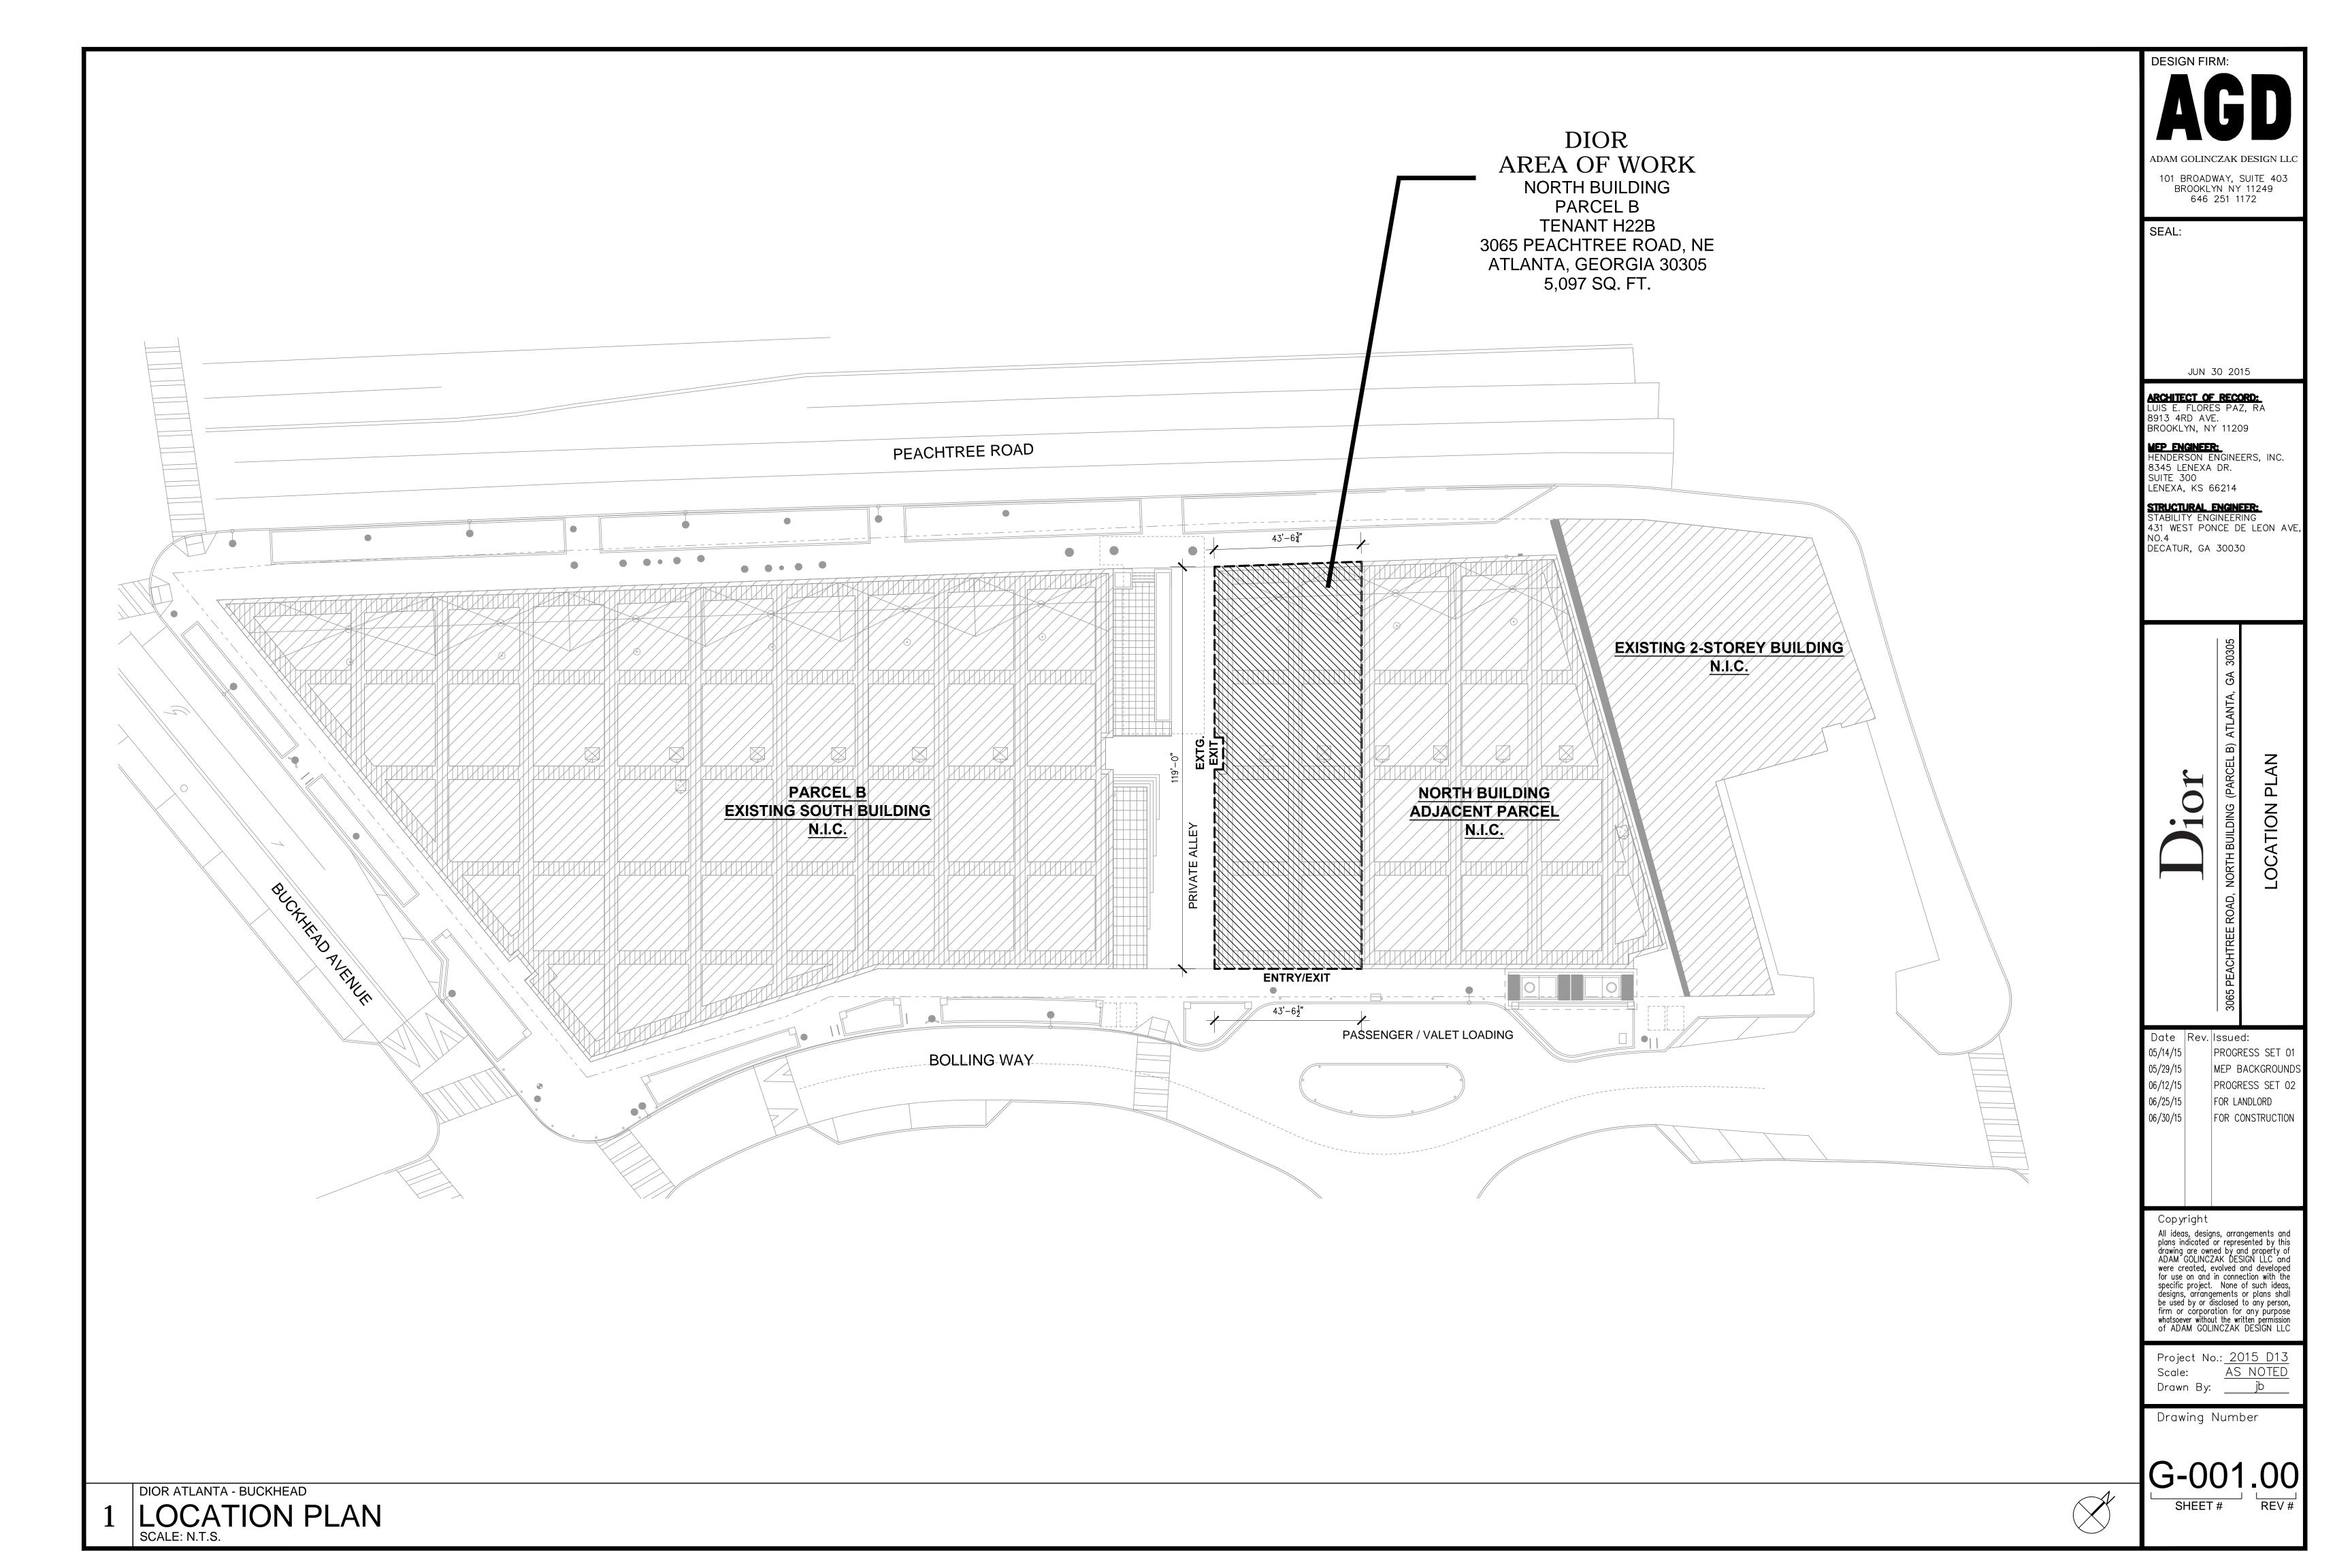


| | | 2015/ 06/ 30 - FOR PERMIT | | | | 2015/ 06/ 30 - FOR PERMIT | | | | 2 |
|----------------------|----------|--|-------|----------------------|----------|--|------|----------------------|----------|--------------|
| | | 2015/ 06/ 25 - FOR LANDLORD | | | | 2015/ 06/ 25 - FOR LANDLORD | | | | 2 |
| | | 2015/ 06/ 12 - PROGRESS SET 02 - CLIENT REVIEW | | | | 2015/ 06/ 12 - PROGRESS SET 02 - CLIENT REVIEW | | | | 2 |
| DWG. | # | ARCHITECTURAL | | DWG. | # | ARCHITECTURAL | | DWG. | # | MEC |
| G-000.00 | 01 | COVER SHEET | • | A-554.00 | 62 | STOREFRONT PLAN ENLARGED DETAILS | | M-000.00 | 01 | MECH |
| G-001.00 | 02 | LOCATION PLAN | • | A-555.00 | 63 | STOREFRONT WALL SECTIONS | • | M-100.00 | 02 | MECH |
| G-002.00 | 03 | DRAWING LIST | | A-556.00 | 64 | STOREFRONT WALL SECTIONS | • | M-101.00 | 03 | MECI |
| G-003.00 | 04 | EGRESS PLAN & LIFE SAFETY | | A-557.00 | 65 | STOREFRONT WALL SECTIONS DETAILS | • | M-200.00 | 04 | MECH |
| G-004A.00 | 05 | RESPONSIBILITY MATRIX | | A-558.00 | 66 | STOREFRONT WALL SECTIONS DETAILS | | M-201.00 | 05 | MECI |
| G-004B.00 | 06 | SIGNAGE STANDARDS, OWNER SUPPLIED ITEMS & NOTES | | A-559.00 | 67 | STOREFRONT INFILL INSTALLATION DIAGRAMS | | M-202.00 | 06 | MECH |
| G-005A.00 | 07 | | | A-560.00 | 68 | FACADE DETAILS | | M-300.00 | 07 | MECH |
| G-005B.00 | 08 | MILLWORK & FACADE LIGHTING SCHEDULE | | | | | | M-301.00 | 08 | MECH |
| G-006A.00 | 09 | POWER & SIGNAL SCHEDULE | | A-600.00 | 69 | | | M-400.00 | 09 | MECH |
| G-006B.00 | 10 11 | | | A-601.00 | 70 71 | HARDWARE SCHEDULE | | M-401.00 M-500.00 | 10 11 | MECH MECH |
| G-007.00 | 12 | PLUMBING FIXTURE, APPLIANCE & EQUIPMENT SCHEDULE CONSTRUCTION DETAILS: BASE & TRANSITION TYPE DETAILS | - | A-602.00 A-603.00 | 71 | DOOR DETAILS DOOR DETAILS | | M-500.00 | 12 | MECH |
| G-008.00 G-009.00 | 12 | CONSTRUCTION DETAILS: PARTITION TYPES | - | A-003.00 | 12 | DOOR DE TAILS | • | M-502.00 | 12 | MECH |
| G-009.00 G-010.00 | 13 | MATERIAL LEGEND | | A-701.00 | 73 | STAIR A SECTION ELEVATIONS | | | | |
| G-010.00 | 15 | MILLWORK PROFILES | | A-702.00 | 74 | STAIR A PLAN | | | | |
| G-011.00 | 16 | MILLWORK DECORATIVE PAINTING | • | A-703.00 | 75 | MISCELLANEOUS STAIR DETAILS | | DWG. | # | ELEC |
| 0-012.00 | | | | | | | | E-000.00 | 01 | ELEC |
| DM-101.00 | 17 | DEMOLITION PLAN | • | | | | | E-100.00 | 02 | ELEC |
| | | | | | | | | E-101.00 | 03 | ELEC |
| A-201.00 | 18 | MASTER PLAN | • | | 1 | | | E-102.00 | 04 | ELEC |
| A-202.00 | 19 | PARTITION PLAN | • | | | | | E-103.00 | 05 | ELEC |
| A-203.00 | 20 | POWER / SIGNAL, WALL & GROUND LIGHTING PLAN | • | | | | | E-200.00 | 06 | ELEC |
| A-204.00 | 21 | FLOOR FINISH PLAN | • | | | | | E-201.00 | 07 | ELEC |
| A-205.00 | 22 | FURNITURE PLAN | • | | | | | E-300.00 | 08 | ELEC |
| | | | | | | | | E-301.00 | 09 | ELEC |
| A-301.00 | 23 | REFLECTED CEILING PLAN | • | | | | | E-400.00 | 10 | ELEC |
| A-302.00 | 24 | CEILING CONSTRUCTION PLAN | • | | | | | E-401.00 | 11 | ELEC |
| A-303.00 | 25 | CEILING LIGHTING & DEVICES | | | | | | E-500.00 | 12 | ELEC |
| A-304.00 | 26 | SECURITY PLAN | • | | | | | | | |
| A-305.00 | 27 | ENLARGED CEILING CONSTRUCTION PLAN | | | | | | DWG. | # | PLUN |
| A-306.00 | 28 | | | | | | | P-000.00 | 01 | PLUM |
| A-307.00 | 29 | | | | | | | P-100.00 | 02 | WAST |
| A-308.00 | 30 | CEILING DETAILS | • | | | | | P-200.00 | 03 | PLUM |
| A 400.00 | 24 | | | | | | | P-300.00 | 04 | PLUM |
| A-400.00 | 31 32 | INTERIOR ELEVATION INTERIOR ELEVATION | | | | | | P-400.00 | 05 | PLUM |
| A-401.00 A-402.00 | 32 | INTERIOR ELEVATIONS - HANDBAGS | - | | | | | P-401.00 | 06 | PLUM |
| A-402.00 A-403.00 | 33 | INTERIOR ELEVATIONS - HANDBAGS | | | | | | | | _ |
| A-403.00 A-404.00 | 35 | INTERIOR ELEVATIONS - SHOES | | | | | | DWG. | # | FIRE |
| A-404.00 | 36 | INTERIOR ELEVATIONS - SHOES | | | | | | F-000.00 | 01 | FIRE |
| A-406.00 | 37 | INTERIOR ELEVATIONS - READY TO WEAR | | | | | | F-100.00 | 01 | FIRE |
| A-407.00 | 38 | INTERIOR ELEVATIONS - READY TO WEAR | | | | | | F-200.00 | 03 | FIRE |
| A-408.00 | 39 | INTERIOR ELEVATIONS - VIP LOUNGE | | | | | | F-201.00 | 04 | FIRE |
| A-409.00 | 40 | INTERIOR ELEVATIONS - VIP LOUNGE | | | | | | | | |
| A-410.00 | 41 | INTERIOR ELEVATIONS - VIP FITTING ROOM | | | | | | | | - |
| A-411.00 | 42 | INTERIOR ELEVATIONS - VIP VESTIBULE | | | | | | | | + |
| A-412.00 | 43 | ENLARGED PLAN & INTERIOR ELEVATIONS - WOMEN'S RESTROOM | • | | | | | DWG. | # | STRI |
| A-413.00 | 44 | ENLARGED PLAN & INTERIOR ELEVATIONS - MEN'S RESTROOM | • | | | | Þ | S-000.00 | 01 | STRU |
| A-414.00 | 45 | INTERIOR ELEVATIONS - FITTING ROOM VESTIBULE | | | | | | S-100.00 | 02 | FOUN |
| A-415.00 | 46 | INTERIOR ELEVATIONS - FITTING ROOM | | | | | | S-101.00 | 03 | ROOF |
| A-416.00 | 47 | INTERIOR ELEVATIONS - ADA FITTING ROOM | • | | | | | S-200.00 | 04 | ELEV |
| | | | | | | | | S-201.00 | 05 | ELEV |
| A-450.00 | 48 | INTERIOR ELEVATIONS - CASH WRAP | | | | | | S-300.00 | 06 | STOR |
| A-450B.00 | 49 | INTERIOR ELEVATIONS - CASH WRAP DETAILS | | | | | | S-301.00 | 07 | SECT |
| A-450C.00 | 50 | INTERIOR ELEVATIONS - CASH WRAP DETAILS | | | | | | | | |
| A-451.00 | 51 | INTERIOR ELEVATIONS - OFFICE | | | | | | | | |
| A-452.00 | 52 | ENLARGED PANTRY PLAN & INTERIOR ELEVATIONS - BOH | | | | | | | | |
| A-453.00 | 53 | INTERIOR ELEVATIONS - IT/AV/SECURITY CLOSET | | | | | | | | |
| A-454.00 | 54 | INTERIOR ELEVATIONS - SHOE BACK-OF-HOUSE | | | | | | | | <u> </u> |
| | | | | | | | | | | |
| A-500.00 | 55 | | | | | | | | | |
| A-501.00 | 56 | | | | | | | | | |
| A-502.00 | 57 | EXTERIOR ELEVATIONS | | | | | | | | |
| A-550.00 | 58 | STOREFRONT PLAN DETAILS | • | | | | | | | |
| A-551.00 | 59 | STOREFRONT PLAN DETAILS | | | | | | | | - |
| A-552.00 | 60 | STOREFRONT PLAN ENLARGED DETAILS | | | | | | | | |
| A-553.00 | 61 | STOREFRONT PLAN ENLARGED DETAILS | • | | | | | | | |
| | 1 | | | | 1 | • | | | 1 | 1 |


| | | DESIGN FIRM: |
|--|----|---|
| 2015/ 06/ 30 - FOR PERMIT 2015/ 06/ 25 - FOR LANDLORD | | |
| 2015/06/12 - PROGRESS SET 02 CLIENT REVIEW | | AGD |
| | | ADAM GOLINCZAK DESIGN LLC |
| CHANICAL LEGEND AND GENERAL NOTES | | 101 BROADWAY, SUITE 403 |
| CHANICAL PIPING PLAN | | BROOKLYN NY 11249 646 251 1172 |
| CHANICAL DETAILS | | – – SEAL: |
| CHANICAL DETAILS | | |
| CHANICAL DETAILS | | _ |
| CHANICAL SCHEDULES CHANICAL SCHEDULES | | - |
| CHANICAL SPECIFICATIONS | | |
| CHANICAL SPECIFICATIONS | | |
| CHANICAL ENERGY CODE COMPLIANCE DOCUMENTATION | | JUN 30 2015 |
| CHANICAL ENERGY CODE COMPLIANCE DOCUMENTATION | | ARCHITECT OF RECORD: |
| CHANICAL ENERGY CODE COMPLIANCE DOCOMENTATION | | LUIS E. FLORES PAZ, RA 8913 4RD AVE. BROOKLYN, NY 11209 |
| | | MEP ENGINEER: |
| ECTRICAL | | HENDERSON ENGINEERS, INC. 8345 LENEXA DR. SUITE 300 |
| ECTRICAL LEGENDS AND GENERAL NOTES | | LENEXA, KS 66214 — |
| | | - STABILITY ENGINEERING 431 WEST PONCE DE LEON AVE, |
| ECTRICAL POWER PLAN | | 431 WEST PONCE DE LEON AVE, |
| ECTRICAL LOW VOLTAGE PLAN | | |
| ECTRICAL LIGHTING CONTROL DETAILS | | 1 |
| ECTRICAL LIGHTING SCHEDULES | | |
| | | 05 |
| ECTRICAL SCHEDULES ECTRICAL SPECIFICATIONS | | - 30305 |
| ECTRICAL SPECIFICATIONS | | - B |
| ECTRICAL COMPLIANCE DOCUMENTATION | | ATLANTA |
| | | |
| | | |
| JMBING GENERAL NOTES, LEGENDS AND SCHEDULES | | PARCEL LIST |
| JMBING DETAILS | | |
| JMBING RISER DIAGRAMS | | |
| JMBING SPECIFICATIONS | •• | |
| JMBING SPECIFICATIONS | | |
| | | ROAD, |
| RE ALARM | | |
| E PROTECTION LEGENDS, NOTES AND DETAILS | | PEACHTREE |
| E PROTECTION PLAN | | 2 DE/ |
| E ALARM SPECIFICATIONS | | 3065 |
| L SPRINKLER SPECIFICATIONS | | Date Rev. Issued: |
| | | 05/14/15 PROGRESS SET 01 05/29/15 MEP BACKGROUNDS |
| | | 05/29/15 MEP BACKGROUNDS 06/12/15 PROGRESS SET 02 |
| RUCTURAL | | 06/25/15 FOR LANDLORD 06/30/15 FOR CONSTRUCTION |
| RUCTURAL NOTES | | |
| OF FRAMING PLAN | | |
| EVATIONS | | |
| EVATIONS | | |
| OREFRONT SECTIONS | | Copyright All ideas, designs, arrangements and plane indicated or corresponded by this |
| CTIONS & DETAILS | | All ideas, designs, arrangements and plans indicated or represented by this drawing are owned by and property of ADAM GOLINCZAK DESIGN LLC and |
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| | | b) use on and in connection with the specific project. None of such ideas, designs, arrangements or plans shall be used by or disclosed to any person, firm or corporation for any purpose whatsoever without the written permission of ADAM GOLINCZAK DESIGN LLC |
| | | whatsoever without the written permission of ADAM GOLINCZAK DESIGN LLC |
| | | - Project No.: <u>2015 D13</u> |
| | | _ Scale: <u>AS_NOTED</u> Drawn By: jb |
| | | - Drawing Number |
| | | |
| | | |
| | | G-002.00 |
| | | SHEET # REV # |
| | | _ |
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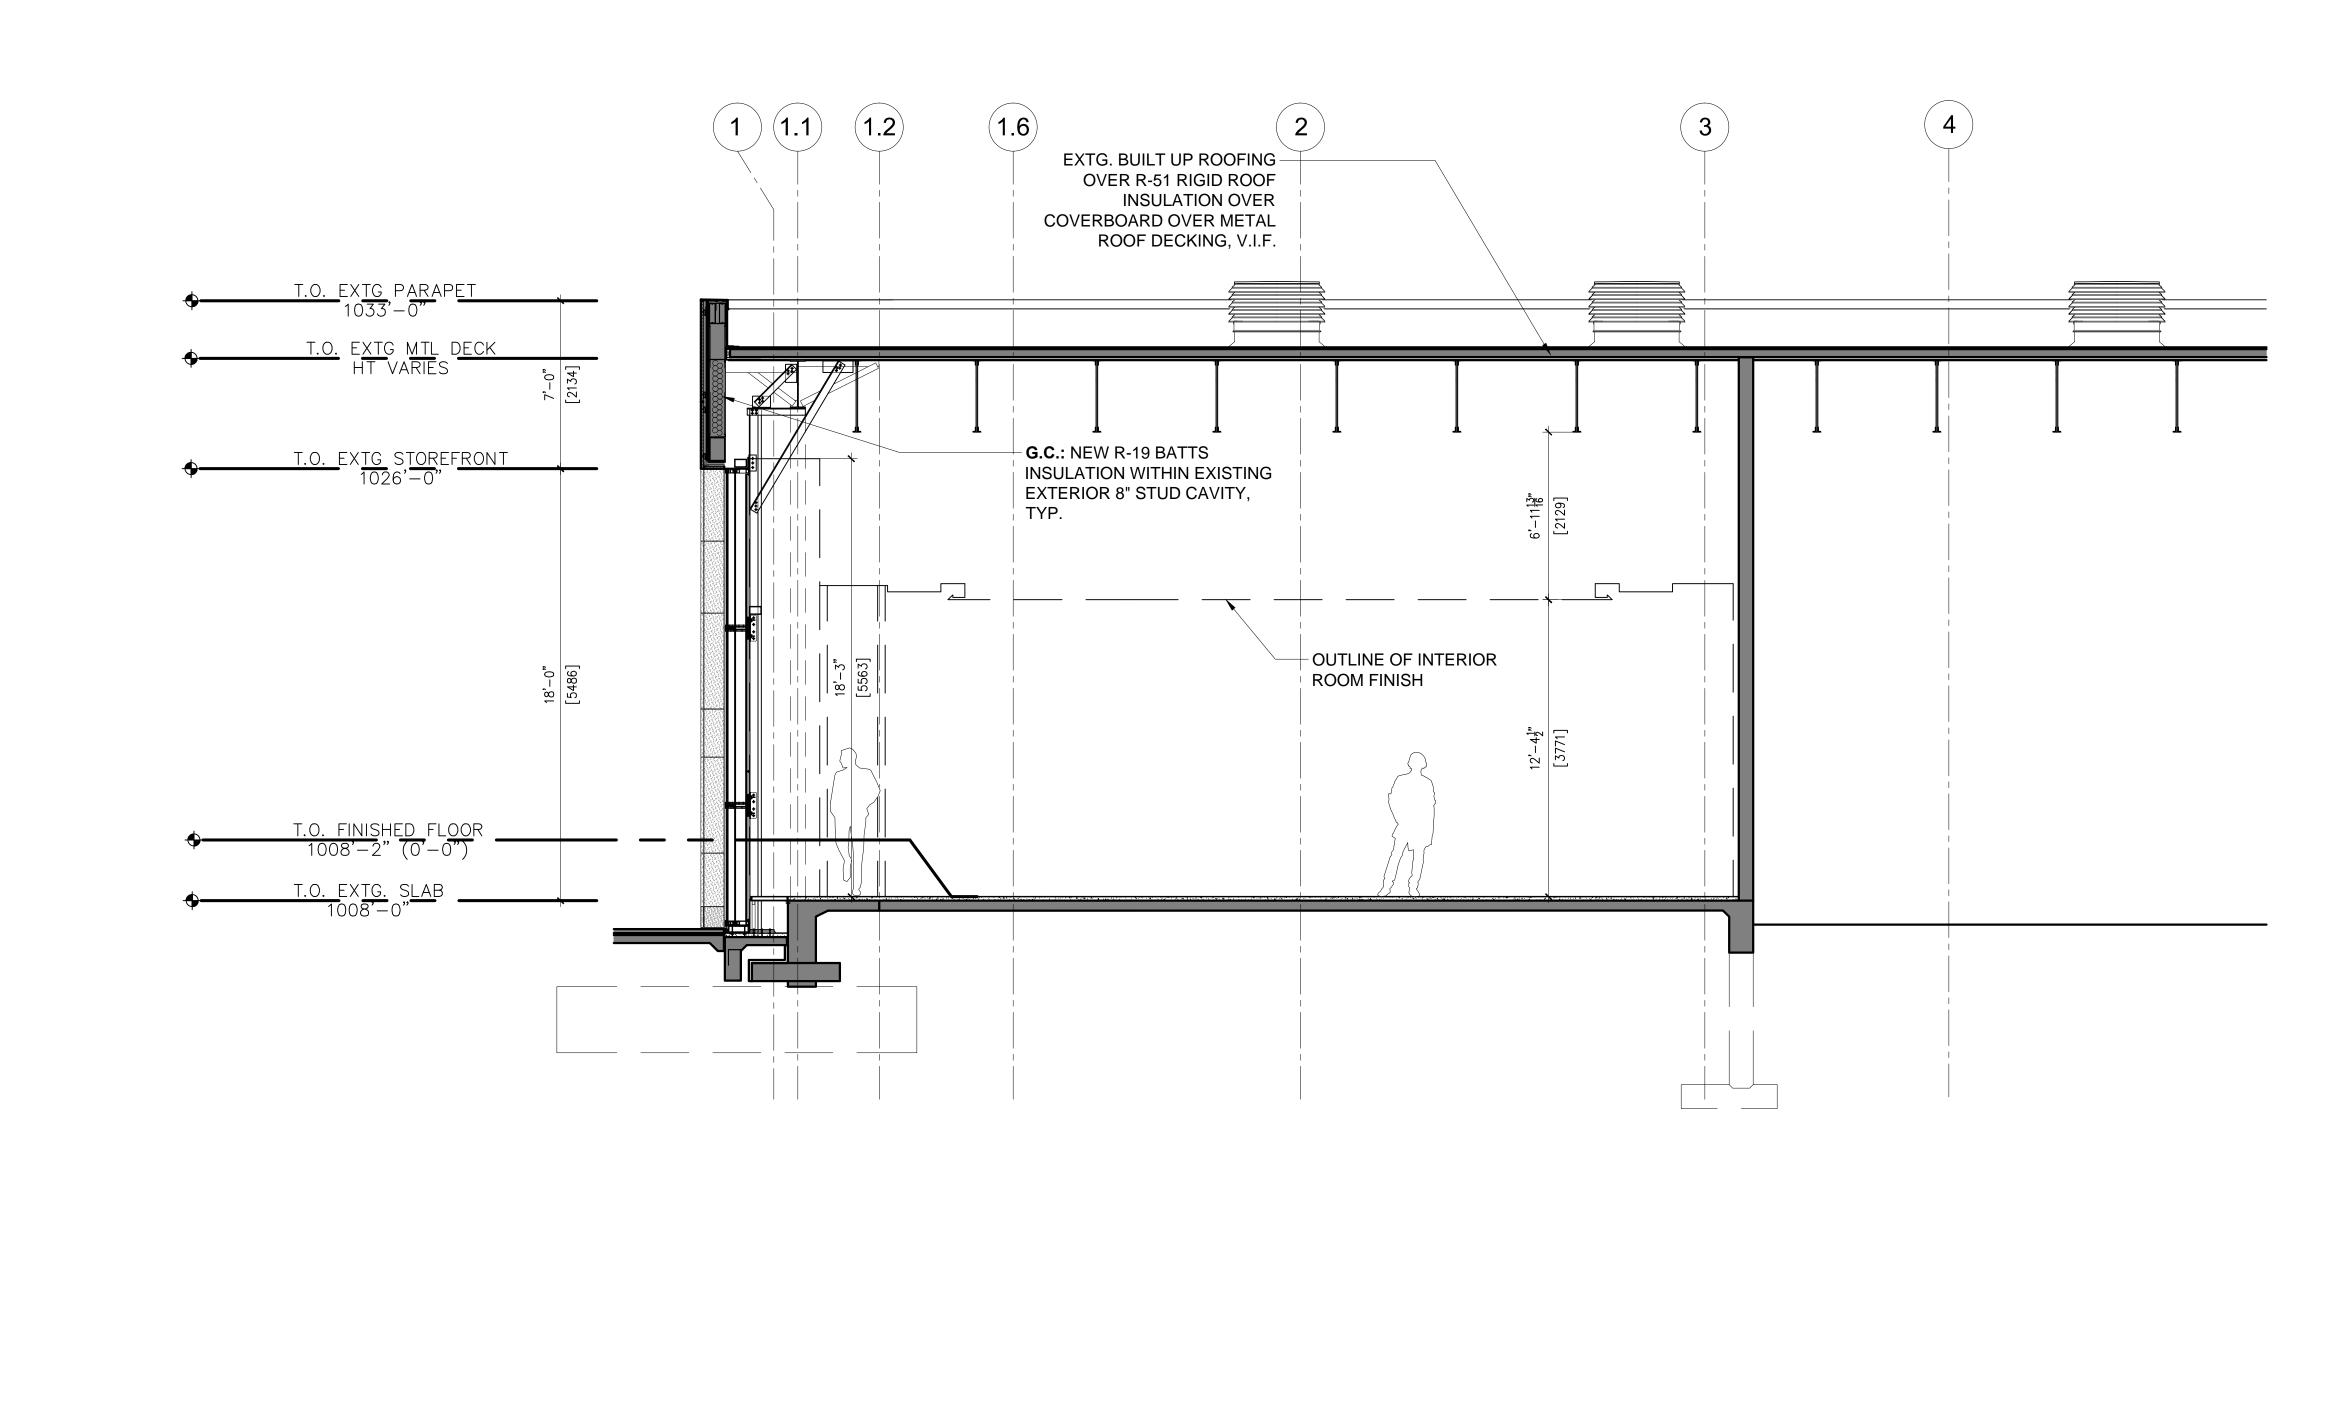

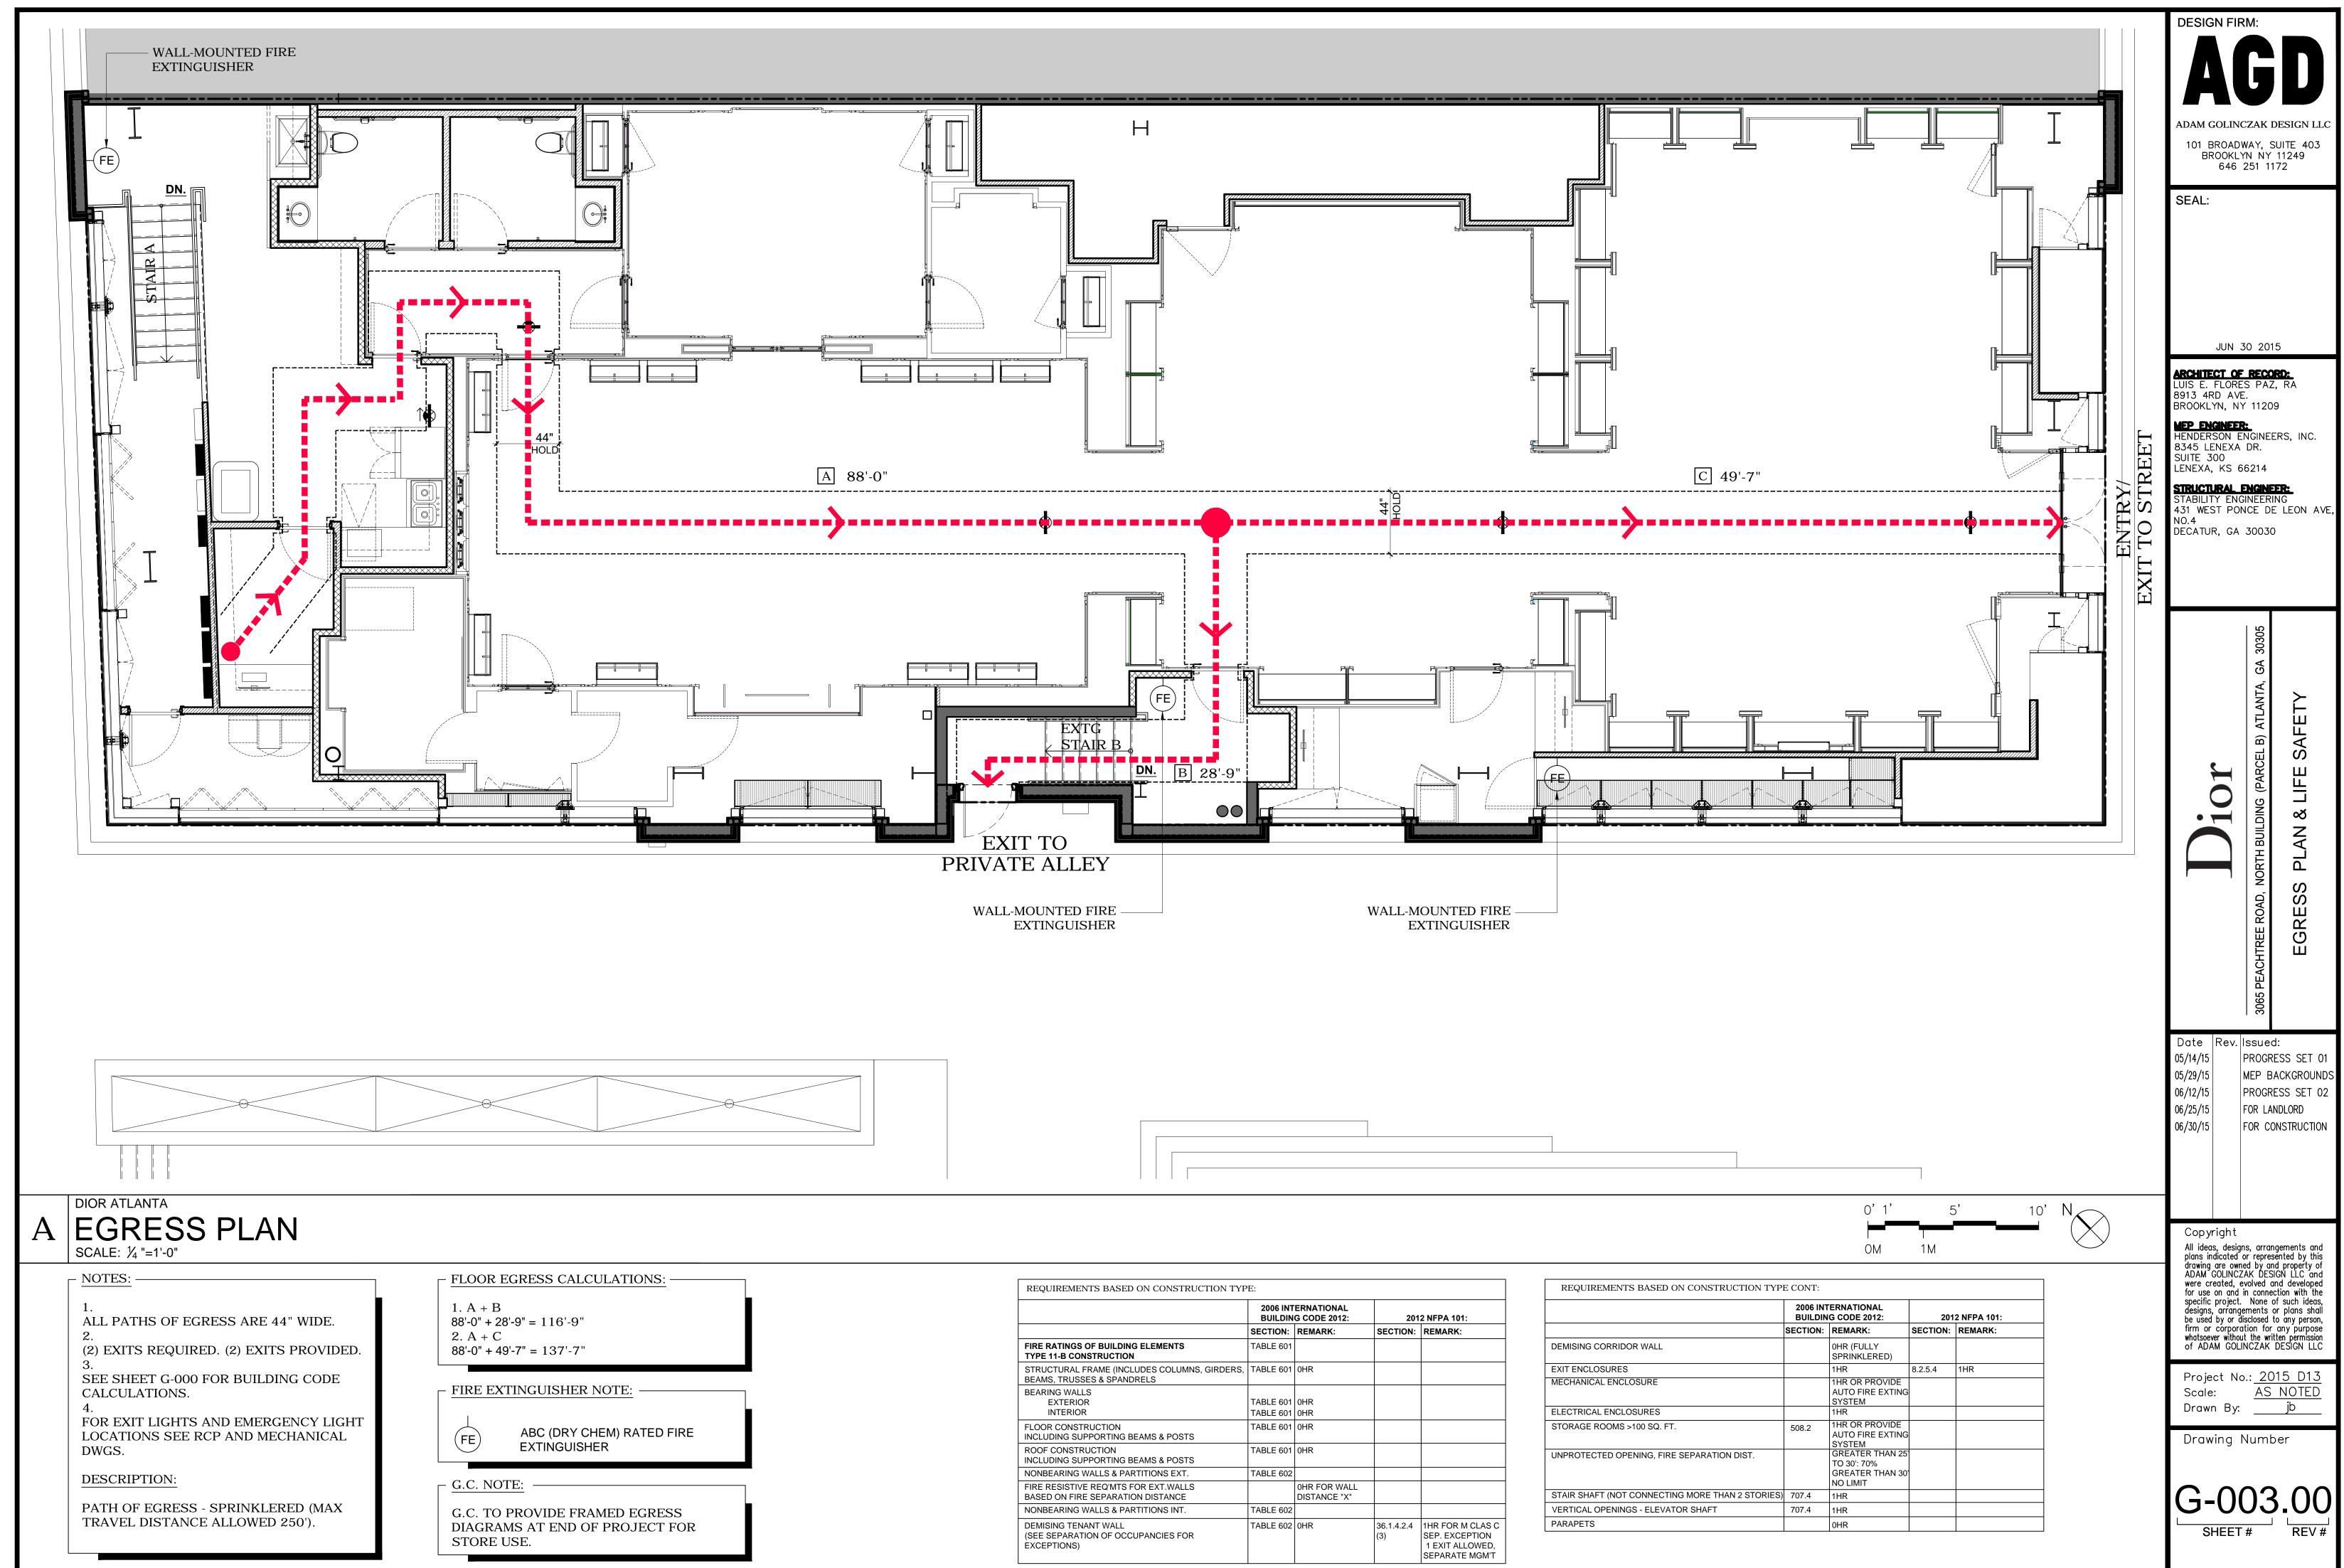
| | | ERNATIONAL G CODE 2012: | 201 | 2 NFPA 101: | | |
|---|------------------------|------------------------------|-------------------|---|-----|---------|
| | SECTION: | REMARK: | SECTION: | REMARK: | | |
| FIRE RATINGS OF BUILDING ELEMENTS TYPE 11-B CONSTRUCTION | TABLE 601 | | | | DE | MISING |
| STRUCTURAL FRAME (INCLUDES COLUMNS, GIRDERS, BEAMS, TRUSSES & SPANDRELS | TABLE 601 | 0HR | | | | |
| BEARING WALLS EXTERIOR INTERIOR | TABLE 601 TABLE 601 | | | | | ECTRICA |
| FLOOR CONSTRUCTION INCLUDING SUPPORTING BEAMS & POSTS | TABLE 601 | - | | | | ORAGE I |
| ROOF CONSTRUCTION INCLUDING SUPPORTING BEAMS & POSTS | TABLE 601 | OHR | | | UN | IPROTEC |
| NONBEARING WALLS & PARTITIONS EXT. | TABLE 602 | | | | | |
| FIRE RESISTIVE REQ'MTS FOR EXT.WALLS BASED ON FIRE SEPARATION DISTANCE | | 0HR FOR WALL DISTANCE "X" | | | ST | AIR SHA |
| NONBEARING WALLS & PARTITIONS INT. | TABLE 602 | | | | VE | RTICAL |
| DEMISING TENANT WALL (SEE SEPARATION OF OCCUPANCIES FOR EXCEPTIONS) | TABLE 602 | OHR | 36.1.4.2.4 (3) | 1HR FOR M CLAS C SEP. EXCEPTION 1 EXIT ALLOWED, SEPARATE MGM'T | PAI | RAPETS |

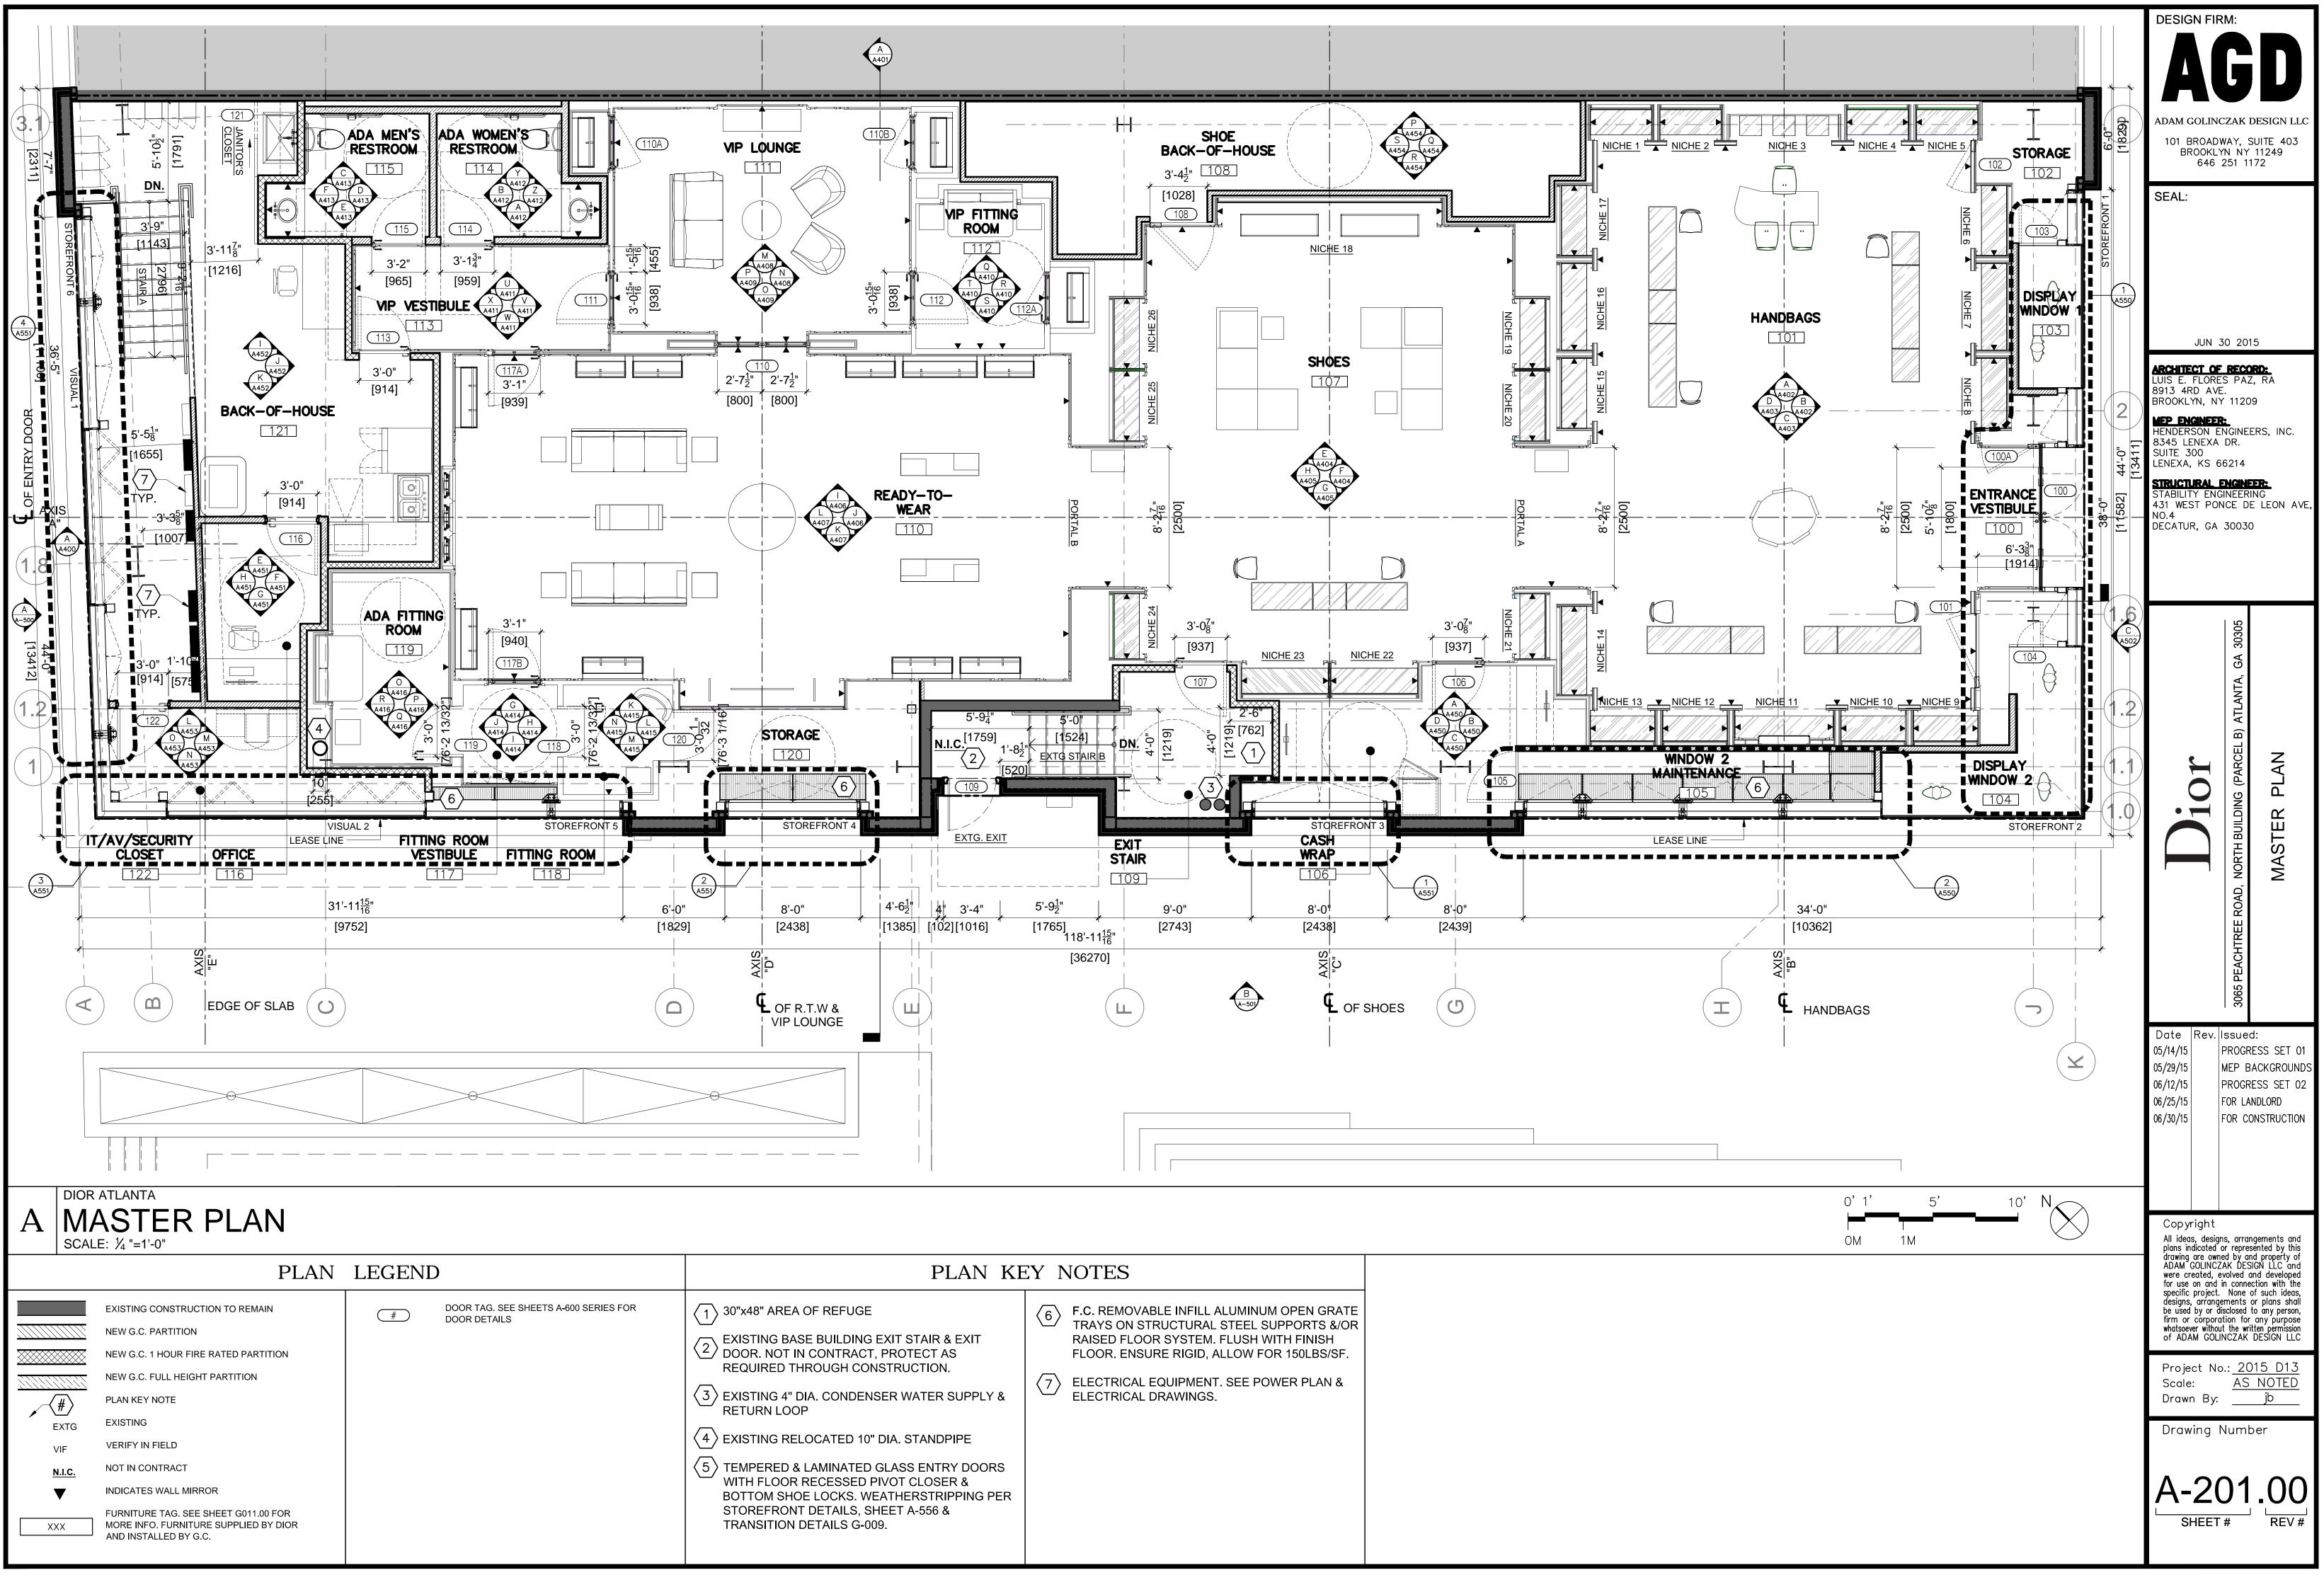

| 3" AREA OF REFUGE 4" DIA CONTRACT, PROTECT AS IRED THROUGH CONSTRUCTION. 4" DIA. CONDENSER WATER SUPPLY & RN LOOP 3" ING RELOCATED 10" DIA. STANDPIPE 5" ERED & LAMINATED GLASS ENTRY DOORS FLOOR RECESSED PIVOT CLOSER & OM SHOE LOCKS. WEATHERSTRIPPING PER EFRONT DETAILS, SHEET A-556 & SITION DETAILS G-009. 6 F.C. REMOVABLE INFILL ALUMINUM OPEN GRATE TRAYS ON STRUCTURAL STEEL SUPPORTS &/OR RAISED FLOOR SYSTEM. FLUSH WITH FINISH FLOOR. ENSURE RIGID, ALLOW FOR 150LBS/SF. 7 ELECTRICAL EQUIPMENT. SEE POWER PLAN & ELECTRICAL DRAWINGS. |
|---|




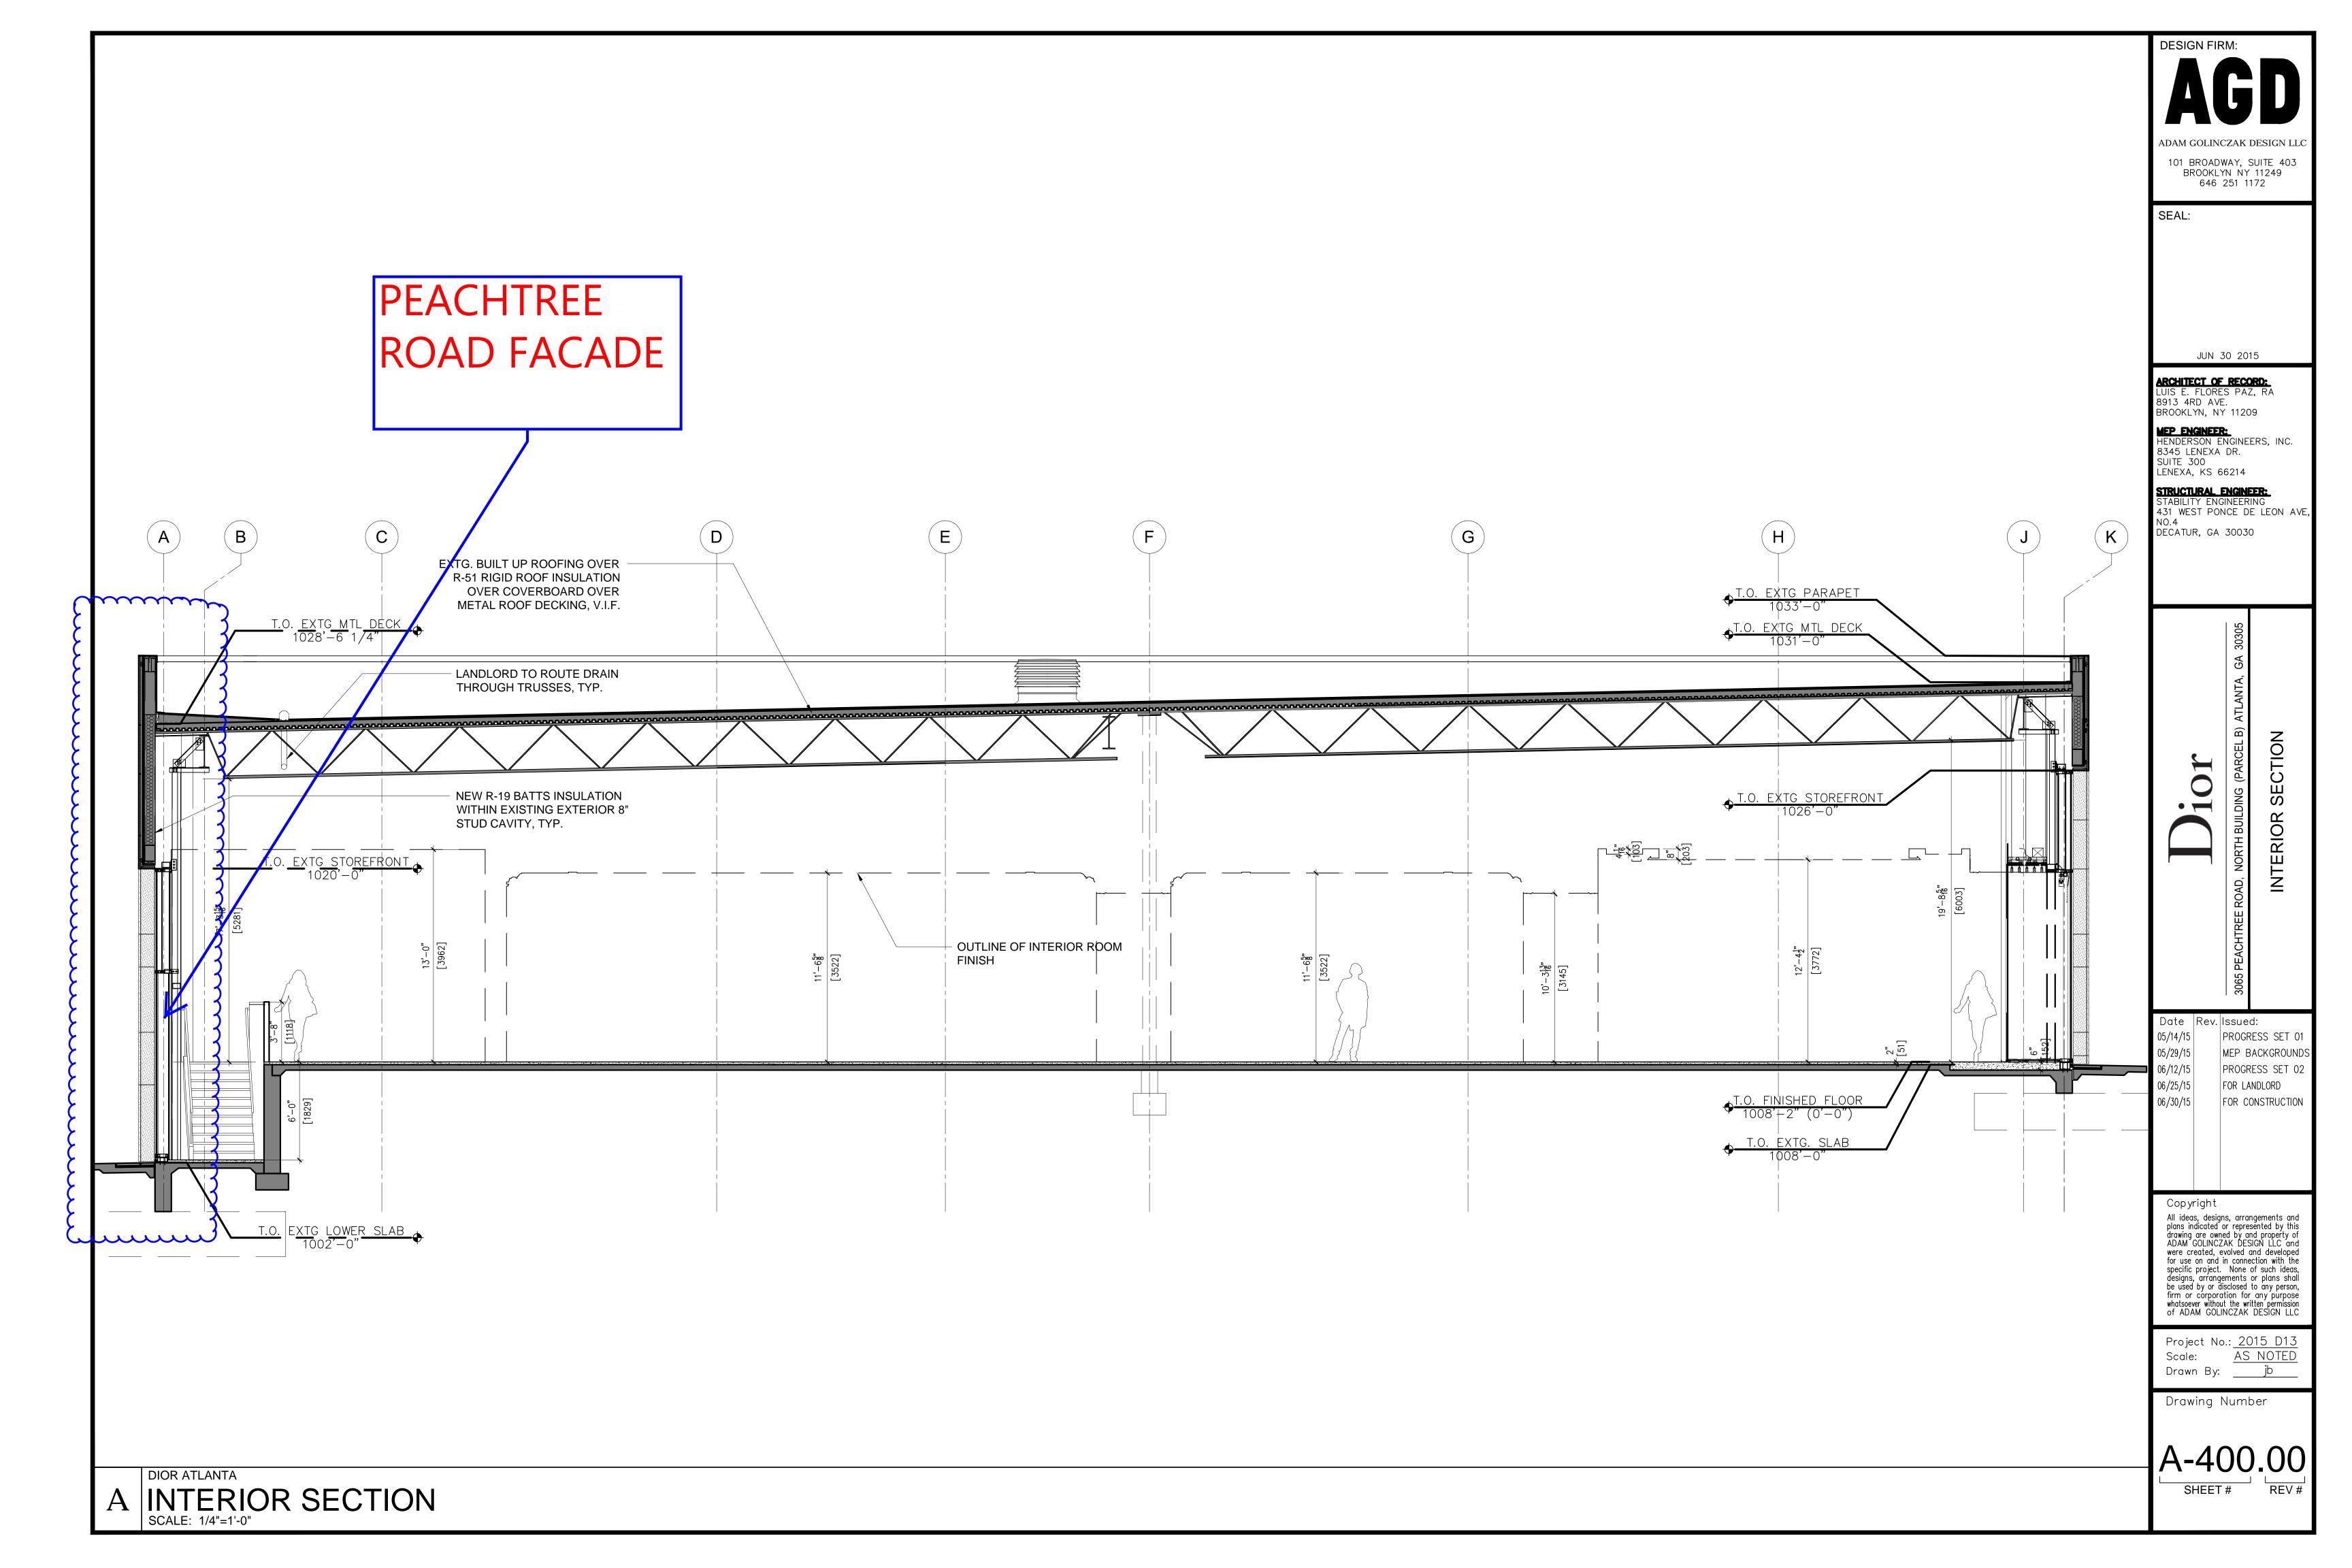

DIOR ATLANTA A INTERIOR SECTION

| | | SUITE 403 11249 | | | | |
|--|--|--|--|--|--|--|
| SEAL: JUN 30 2015 | | | | | | |
| ARCHITECT OF RECORD: LUIS E. FLORES PAZ, RA 8913 4RD AVE. BROOKLYN, NY 11209 MEP ENGINEER: HENDERSON ENGINEERS, INC. 8345 LENEXA DR. SUITE 300 LENEXA, KS 66214 STRUCTURAL ENGINEERING 431 WEST PONCE DE LEON AVE, NO.4 DECATUR, GA 30030 | | | | | | |
| Dior | 3065 PEACHTREE ROAD, NORTH BUILDING (PARCEL B) ATLANTA, GA 30305 | INTERIOR SECTION | | | | |
| Date Rev. 05/14/15 05/29/15 06/12/15 06/25/15 06/30/15 | MEP E PROGF FOR LA | d: RESS SET 01 BACKGROUNDS RESS SET 02 NDLORD ONSTRUCTION | | | | |
| Cop yright All ideas, designs, arrangements and plans indicated or represented by this drawing are owned by and property of ADAM GOLINCZAK DESIGN LLC and were created, evolved and developed for use on and in connection with the specific project. None of such ideas, designs, arrangements or plans shall be used by or disclosed to any person, firm or corporation for any purpose whatsoever without the written permission of ADAM GOLINCZAK DESIGN LLC | | | | | | |
| Project N Scale: Drawn By: Drawing | AS | NOTED jb | | | | |
| A-4 | | .00 REV # | | | | |


A EXTERIOR WEST ELEVATION SCALE: 1/4"=1'-0"

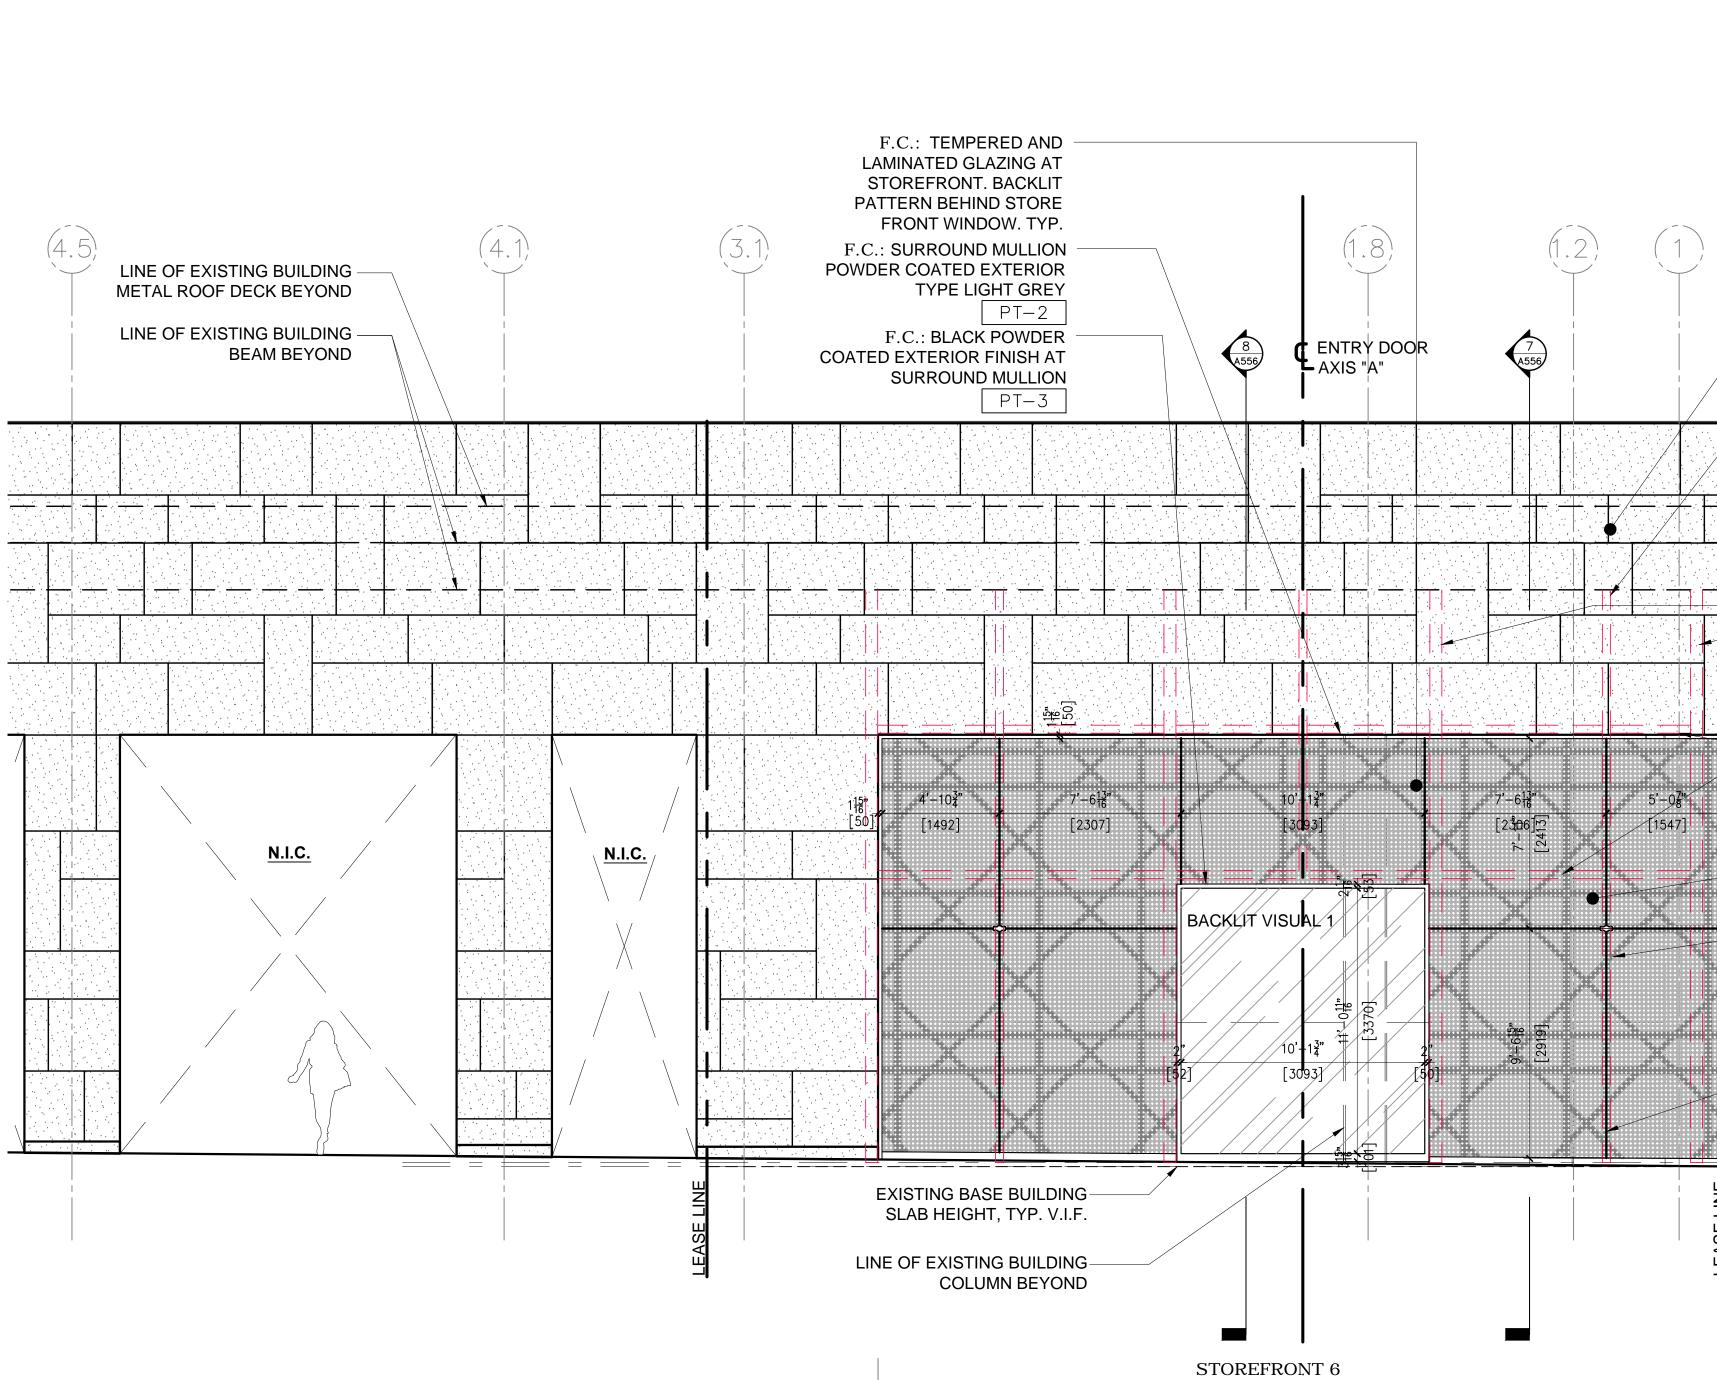


PEACHTREE ROAD ELEVATION.

FINAL DIMENSIONS OF THE NAGOYA GLASS TO BE CONFIRMED VIA SHOP DRAWINGS <u>BY FACADE</u> <u>CONTRACTOR</u> AS PER DIOR APPROVED CONCEPT.

| | DESIGN FIRM: |
|--|---|
| F.C. NOTE: 1. COMPLETE FACADE STOREFRONT SYSTEM TO BE | AGD |
| SUBMITTED AS "ENGINEERED & CERTIFIED PREFAB CURTAIN WALL SYSTEM" - NOT PART OF FIRE RATED ASSEMBLY, BY FACADE CONSULTANT. | ADAM GOLINCZAK DESIGN LLC |
| 2. FACADE MANUFACTURER IS RESPONSIBLE FOR | 101 BROADWAY, SUITE 403 BROOKLYN NY 11249 646 251 1172 |
| CERTIFICATION OF ENTIRE SYSTEM AND STRUCTURAL CALCULATIONS FOR DEFLECTION CRITERIA AND WIND LOADS AS PER APPLICABLE STATE OF | SEAL: |
| GEORGIA & ATLANTA BUILDING CODES. | |
| 3. ALL DRAWINGS AND RELATED DETAILS MUST BE SIGNED & SEALED BY STRUCTURAL ENGINEER LICENSED IN THE STATE OF GEORGIA. | |
| 4. CLEAR INTERLAYER SOLAR FILM TO BE PROVIDED BY F.C. PROVIDE GLASS SAMPLE FOR APPROVAL. | |
| | JUN 30 2015 |
| N.I.C.: EXISTING BASE BUILDING | ARCHITECT OF RECORD: LUIS E. FLORES PAZ, RA 8913 4RD AVE. |
| EXTERIOR FINISH TO BE PROTECTED THROUGHOUT CONSTRUCTION. | BROOKLYN, NY 11209 M ep Engineer: Henderson Engineers, Inc. |
| $$ G.C.: STEEL 4" X 4" X $\frac{1}{2}$ " H.S.S. FULL HEIGHT | 8345 LENEXA DR. SUITE 300 LENEXA, KS 66214 |
| SUPPORT BEHIND STOREFRONT GLAZING TYPICAL. CONNECT TO EXTG. BUILDING BEAMS. SEE STRUCTURAL DRAWINGS FOR | STRUCTURAL ENGINEER: STABILITY ENGINEERING 431 WEST PONCE DE LEON AVE |
| FURTHER INFORMATION. | NO.4 DECATUR, GA 30030 |
| T.O. PARAPET 1033'-0" | |
| | |
| | A 30305 |
| G.C.: STEEL 6" X 4" X ¹ / ₂ " H.S.S. FULL HEIGHT | NTA, GA |
| AT ENDS OF STOREFRONTS. CONNECT TO EXTG. BUILDING STRUCTURE. SEE STRUCTURAL DRAWINGS FOR FURTHER | B) ATLANTA, NS |
| INFORMATION, TYP. |)1 (PARCEL E (ATIO |
| $\begin{array}{c c} \hline \hline$ | |
| T ^[305] EXTG. T → T → T → T → T → T → T → T → T → T → | |
| FACADE SHOP DRAWINGS BACKLIT PATTERN BEHIND STOREFRONT | ROAD, NORTH EXTERIO |
| WINDOWS. TYP. F.C.: TYPICAL "CLIP" STRUCTURAL | E ROAD, E X TE |
| CONNECTION DETAIL. MANUFACTURER TO CONFIRM FINAL CLIP LOCATION, TYP. | PEACHTREE |
| | 3065 PEA |
| F.C.: MINIMUM JOINT BETWEEN GLASS, TYP. CLEAR STRUCTURAL SILICONE. MANUFACTURER TO SPECIFY. | Date Rev. Issued: |
| | 05/14/15 PROGRESS SET 01 05/29/15 MEP BACKGROUND |
| $\frac{1}{2} = \frac{1}{2} = \frac{1}$ | 06/12/15 PROGRESS SET 02 06/25/15 FOR LANDLORD |
| | 06/30/15 FOR CONSTRUCTION |
| | |
| | Copyright |
| | All ideas, designs, arrangements and plans indicated or represented by this drawing are owned by and property of ADAM GOLINCZAK DESIGN LLC and |
| | were created, evolved and developed for use on and in connection with the specific project. None of such ideas, designs, arrangements or plans shall |
| | be used by or disclosed to any person, firm or corporation for any purpose whatsoever without the written permission of ADAM GOLINCZAK DESIGN LLC |
| | Project No.: <u>2015 D13</u> Scale: AS NOTED |
| | Drawn By: jb |
| | Drawing Number |
| | A-500.00 |
| | SHEET # REV # |
| | |

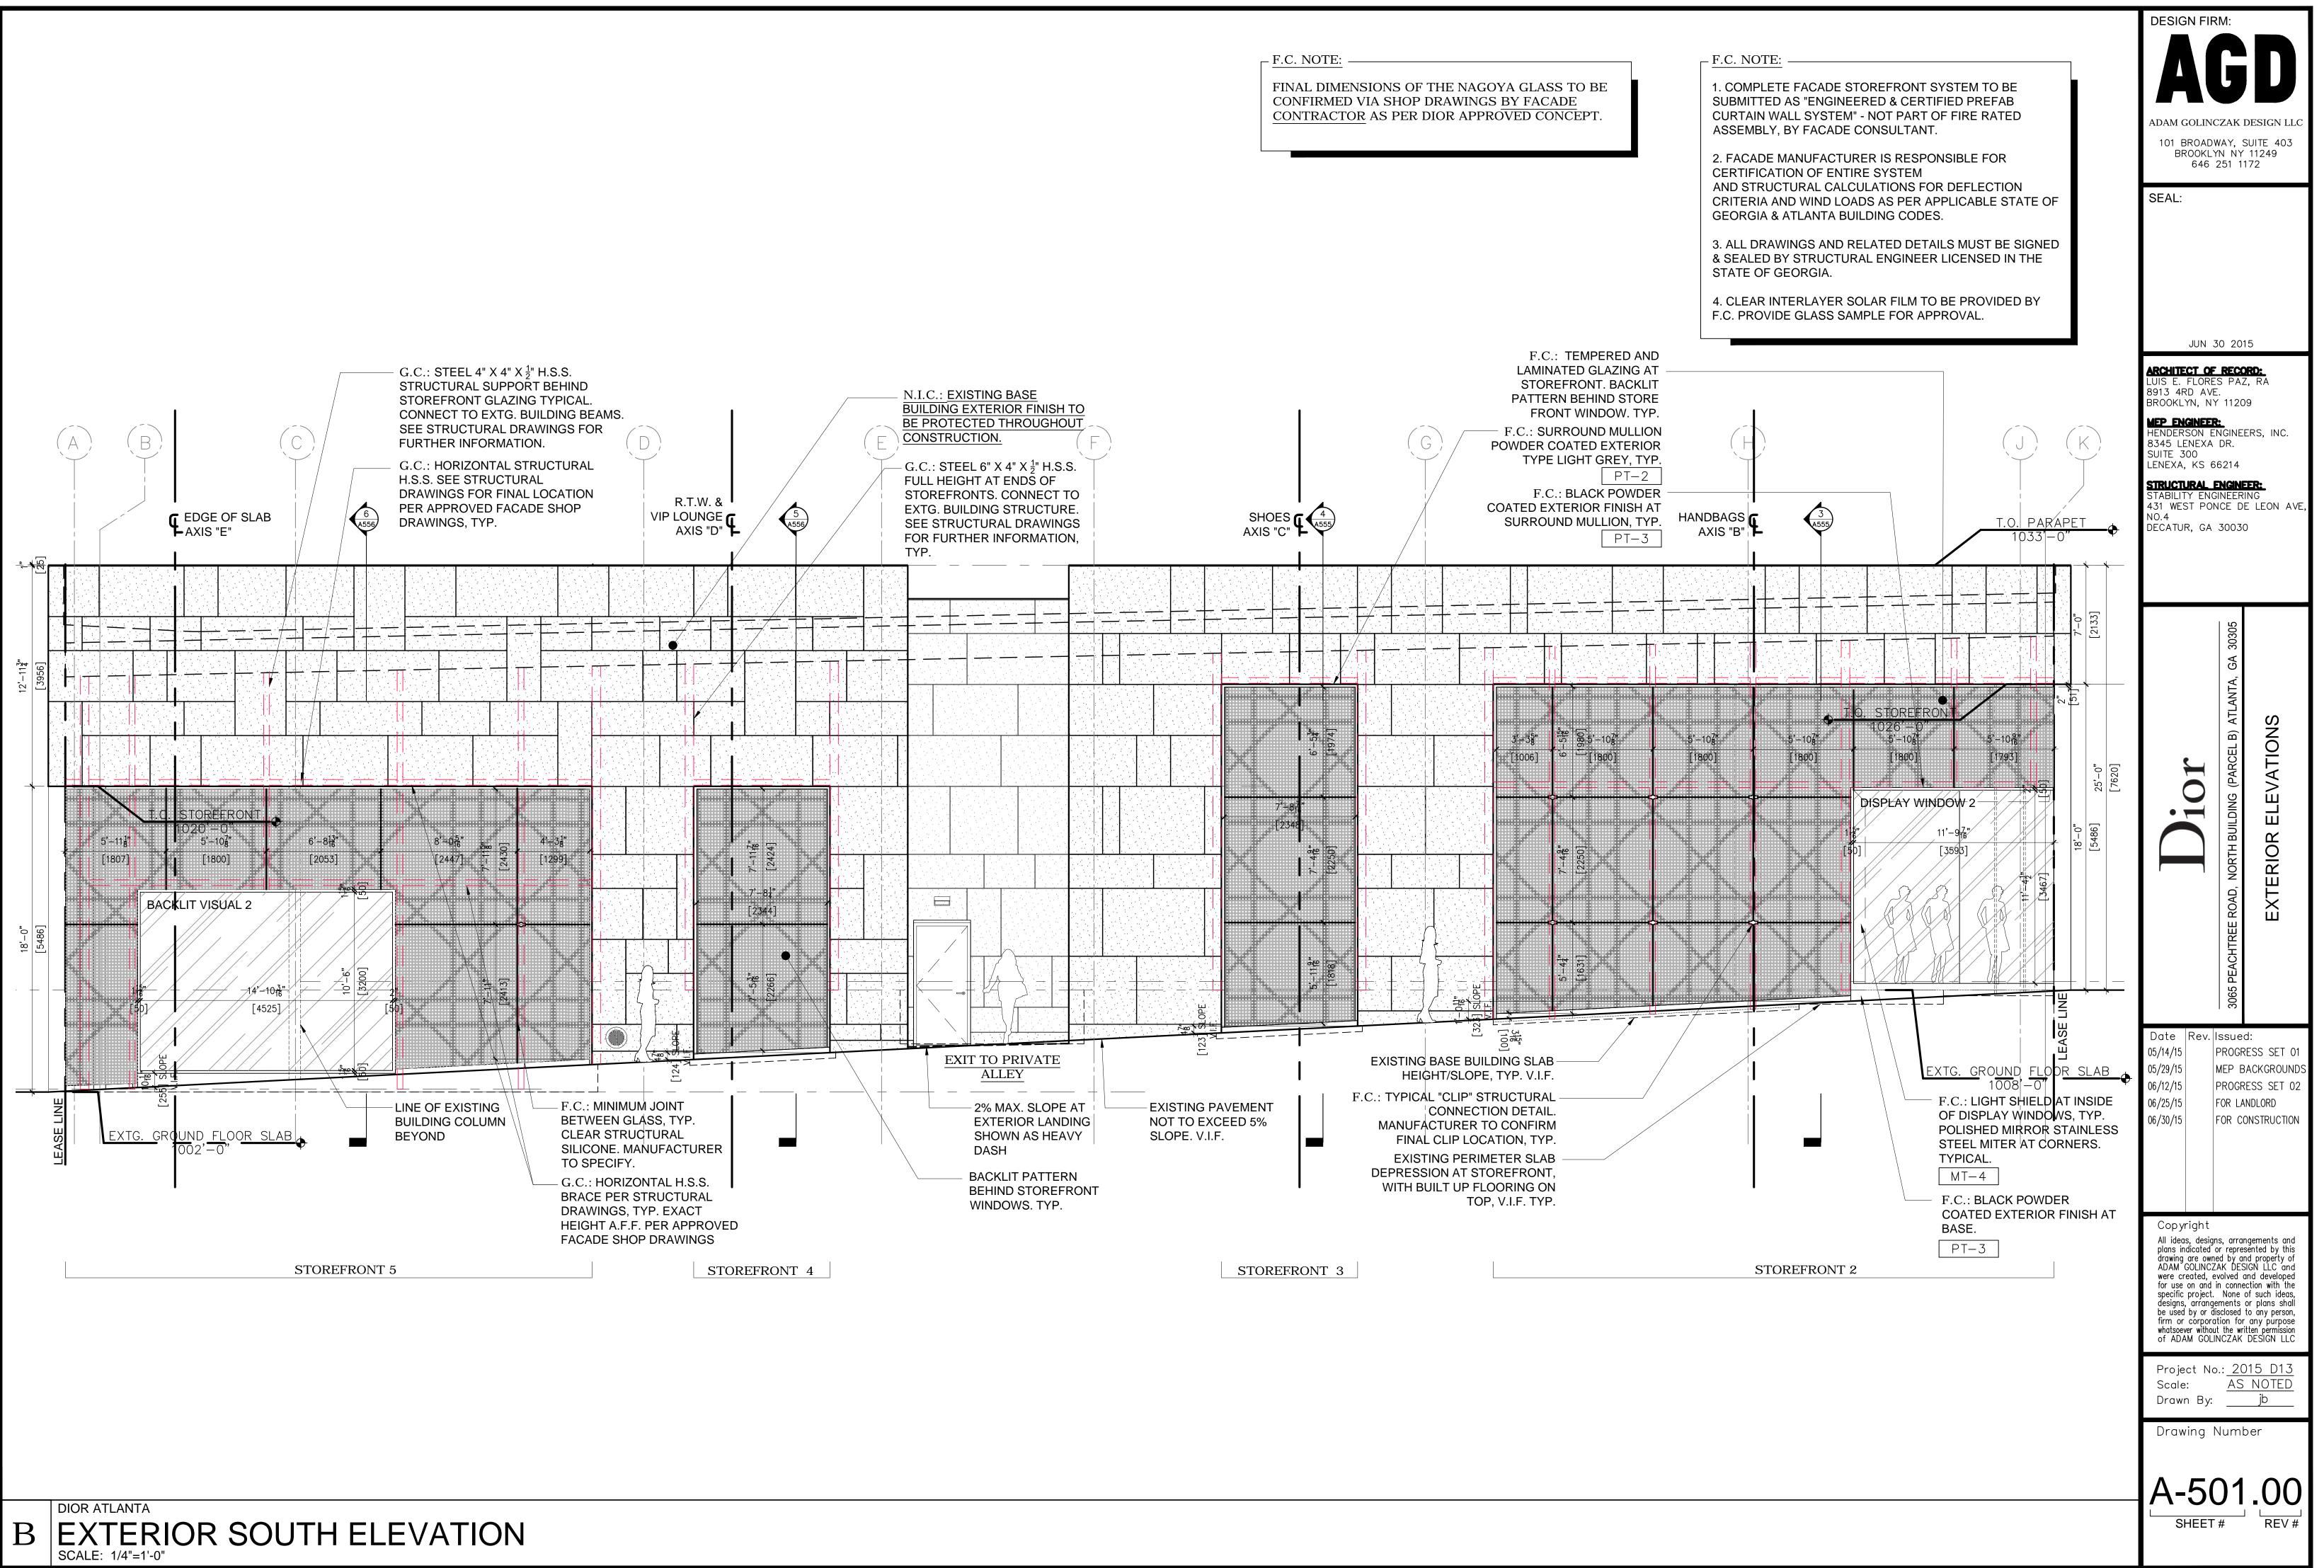

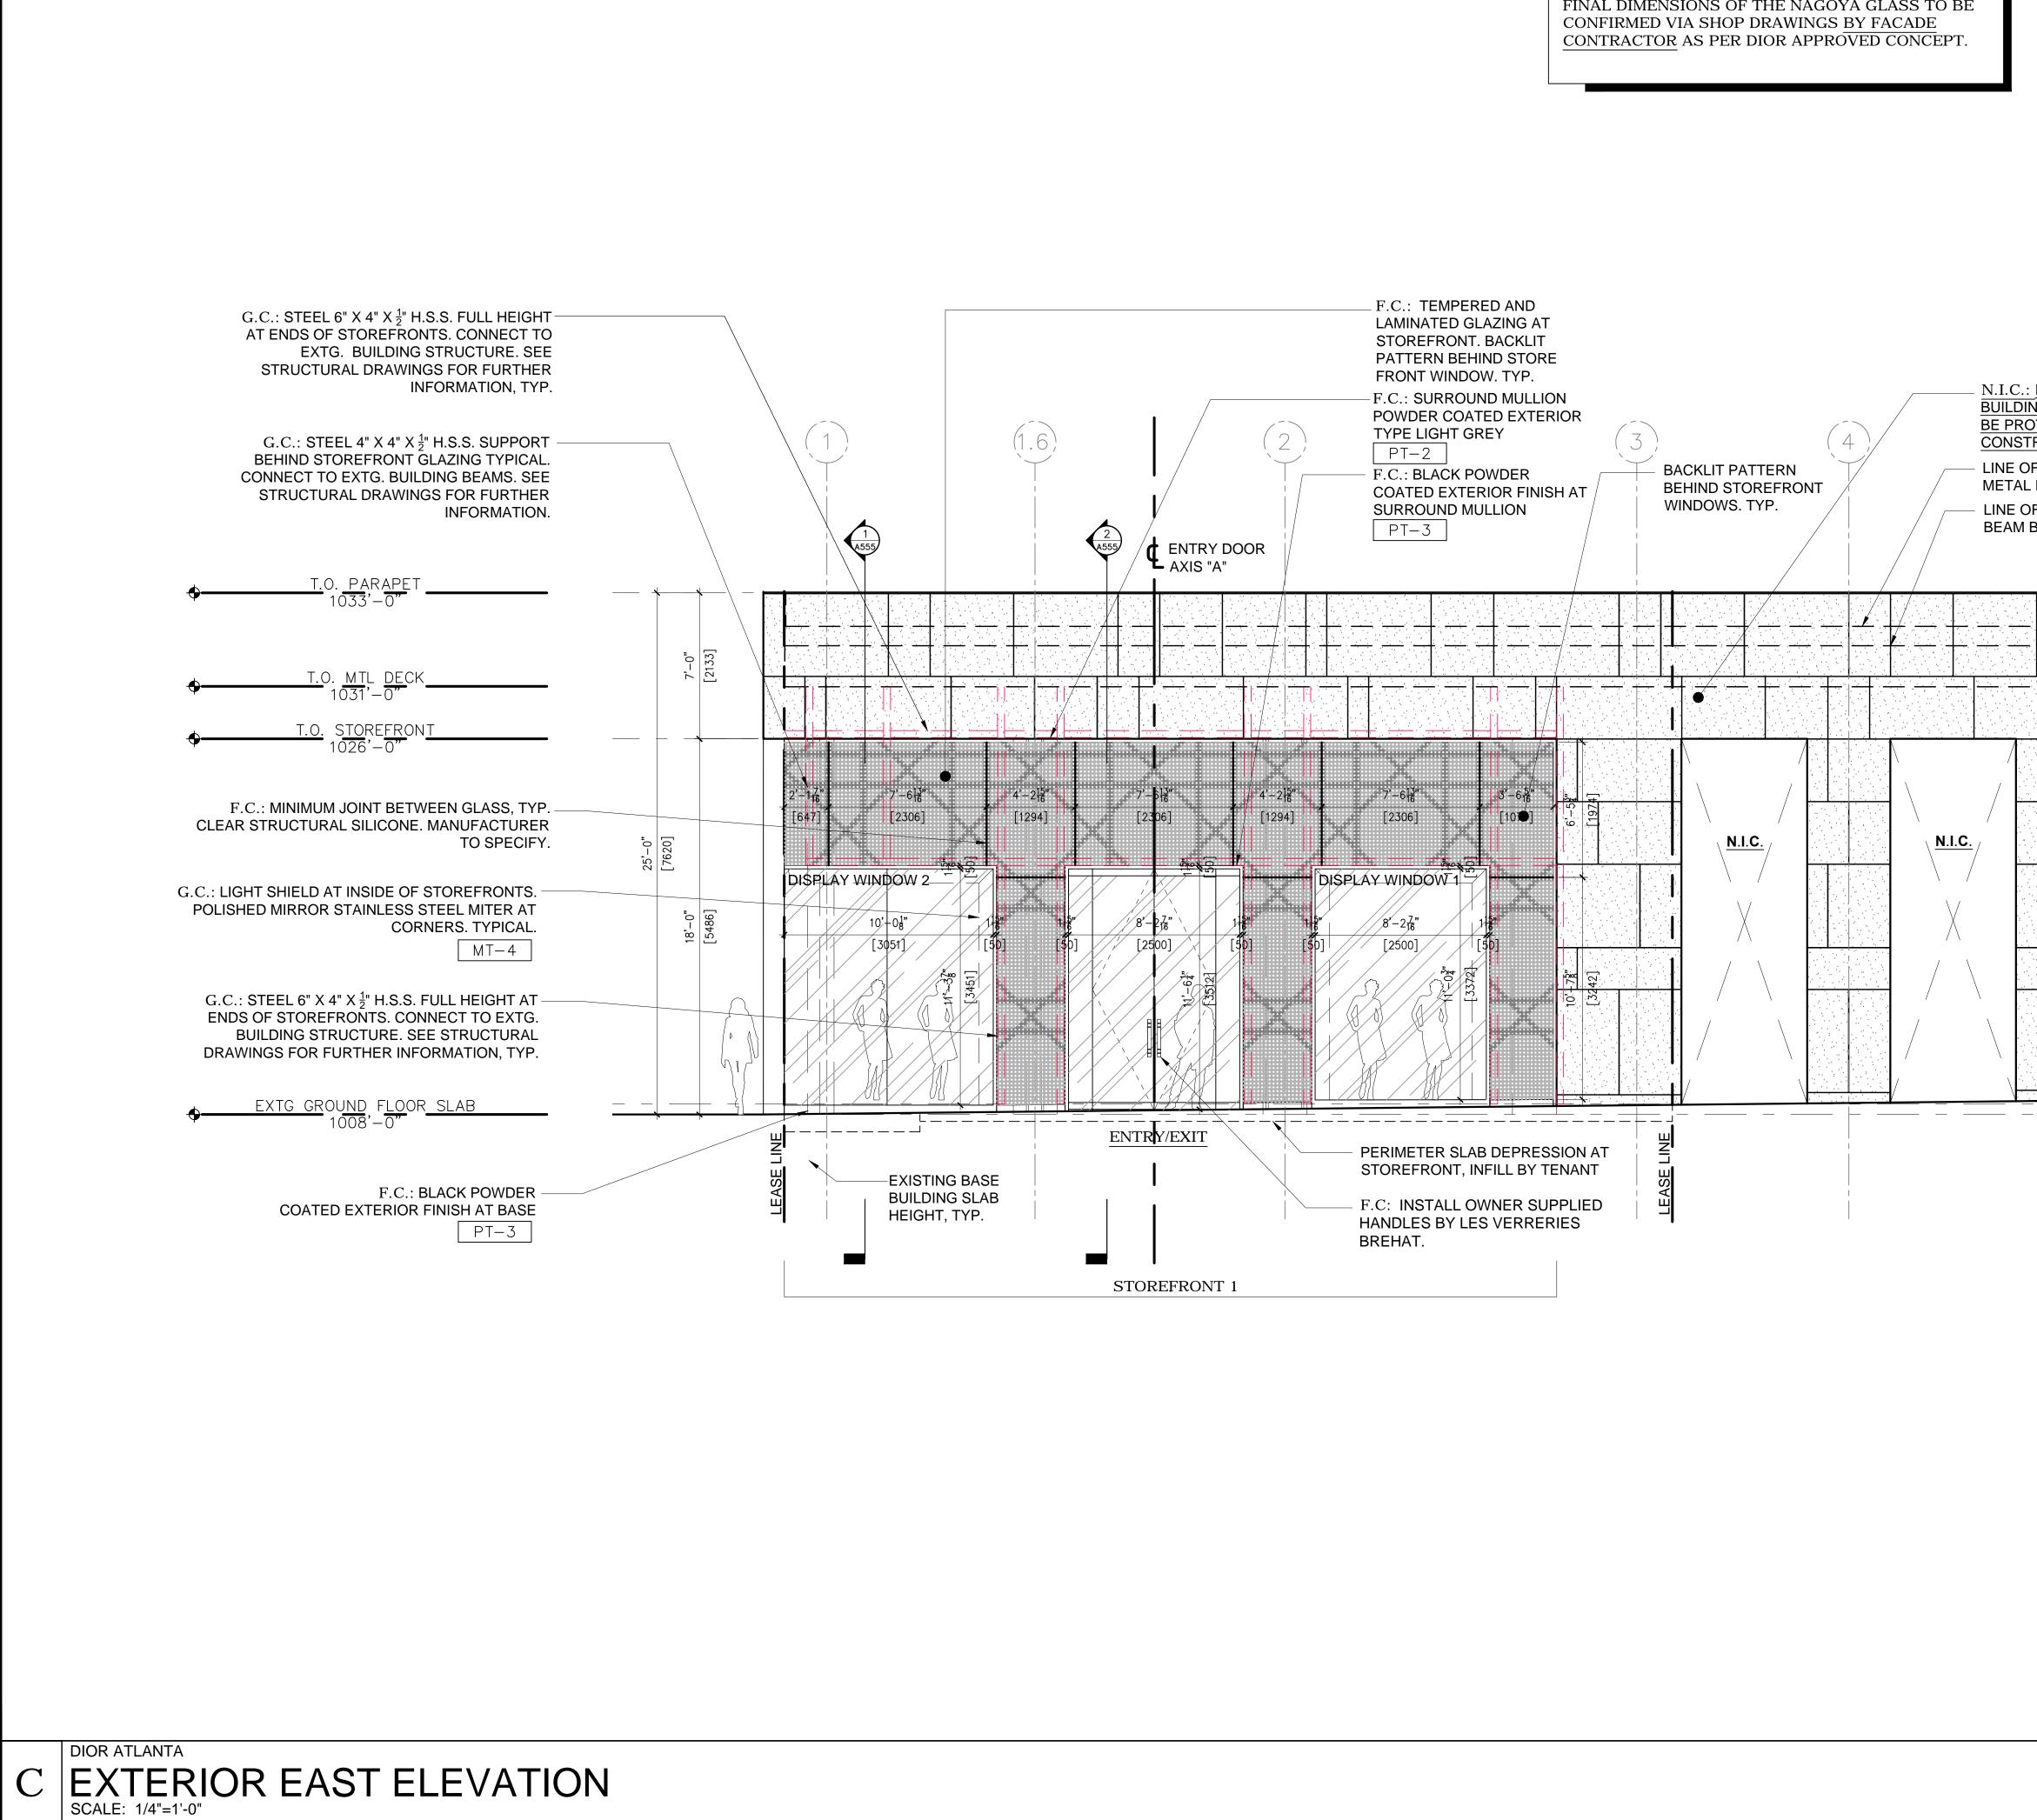

FINAL DIMENSIONS OF THE NAGOYA GLASS TO BE

F.C. NOTE: -

1. COMPLETE FACADE STOREFRONT SYSTEM TO BE SUBMITTED AS "ENGINEERED & CERTIFIED PREFAB CURTAIN WALL SYSTEM" - NOT PART OF FIRE RATED ASSEMBLY, BY FACADE CONSULTANT.

2. FACADE MANUFACTURER IS RESPONSIBLE FOR CERTIFICATION OF ENTIRE SYSTEM AND STRUCTURAL CALCULATIONS FOR DEFLECTION CRITERIA AND WIND LOADS AS PER APPLICABLE STATE OF GEORGIA & ATLANTA BUILDING CODES.

3. ALL DRAWINGS AND RELATED DETAILS MUST BE SIGNED & SEALED BY STRUCTURAL ENGINEER LICENSED IN THE STATE OF GEORGIA.

4. CLEAR INTERLAYER SOLAR FILM TO BE PROVIDED BY F.C. PROVIDE GLASS SAMPLE FOR APPROVAL.

N.I.C.: EXISTING BASE BUILDING EXTERIOR FINISH TO **BE PROTECTED THROUGHOUT** CONSTRUCTION.

LINE OF EXISTING BUILDING METAL ROOF DECK BEYOND - LINE OF EXISTING BUILDING BEAM BEYOND

| <u>.</u> | <u>N.I.C.</u> |
|----------|---------------|
| | |

| DESIGN FIR | G | DESIGN LLC | | | | | |
|---|---|--|--|--|--|--|--|
| 101 BROAD BROOKLY | ADAM GOLINCZAK DESIGN LLC 101 BROADWAY, SUITE 403 BROOKLYN NY 11249 646 251 1172 SEAL: | | | | | | |
| JUN 3 | 30 20 | 15 | | | | | |
| LUIS E. FLORE 8913 4RD AVE BROOKLYN, NY MEP ENGINEER HENDERSON E 8345 LENEXA SUITE 300 LENEXA, KS 6 STRUCTURAL E STABILITY ENG 431 WEST PON NO.4 | ARCHITECT OF RECORD: LUIS E. FLORES PAZ, RA 8913 4RD AVE. BROOKLYN, NY 11209 MEP ENGINEER: HENDERSON ENGINEERS, INC. 8345 LENEXA DR. SUITE 300 LENEXA, KS 66214 STRUCTURAL ENGINEER: STABILITY ENGINEERING 431 WEST PONCE DE LEON AVE, | | | | | | |
| Dior | 3065 PEACHTREE ROAD, NORTH BUILDING (PARCEL B) ATLANTA, GA 30305 | EXTERIOR ELEVATIONS | | | | | |
| 05/14/15 05/29/15 06/12/15 06/25/15 06/30/15 | MEP E PROGF FOR LA | d: RESS SET 01 RACKGROUNDS RESS SET 02 NDLORD ONSTRUCTION | | | | | |
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| Project No Scale: Drawn By: | AS | | | | | | |
| Drawing N A-5(|)2 | | | | | | |

FACADE CONTRACTOR NOTE

1. SEE STRUCTURAL DRAWINGS FOR FURTHER INFORMATION, SIZES, AND SPECIFICATIONS.

2. COMPLETE AND ALL INCLUSIVE STOREFRONT SYSTEM BY FACADE CONTRACTOR. FABRICATE, FIELD VERIFY, AND INSTALL. STOREFRONT SYSTEM ASSEMBLY AND INDIVIDUAL STRUCTURAL COMPONENTS REQUIRE STRUCTURAL CERTIFICATION BY U.S. LICENSED STRUCTURAL ENGINEER, PER APPLICABLE STATE OF GEORGIA BUILDING CODES. TYPICAL.

